




**1** TYPICAL SECTION VIEW  
3" = 1'-0"

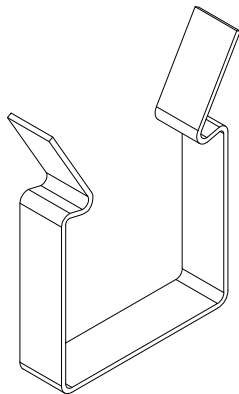


**2** NOTCHED BACKER CLIP  
1" = 1'-0"

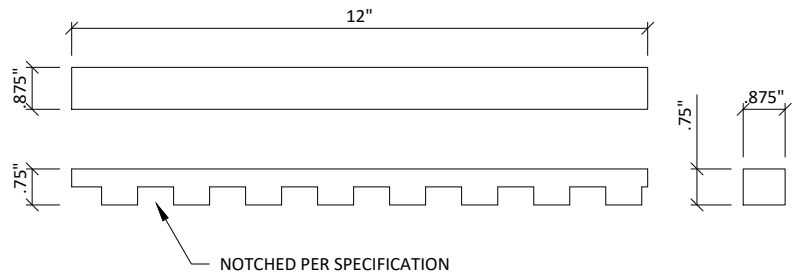

**3** NOTCHED BACKER  
3" = 1'-0"

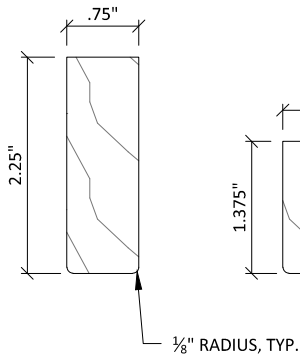

SOLID WOOD RAIL

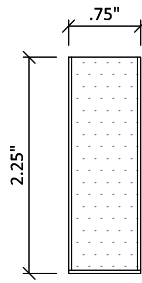


VENEERED RAIL


CUSTOM PROFILES AVAILABLE UPON REQUEST

## 1 TYPICAL RAIL PROFILES


6" = 1'-0"

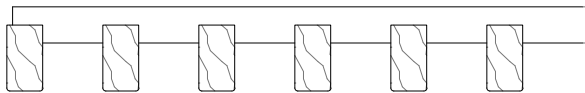


3/4" X 1 3/8" RAILS  
6 RAIL/FT.  
2" SPACING O.C.

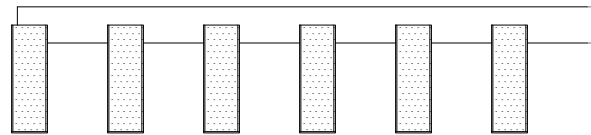

3/4" X 2 1/4" RAILS  
6 RAIL/FT.  
2" SPACING O.C.

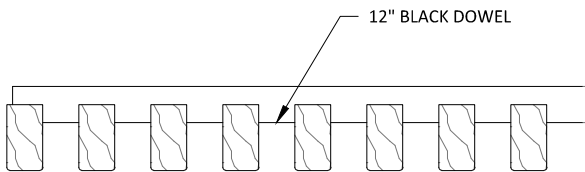

3/4" X 1 3/8" RAILS  
8 RAIL/FT.  
1 1/2" SPACING O.C.

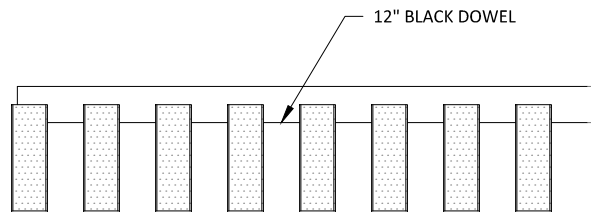

3/4" X 2 1/4" RAILS  
8 RAIL/FT.  
1 1/2" SPACING O.C.

## 2 TYPICAL 12 INCH MODULES

3" = 1'-0"

# GRILLE-NOTCHED SYSTEM - TYPICAL PROFILE OPTIONS


SCALE: AS NOTED

LAST REVISED: 6/29/2023

SHEET NUMBER

2


DRAWN BY: BH

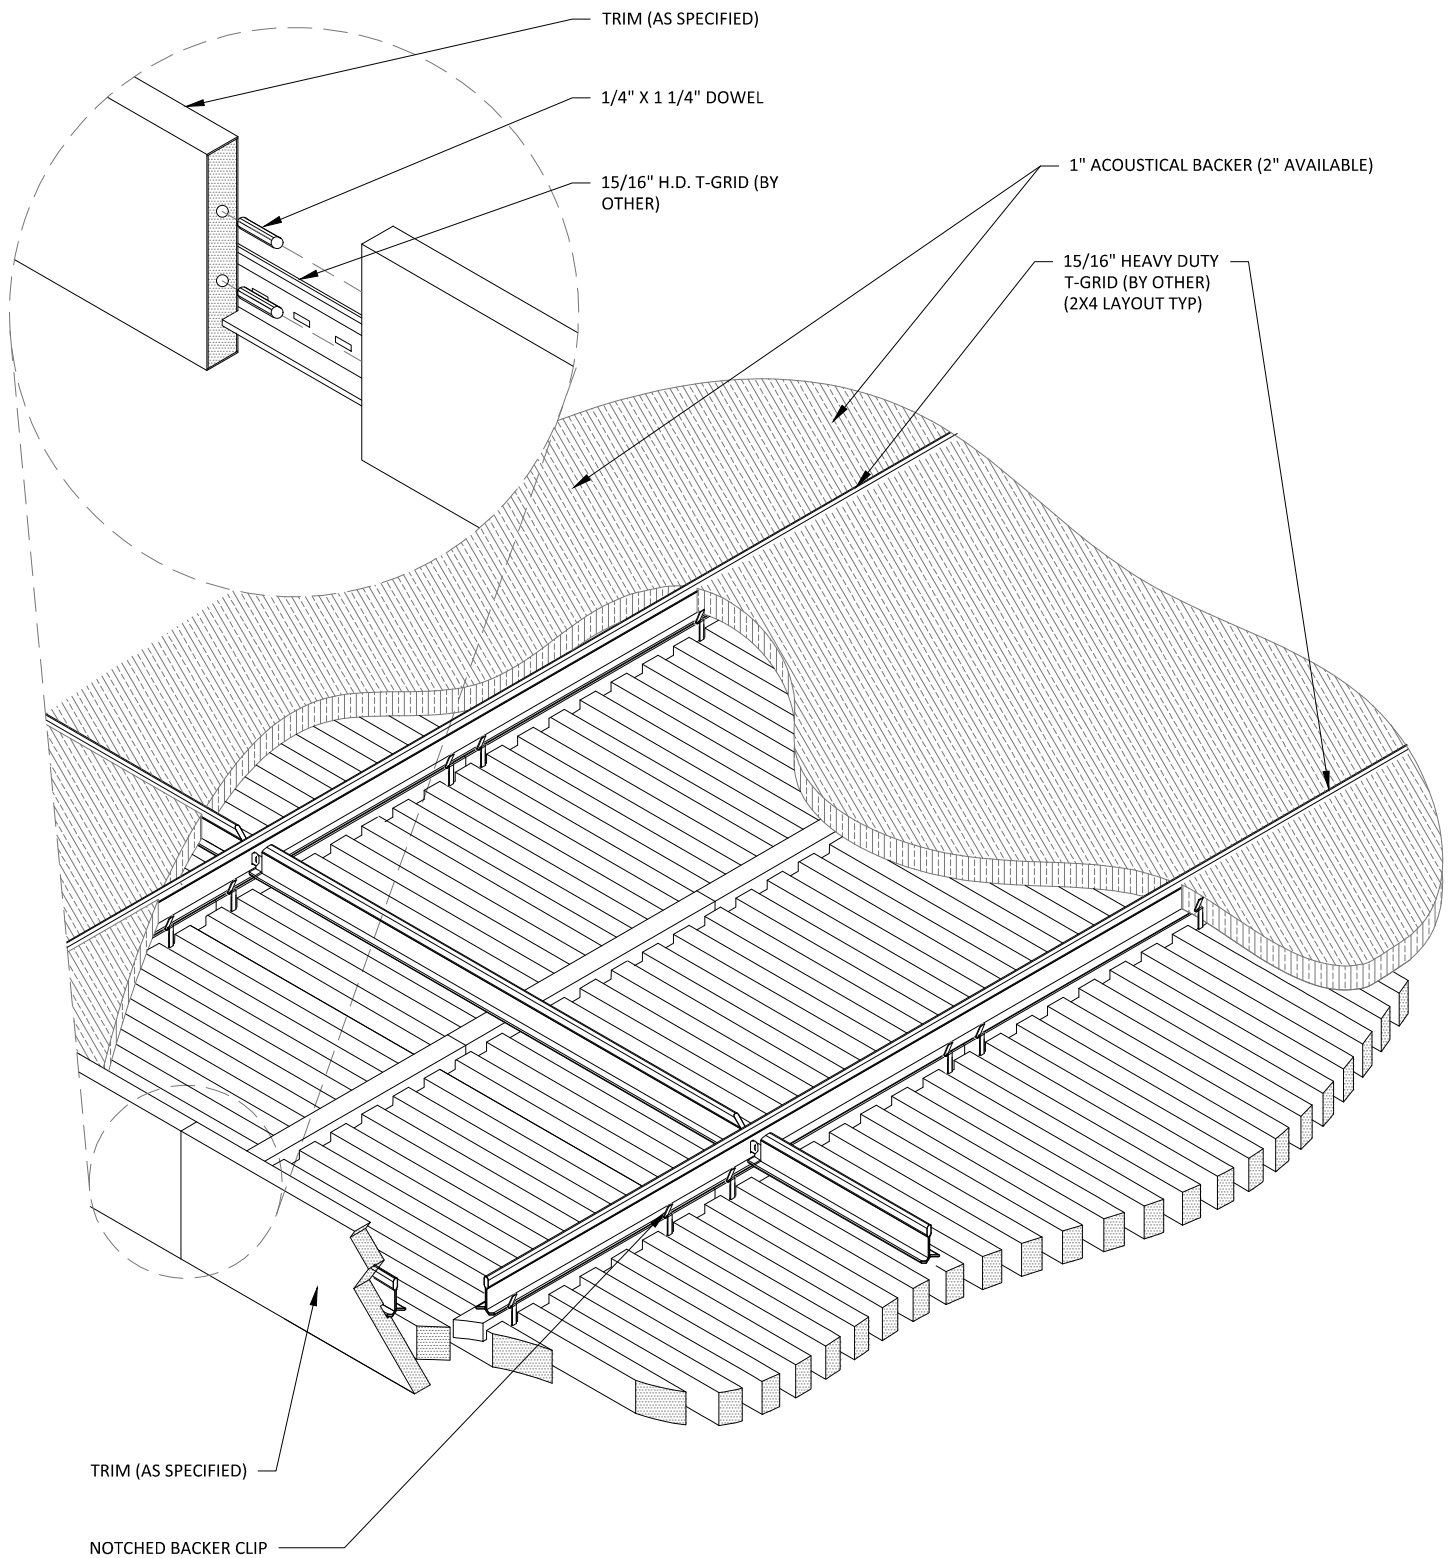


1

CEILING ISOMETRIC - TYP.


1 1/2" = 1'-0"

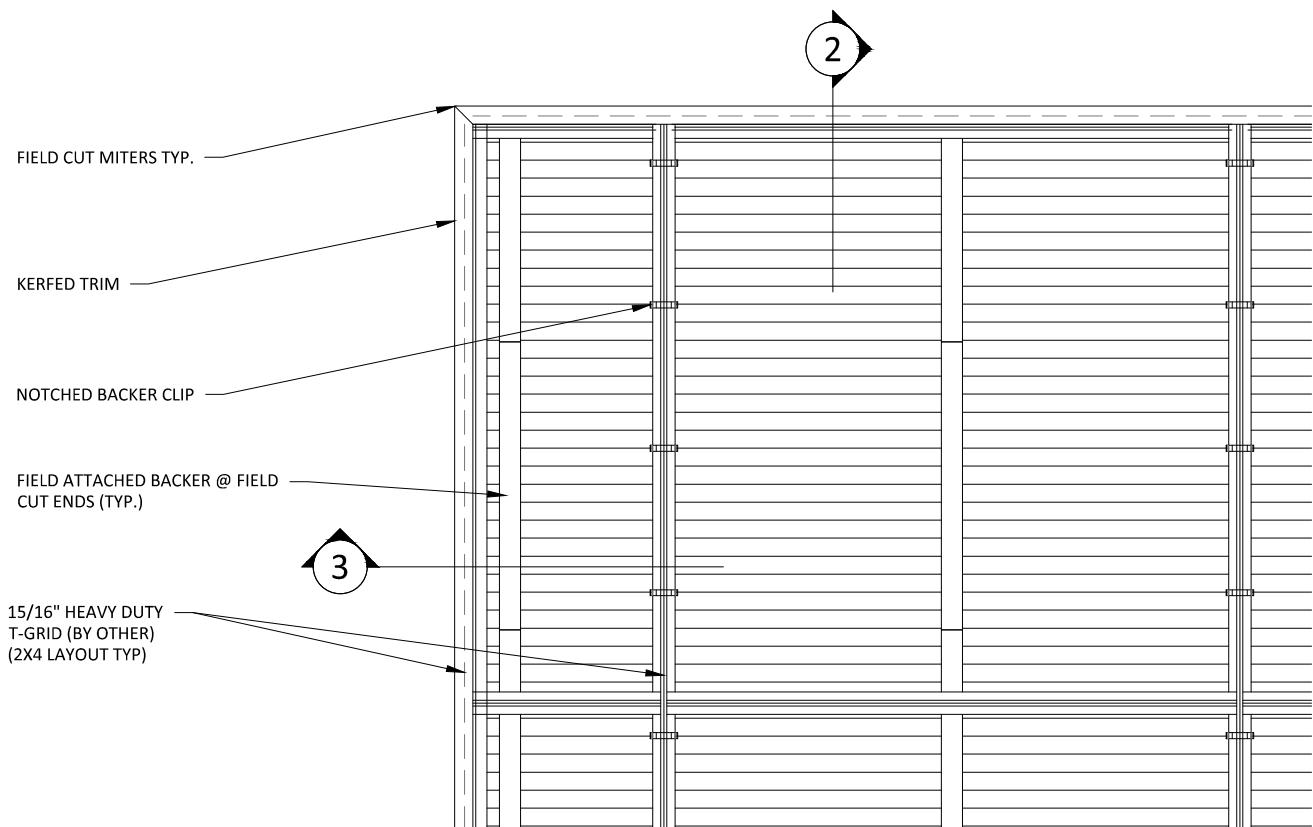


**1** TRIM @ MITERED CORNER - PLAN  
1 1/2" = 1'-0"

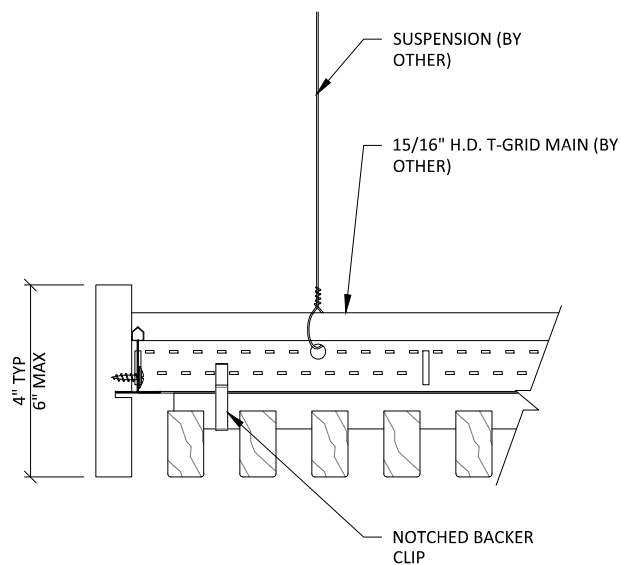


**2** TRIM DETAIL 1  
3" = 1'-0"

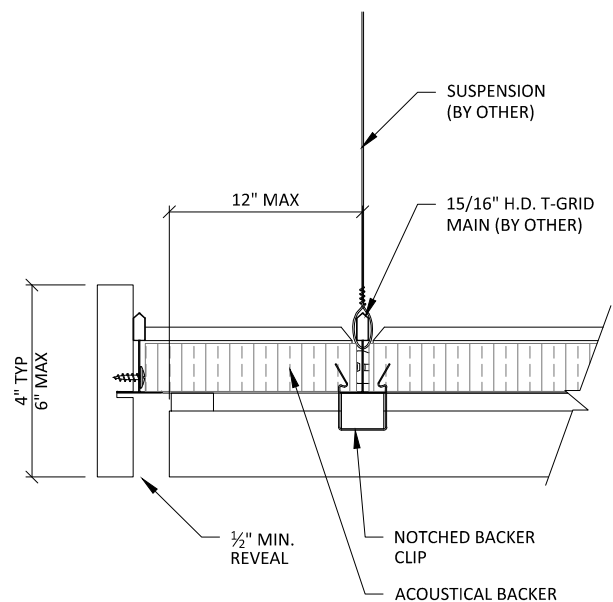


**3** TRIM DETAIL 2  
3" = 1'-0"

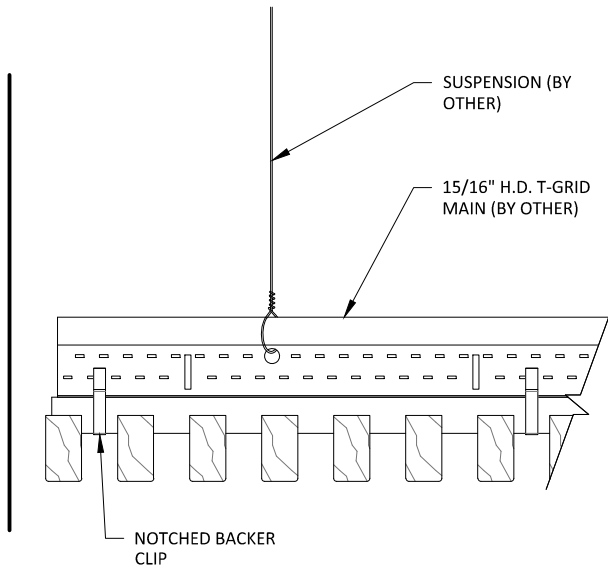


1 EDGE DETAIL 1  
3" = 1'-0"

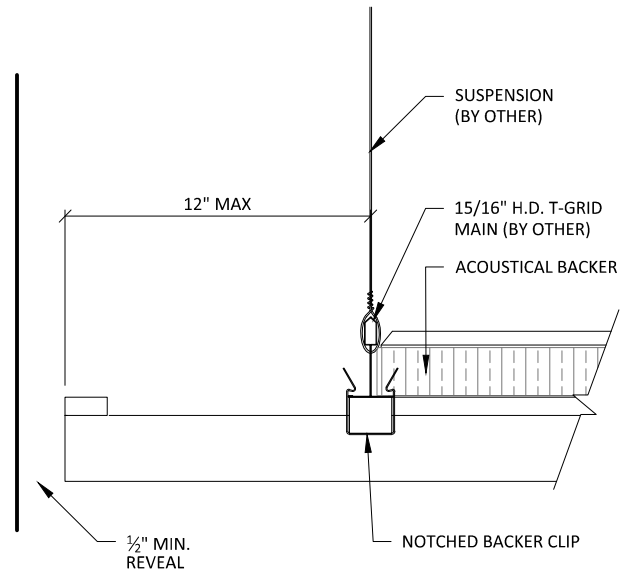


2 EDGE DETAIL 2  
3" = 1'-0"

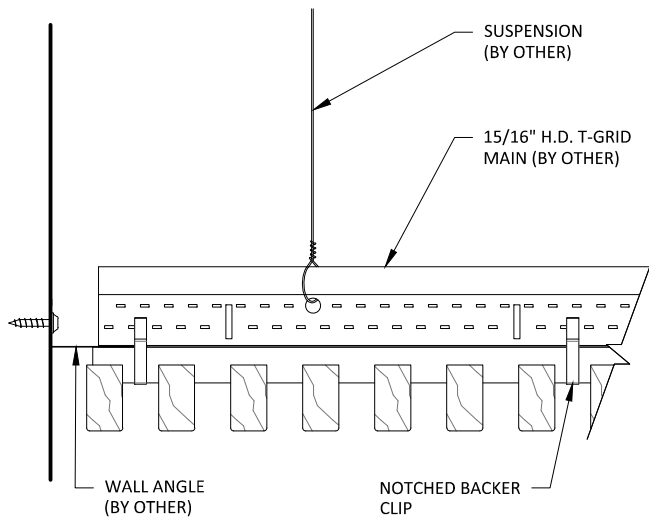


3 EDGE DETAIL 3  
3" = 1'-0"

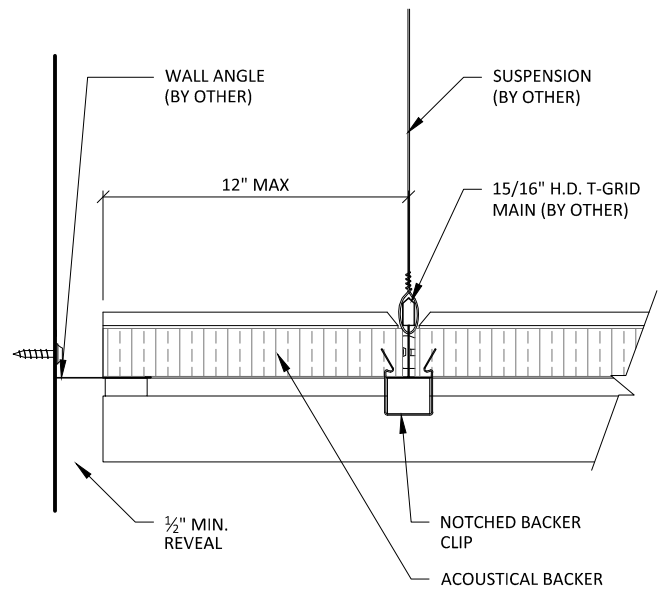

4 EDGE DETAIL 4  
3" = 1'-0"

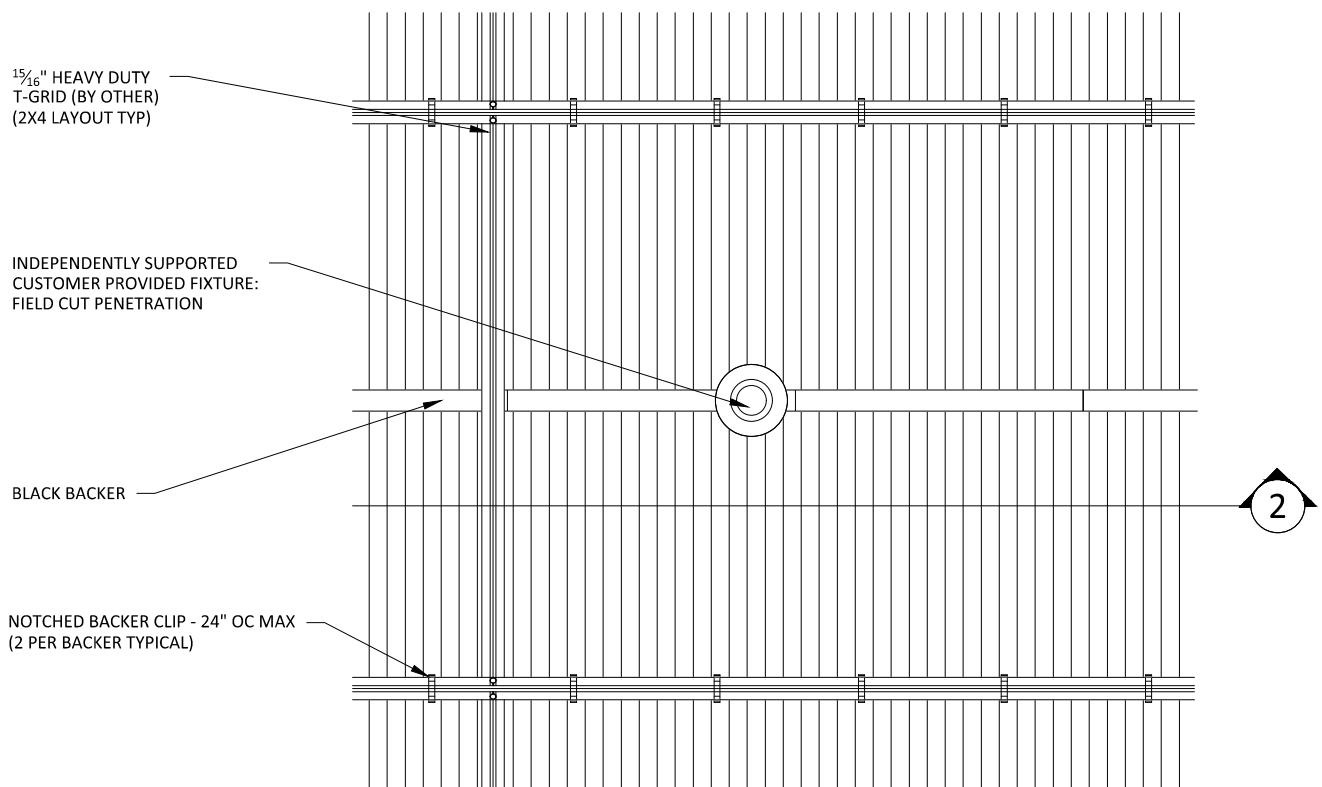

**1** SPRINKLER HEAD DETAIL - PLAN VIEW  
1 1/2" = 1'-0"

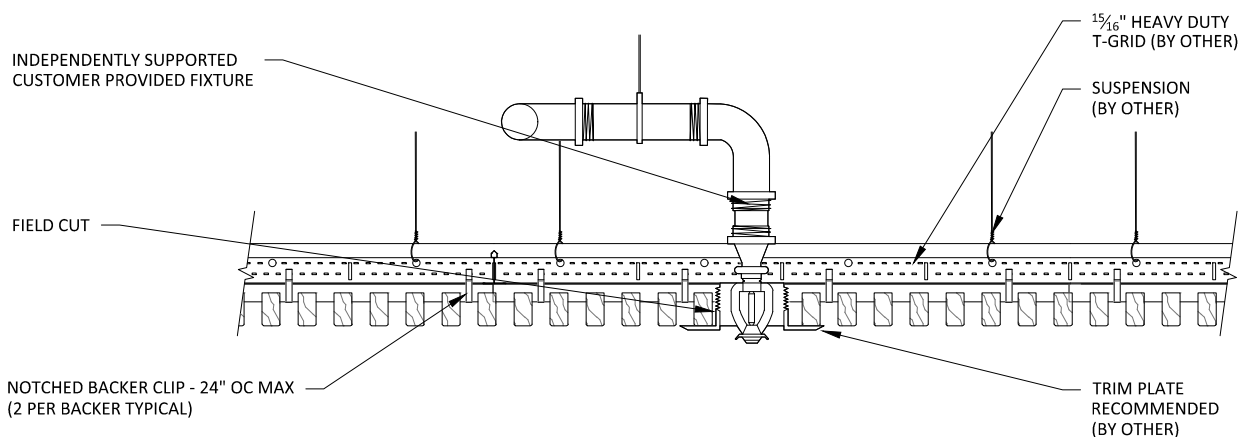

**2** SPRINKLER HEAD DETAIL - SECTION VIEW  
1 1/2" = 1'-0"

15/16" HEAVY DUTY  
T-GRID (BY OTHER)  
(2X4 LAYOUT TYP)

INDEPENDENTLY SUPPORTED  
CUSTOMER PROVIDED FIXTURE:  
FIELD CUT PENETRATION

BLACK BACKER

NOTCHED BACKER CLIP - 24" OC MAX  
(2 PER BACKER TYPICAL)

2

1

## CAN LIGHT DETAIL - PLAN VIEW

1 1/2" = 1'-0"

INDEPENDENTLY SUPPORTED  
CUSTOMER PROVIDED FIXTURE

FIELD CUT

NOTCHED BACKER CLIP - 24" OC MAX  
(2 PER BACKER TYPICAL)

15/16" HEAVY DUTY  
T-GRID (BY OTHER)

SUSPENSION  
(BY OTHER)

TRIM PLATE  
RECOMMENDED  
(BY OTHER)

2

## CAN LIGHT DETAIL - SECTION VIEW

1 1/2" = 1'-0"

# GRILLE-NOTCHED (CEILING SYSTEM) - CAN LIGHT DETAILS


SCALE: AS NOTED

LAST REVISED: 6/29/2023


SHEET NUMBER

7

DRAWN BY: BH

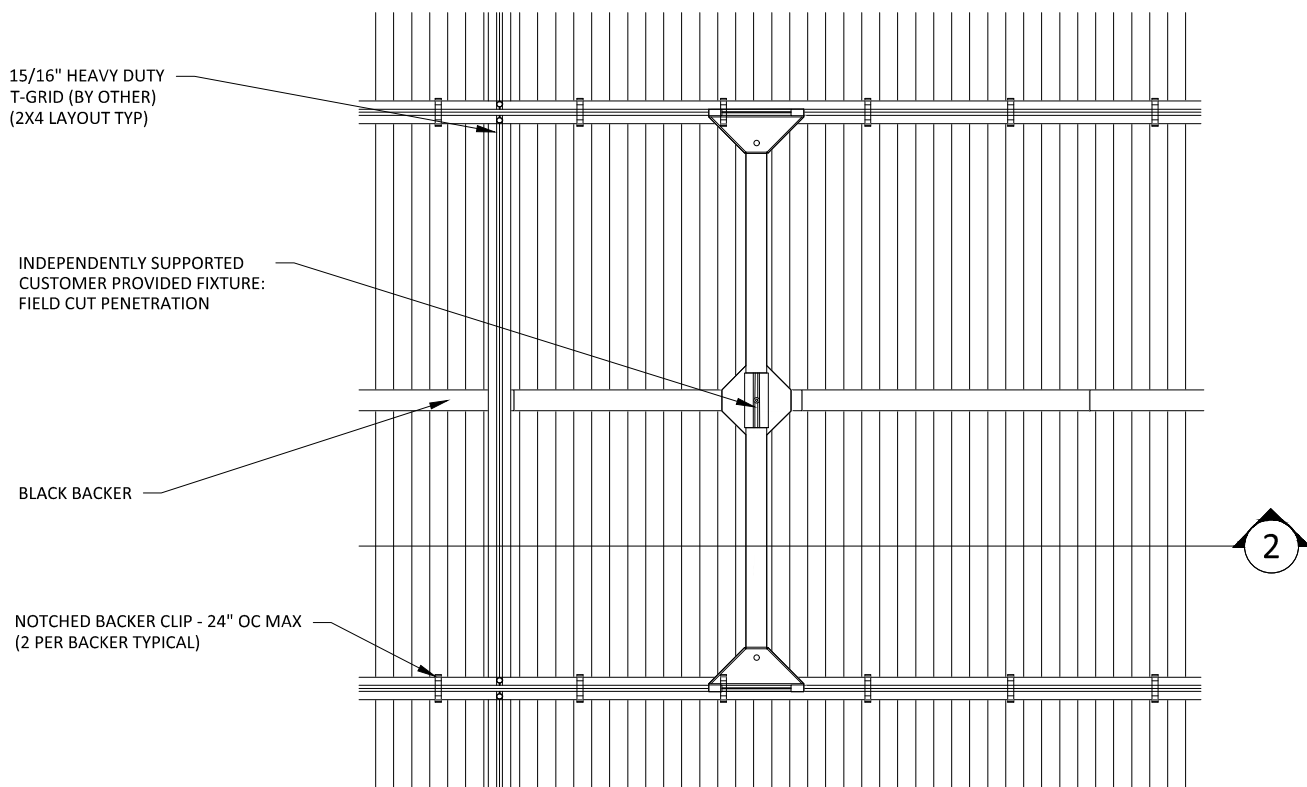


**1** PENDANT LIGHT DETAIL - PLAN VIEW  
1 1/2" = 1'-0"

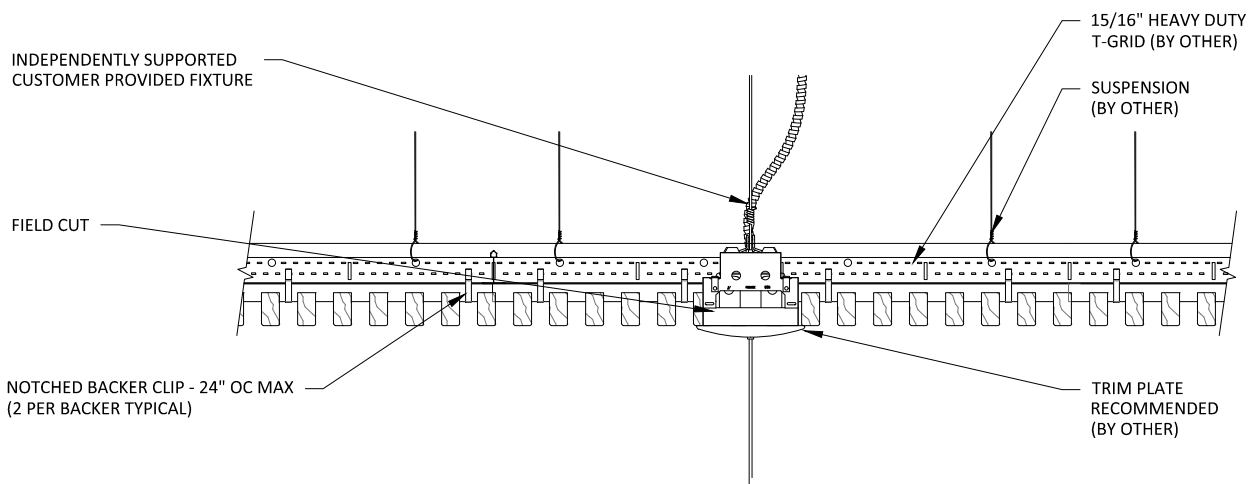


**2** PENDANT LIGHT DETAIL - SECTION VIEW  
1 1/2" = 1'-0"



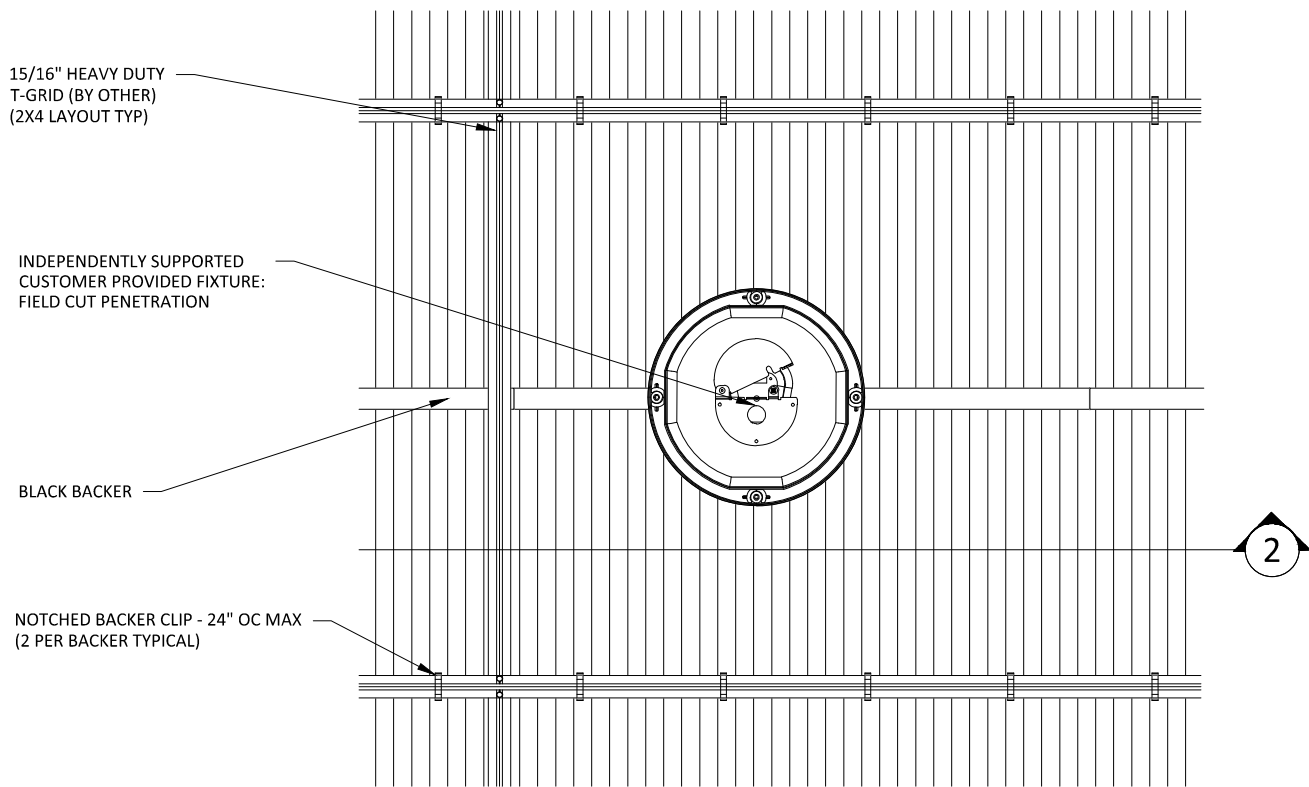

**1** RECESSED SPEAKER DETAIL - PLAN VIEW  
1 1/2" = 1'-0"

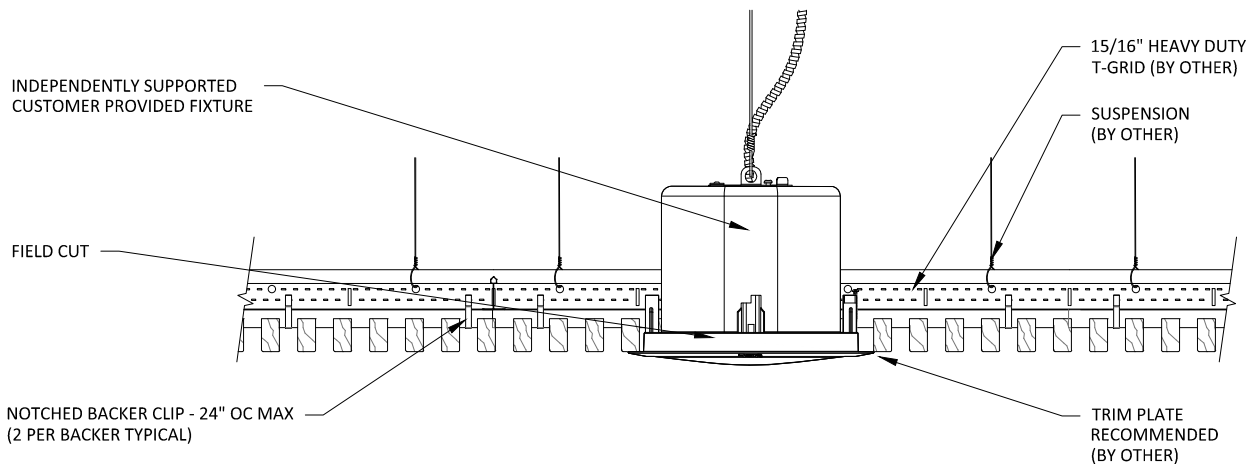

**2** RECESSED SPEAKER DETAIL - SECTION VIEW  
1 1/2" = 1'-0"

15/16" HEAVY DUTY  
T-GRID (BY OTHER)  
(2X4 LAYOUT TYP)

INDEPENDENTLY SUPPORTED  
CUSTOMER PROVIDED FIXTURE:  
FIELD CUT PENETRATION

BLACK BACKER


NOTCHED BACKER CLIP - 24" OC MAX  
(2 PER BACKER TYPICAL)

2

1

## DIFFUSER DETAIL - PLAN VIEW

1 1/2" = 1'-0"

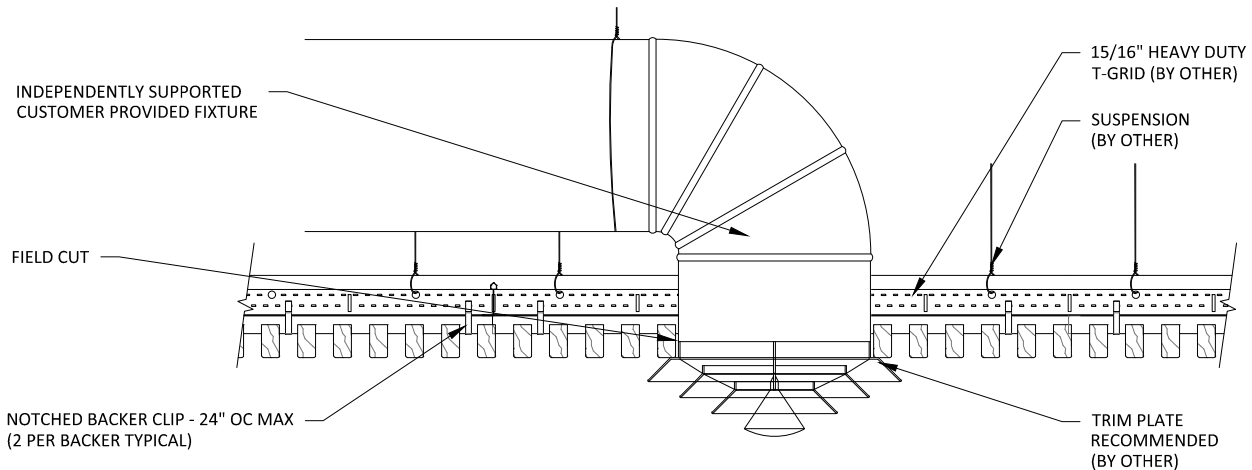

2

## DIFFUSER DETAIL - SECTION VIEW

1 1/2" = 1'-0"

# GRILLE-NOTCHED (CEILING SYSTEM) - DIFFUSER DETAILS


SCALE: AS NOTED

LAST REVISED: 6/29/2023


SHEET NUMBER

10

DRAWN BY: BH

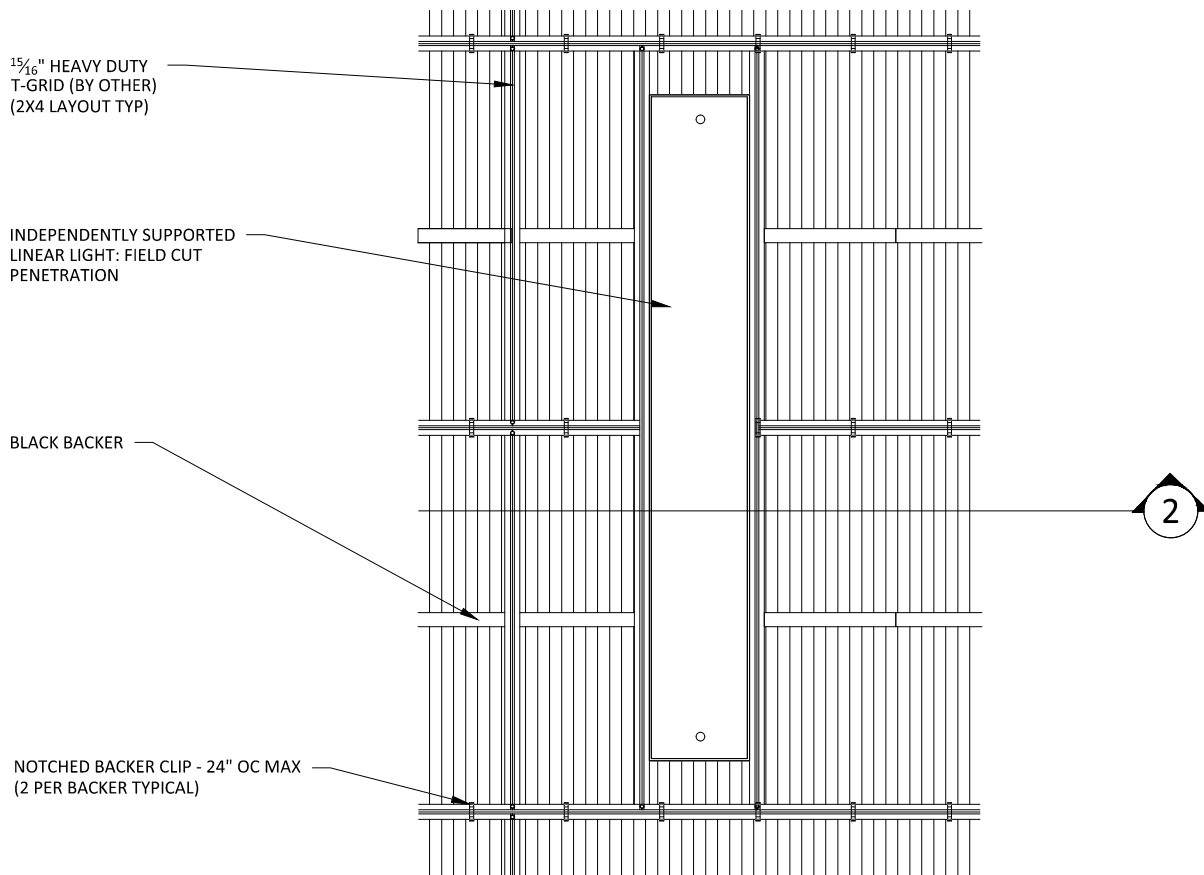

**1** LINEAR LIGHT DETAIL - PLAN VIEW  
1" = 1'-0"

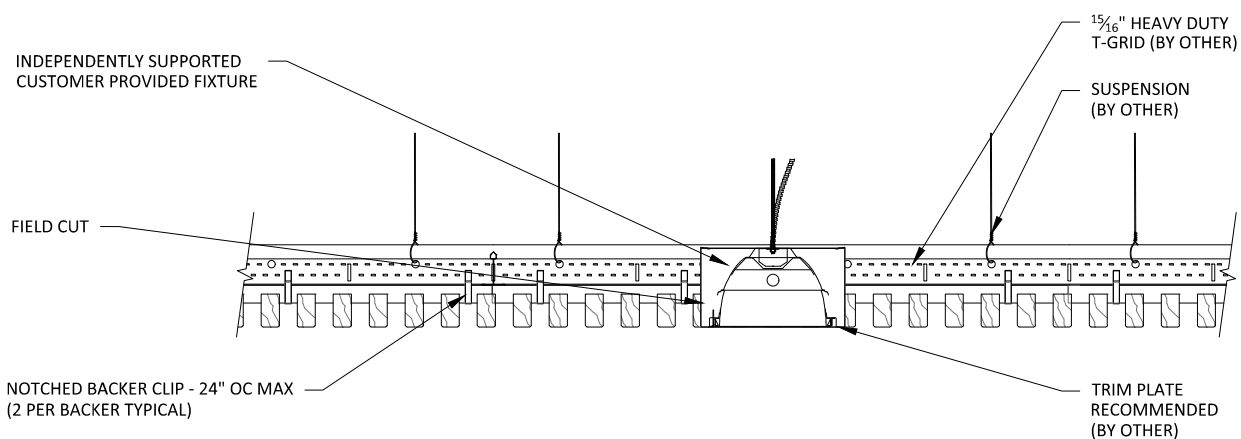

**2** LINEAR LIGHT DETAIL - SECTION VIEW  
1 1/2" = 1'-0"

1" ACOUSTICAL BACKER  
(2" AVAILABLE)

TYP. WALL ASSEMBLY  
(BY OTHER)

FURRING (BY OTHER) TO  
MATCH ACOUSTICAL BACKER  
THICKNESS

NOTCHED BACKER

2" SCREW (BY OTHER)

GRILLE RAIL

1/2" REVEAL FOR  
EXPANSION &  
CONTRACTION


16 GA. FINISH NAIL (BY OTHER)

TRIM (OPTIONAL) TO COINCIDE  
W/ FURRING THICKNESS; FACE  
NAILED & PUTTIED IN FIELD

NOTE: 24" MAXIMUM SCREW/SUPPORT SPACING


1 HORIZONTAL WALL ISOMETRIC - TYP.

1 1/2" = 1'-0"

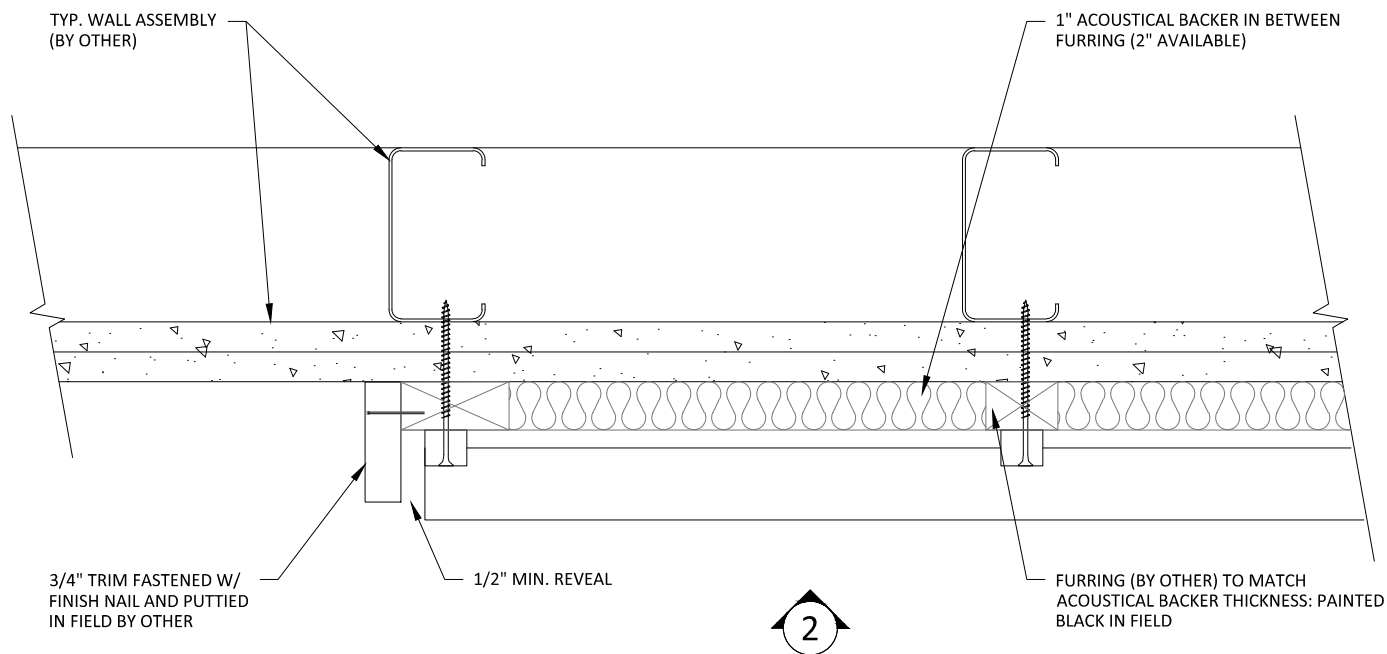

# 1 HORIZONTAL WALL PLAN @ TRIM

3" = 1'-0"

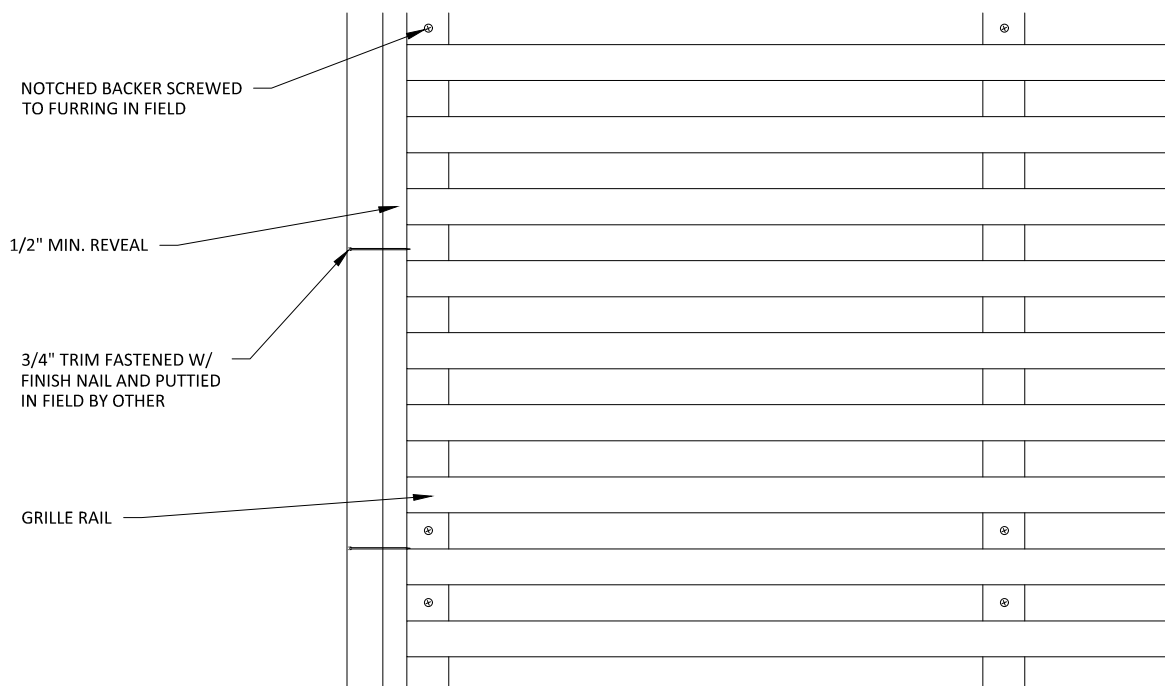

# 2 HORIZONTAL WALL ELEVATION @ TRIM

3" = 1'-0"

FURRING (BY OTHER) TO MATCH  
ACOUSTICAL BACKER THICKNESS

NOTCHED BACKER SCREWED  
TO FURRING IN FIELD

BASE AS SCHEDULED (BY OTHER)

2

## 1 HORIZONTAL WALL ELEVATION @ BASEBOARD

3" = 1'-0"

1" ACOUSTICAL BACKER (2" AVAILABLE)


NOTCHED BACKER SCREWED  
TO FURRING IN FIELD

TYP. WALL SYSTEM (BY OTHER)


BASE AS SCHEDULED (BY OTHER)

## 2 HORIZONTAL WALL SECTION @ BASEBOARD


3" = 1'-0"

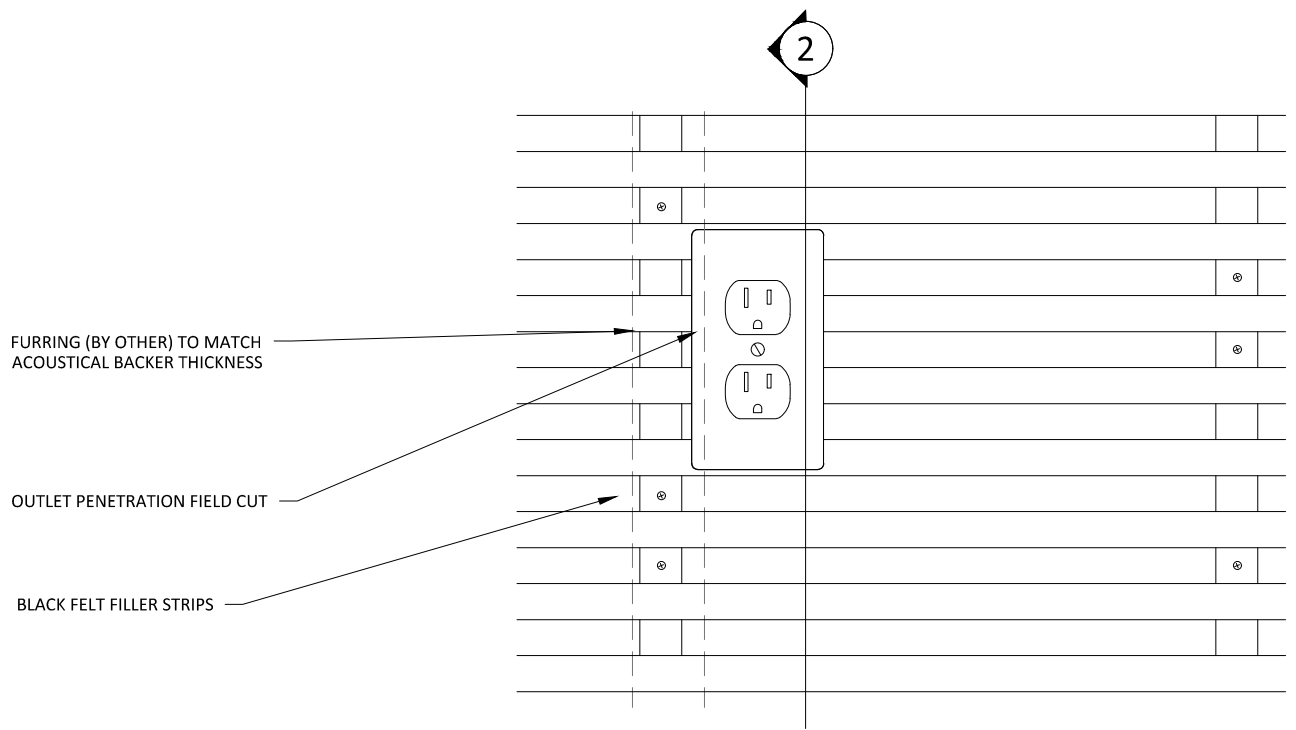


1 HORIZONTAL WALL ELEVATION @ OUTLET  
3" = 1'-0"

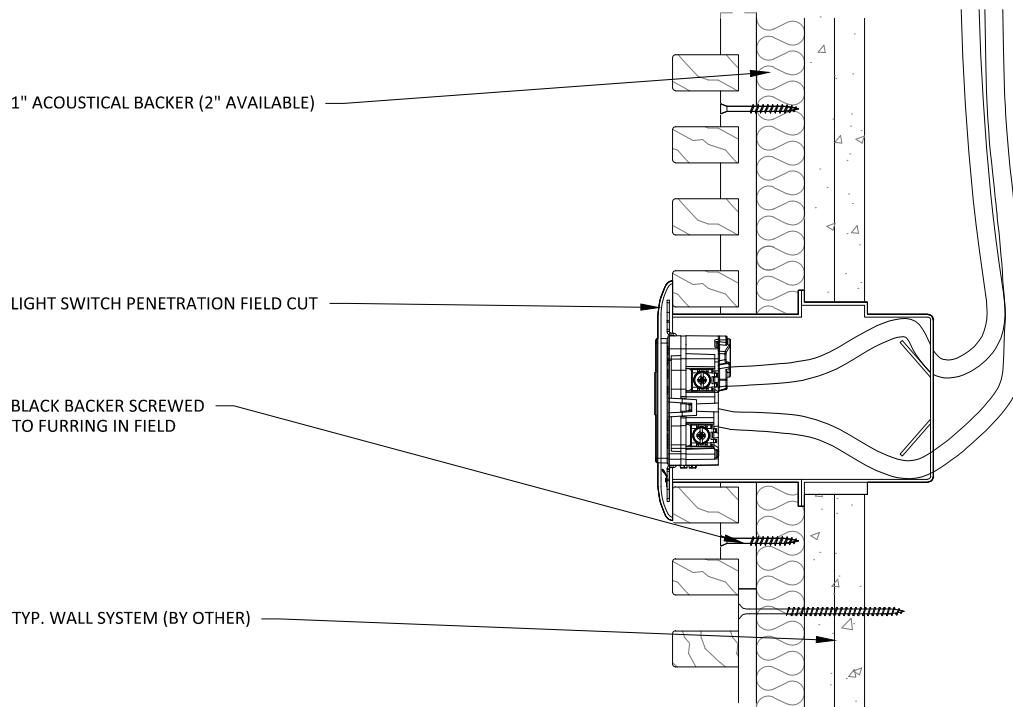

2 HORIZONTAL WALL SECTION @ OUTLET  
3" = 1'-0"

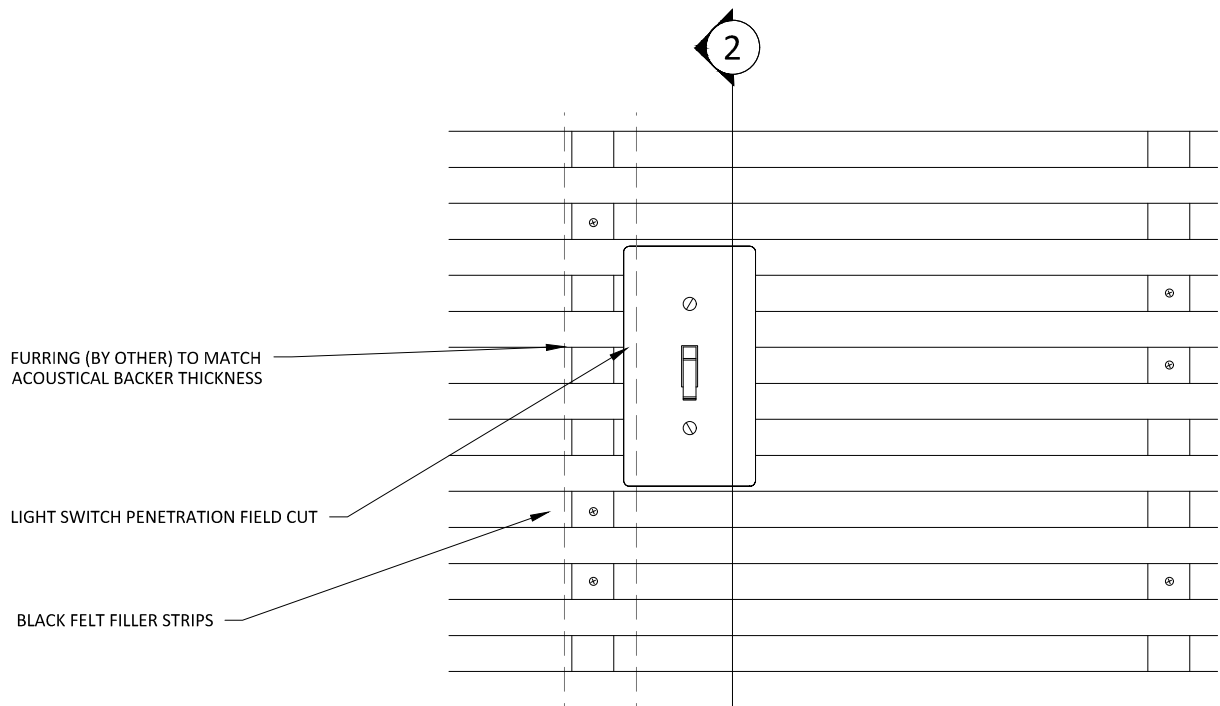


1 HORIZONTAL WALL ELEVATION @ LIGHT SWITCH  
3" = 1'-0"

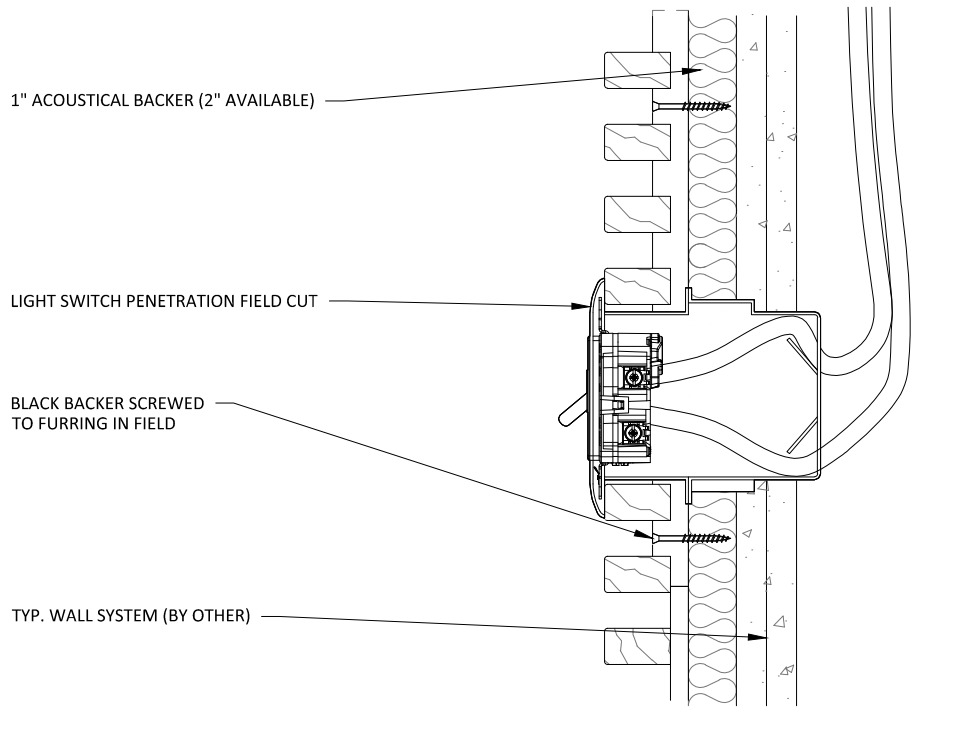


2 HORIZONTAL WALL SECTION @ LIGHT SWITCH  
3" = 1'-0"




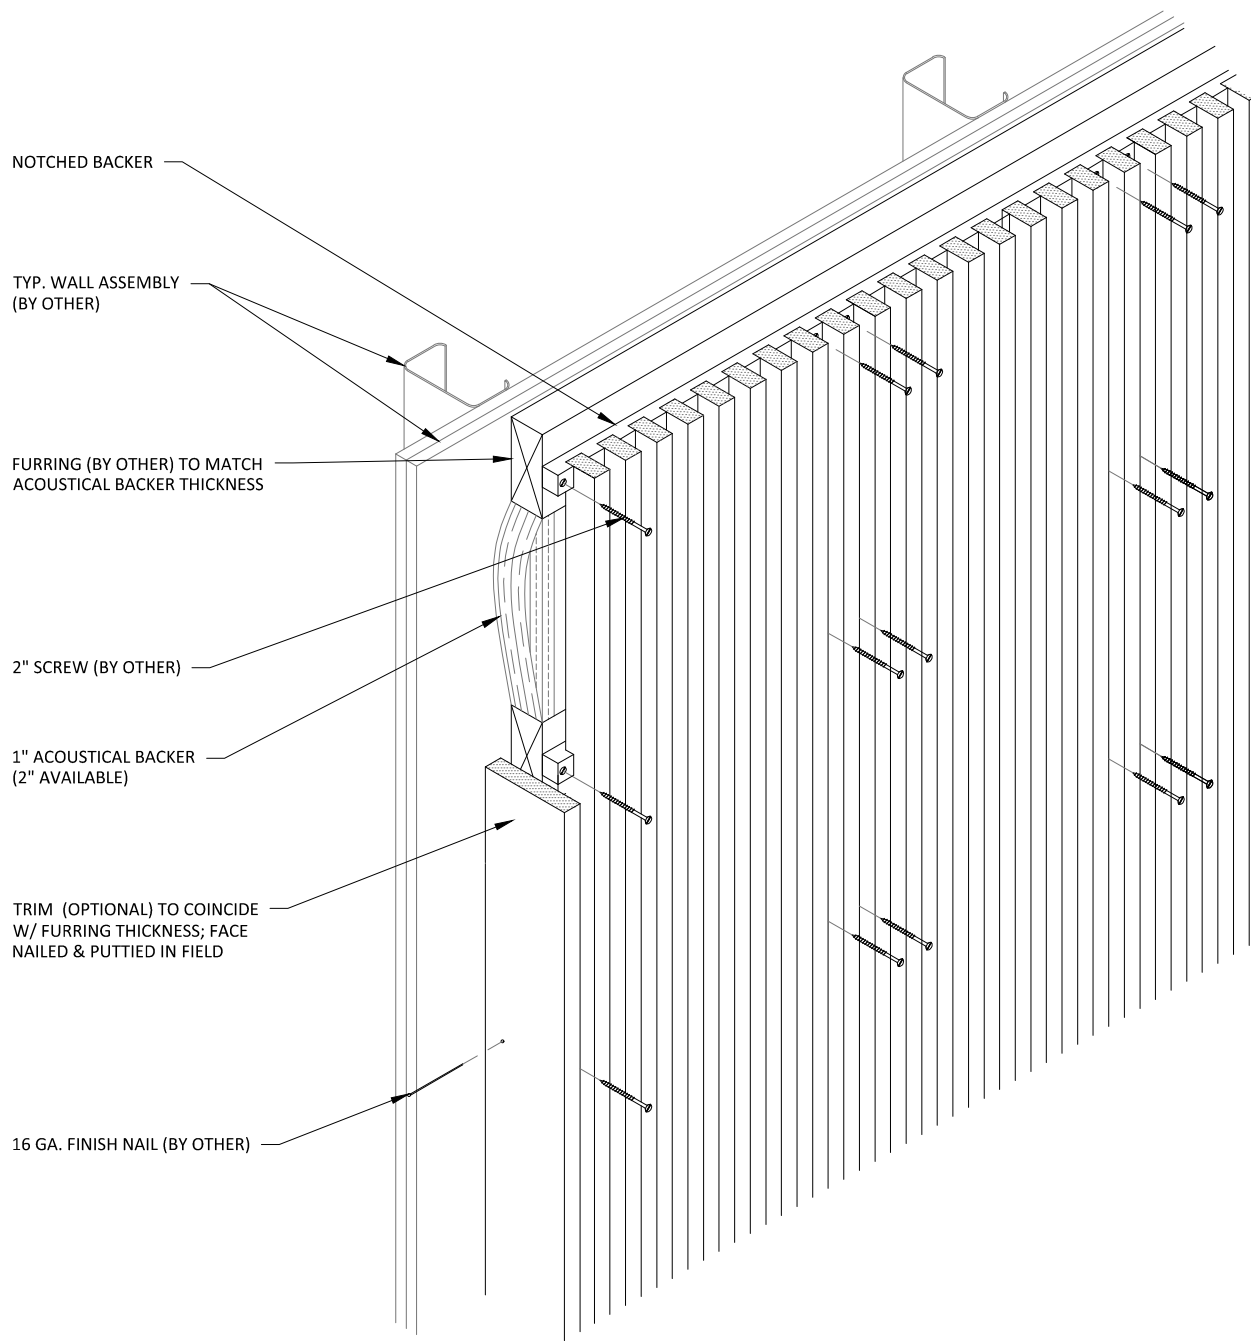

1 VERTICAL WALL ISOMETRIC - TYP.  
1 1/2" = 1'-0"

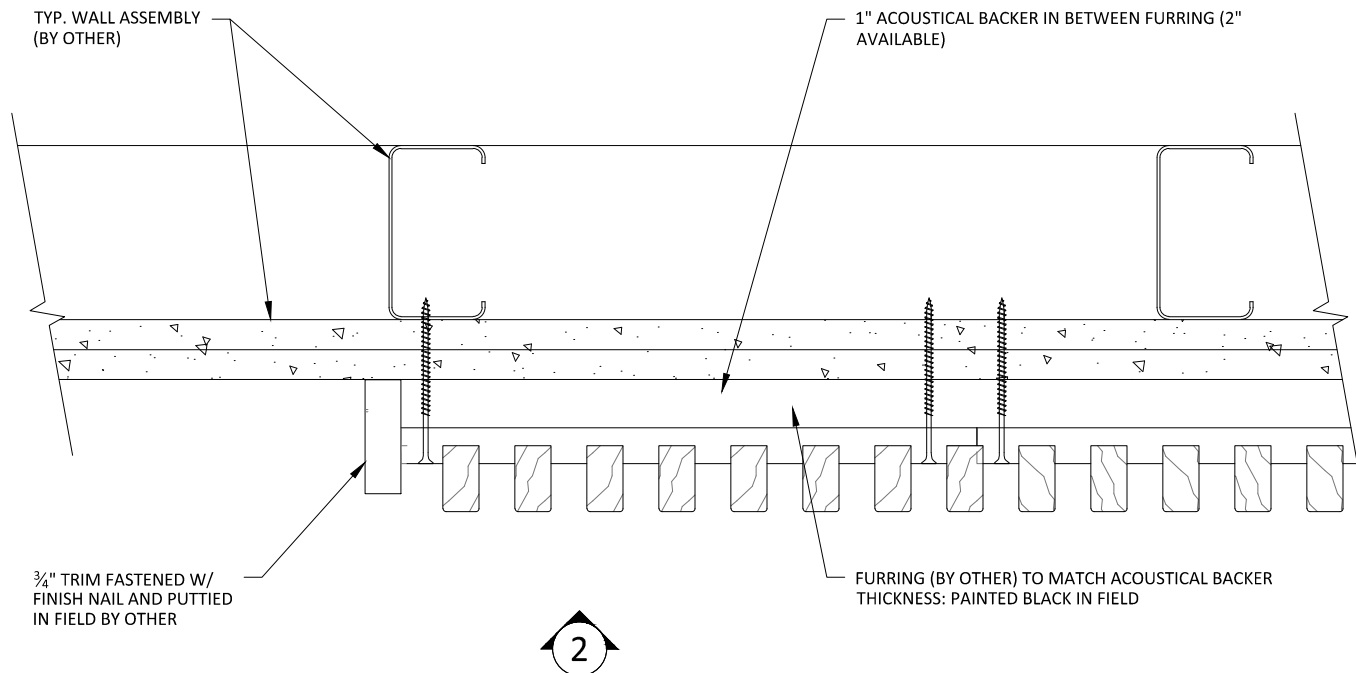

1 VERTICAL WALL PLAN @ TRIM  
3" = 1'-0"

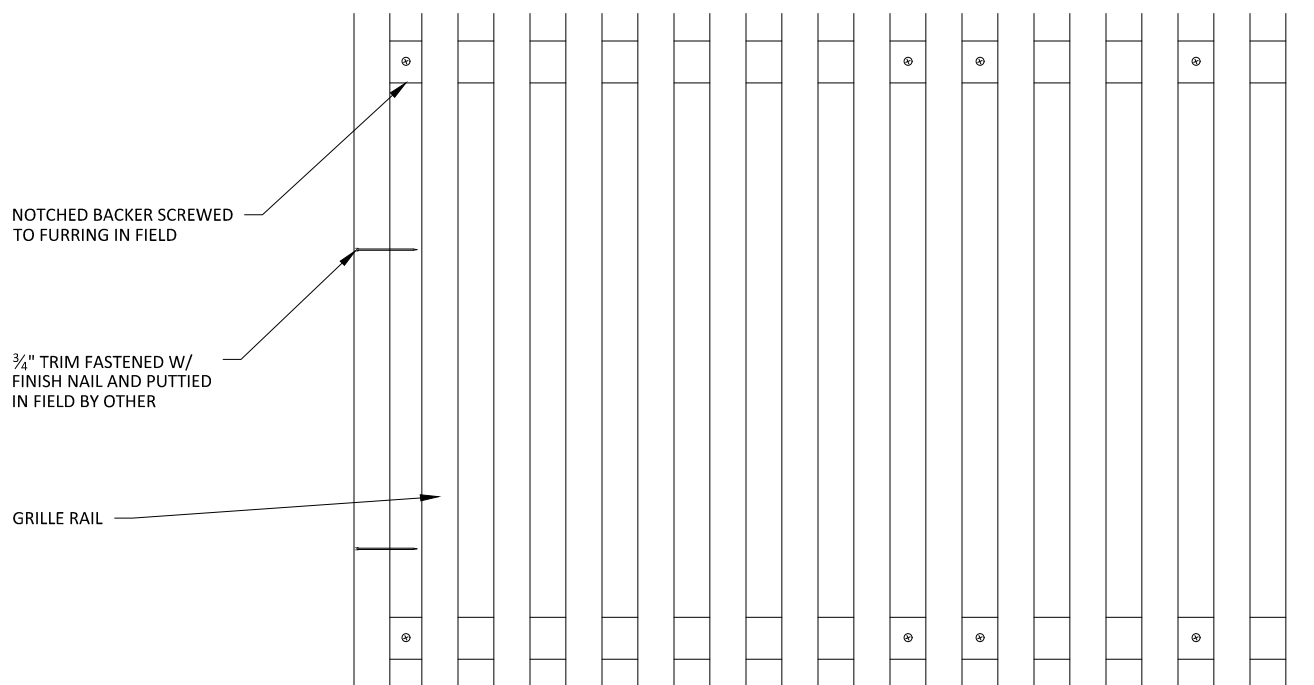

2 VERTICAL WALL ELEVATION @ TRIM  
3" = 1'-0"

FURRING (BY OTHER) TO MATCH  
ACOUSTICAL BACKER THICKNESS

NOTCHED BACKER SCREWED  
TO FURRING IN FIELD

BASE AS SCHEDULED (BY OTHER)

2

## 1 VERTICAL WALL ELEVATION @ BASEBOARD

3" = 1'-0"

1" ACOUSTICAL BACKER (2" AVAILABLE)


NOTCHED BACKER SCREWED  
TO FURRING IN FIELD

TYP. WALL SYSTEM (BY OTHER)


BASE AS SCHEDULED (BY OTHER)

## 2 VERTICAL WALL SECTION @ BASEBOARD


3" = 1'-0"

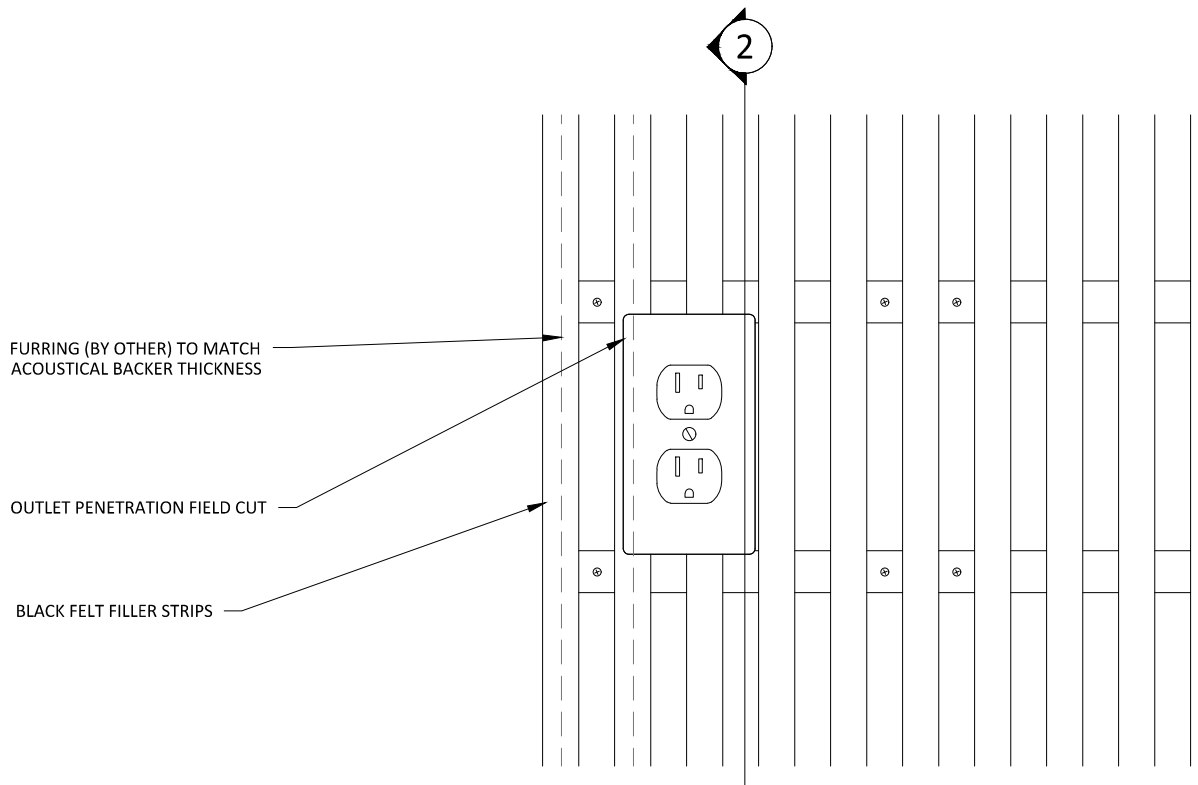


**1** VERTICAL WALL ELEVATION @ OUTLET  
3" = 1'-0"

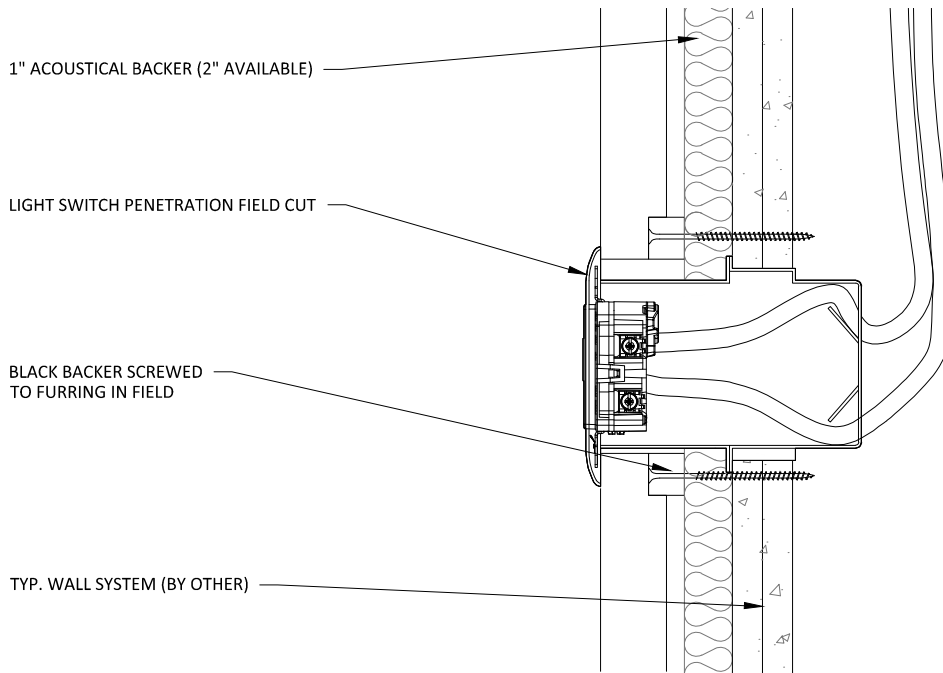


**2** VERTICAL WALL SECTION @ OUTLET  
3" = 1'-0"

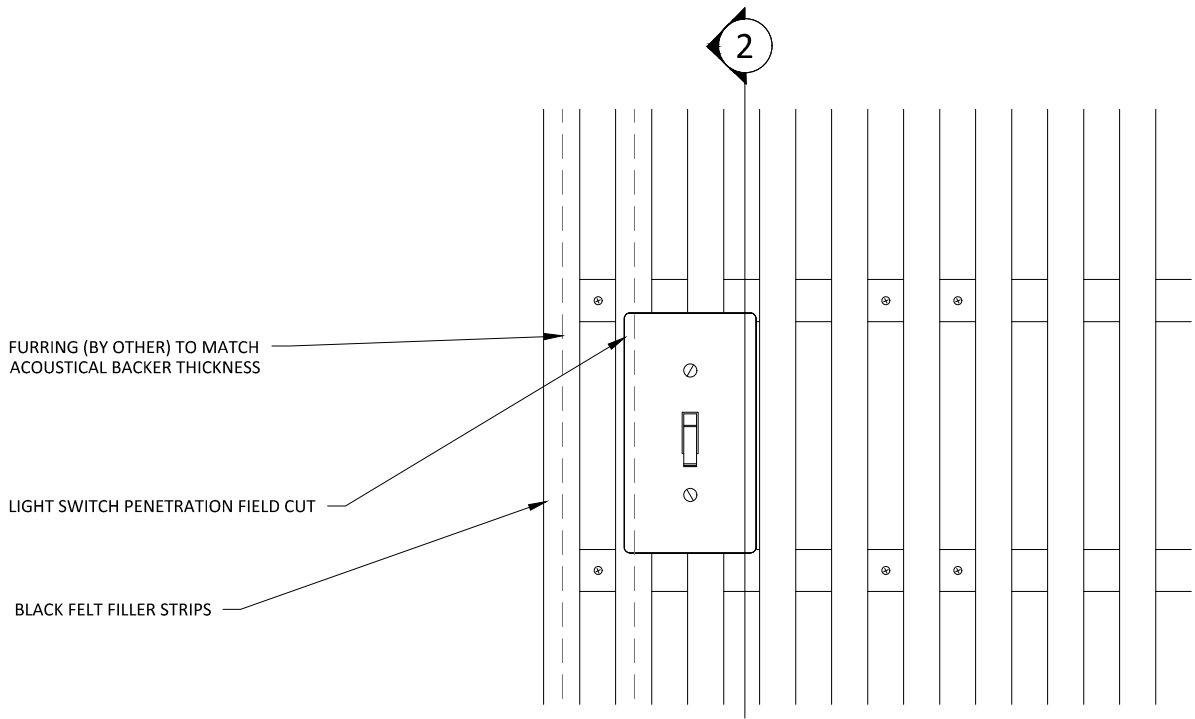


**1** VERTICAL WALL ELEVATION @ LIGHT SWITCH  
3" = 1'-0"

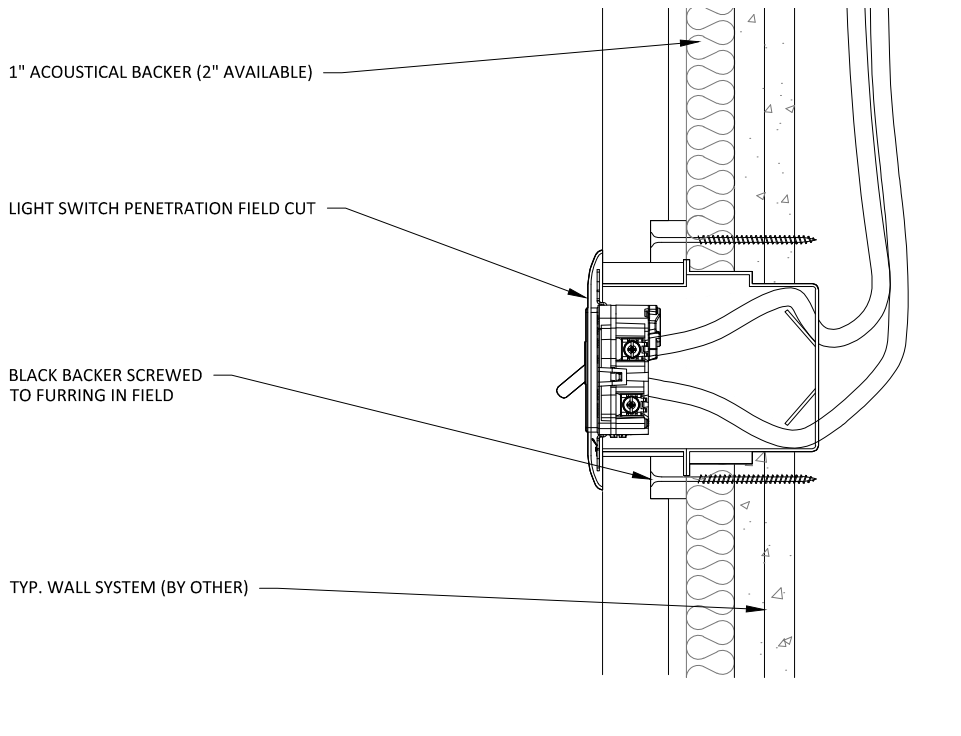


**2** VERTICAL WALL SECTION @ LIGHT SWITCH  
3" = 1'-0"

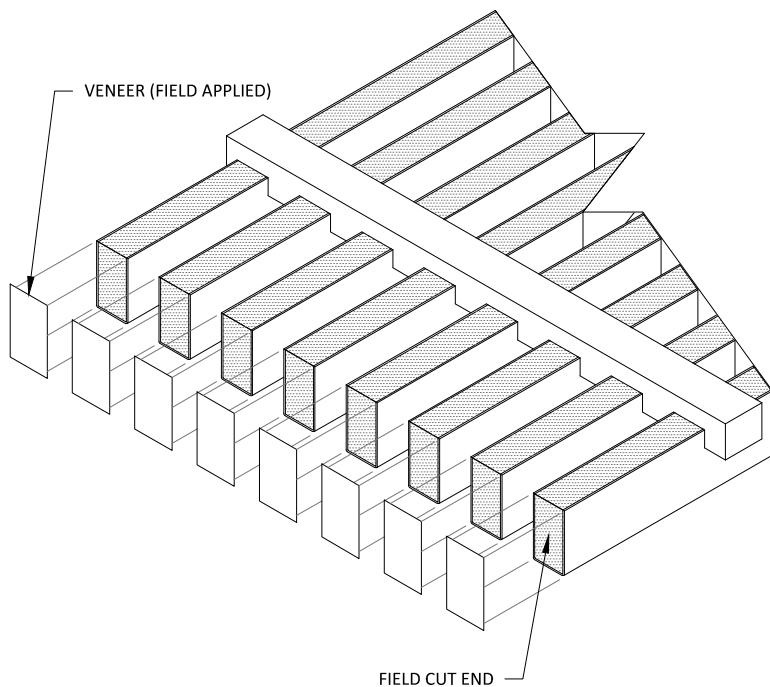

1 STEP 1  
3" = 1'-0"

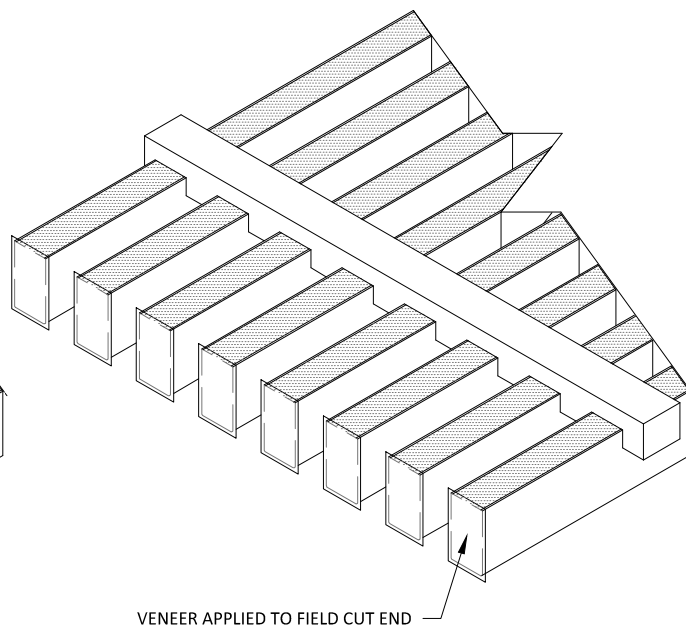


2 STEP 2  
3" = 1'-0"

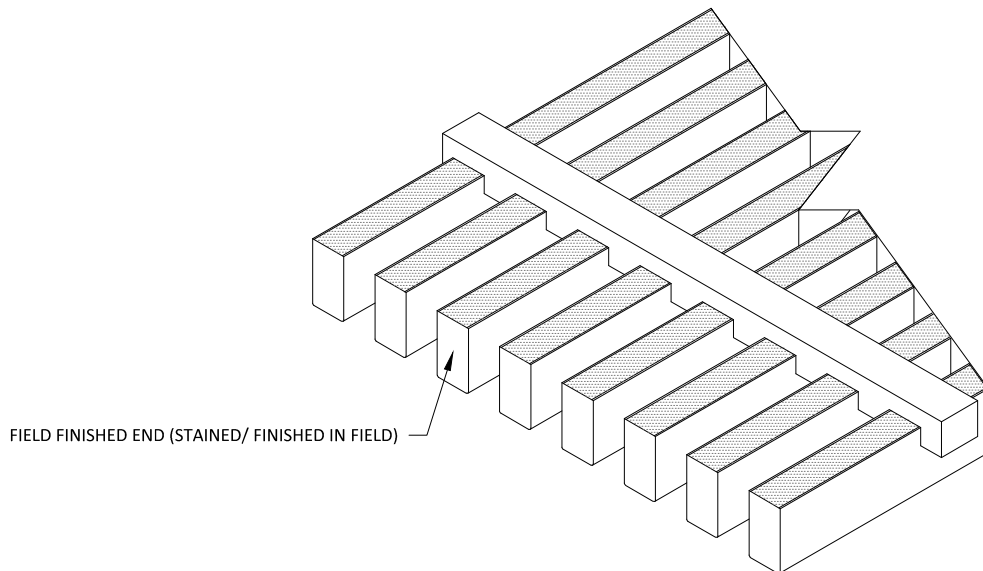

3 STEP 3  
3" = 1'-0"

DESIRED FIELD CUT ANGLE

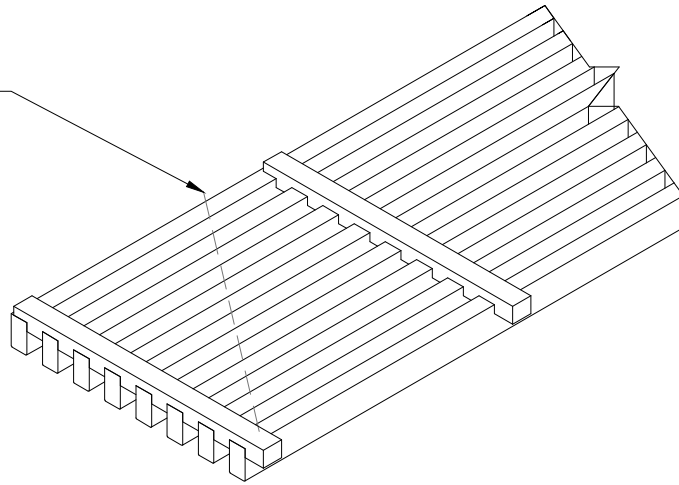


# 1 ANGLE-CUT STEP 1

1 1/2" = 1'-0"

DESIRED FIELD CUT ANGLE


STAPLE 3/8" THICK PLYWOOD BACKER PLATE (BY OTHER) TO GRILLE RAILS. BACKER PLATE IS TO BE PAINTED BLACK ON FACE.

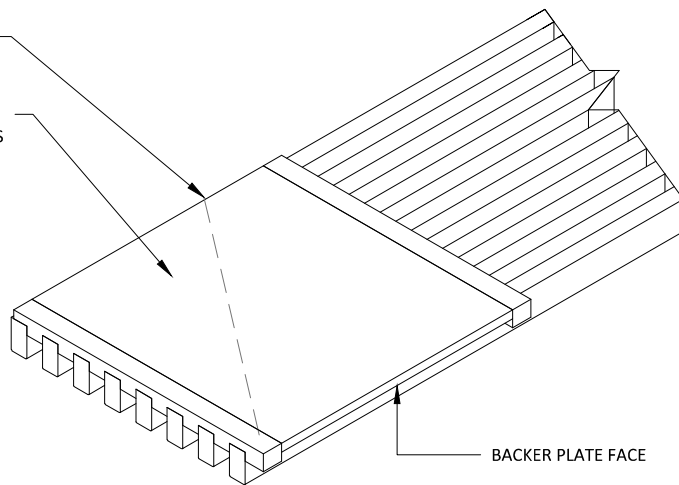

# 2 ANGLE-CUT STEP 2

1 1/2" = 1'-0"

ONCE BACKER PLATE IS FASTENED TO GRILLE PANEL, CUT DESIRED LINE AND FINISH ENDS AS SHOWN IN THE FIELD FINISHED END INSTRUCTIONS IN THIS STANDARD DETAIL SET

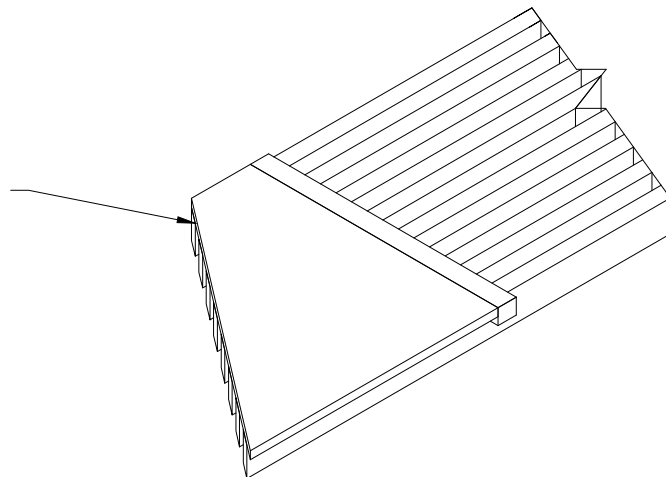

# 3 ANGLE-CUT STEP 3

1 1/2" = 1'-0"

## GRILLE-NOTCHED SYSTEM - ANGLE CUT INSTRUCTIONS

SCALE: AS NOTED

LAST REVISED: 6/29/2023

SHEET NUMBER

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