




1 TYPICAL SECTION VIEW
3" = 1'-0"

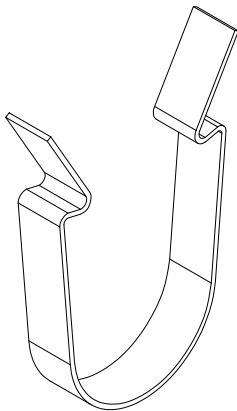

ISOMETRIC

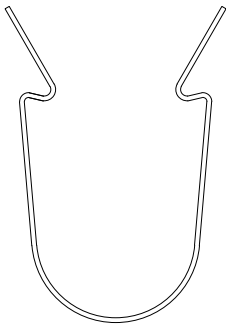


ELEVATION

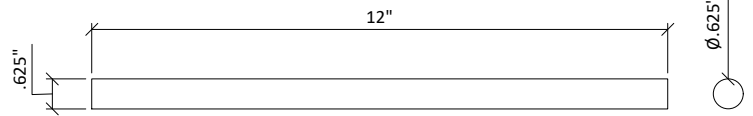


2 DOWEL CLIP
1' = 1'-0"

3 BLACK DOWEL
3" = 1'-0"

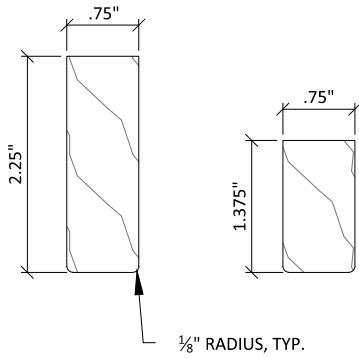





SOLID WOOD RAIL

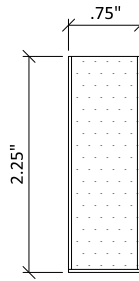


VENEERED RAIL

CUSTOM PROFILES AVAILABLE UPON REQUEST


1 TYPICAL RAIL PROFILES
6" = 1'-0"

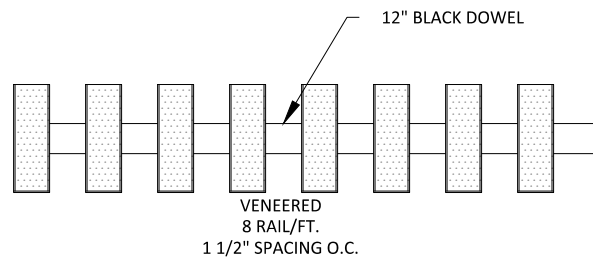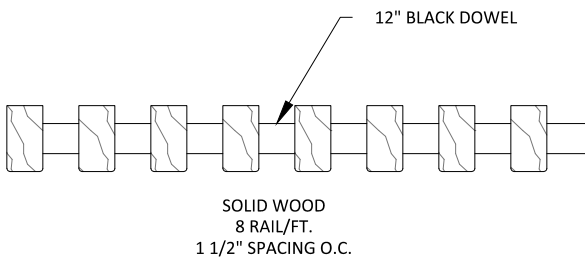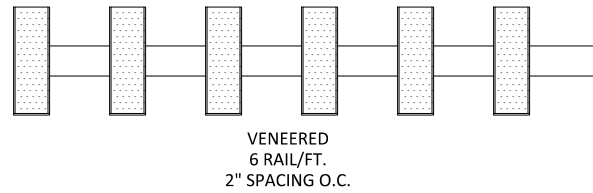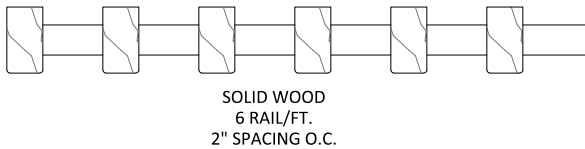

2 TYPICAL 12 INCH MODULES
3" = 1'-0"

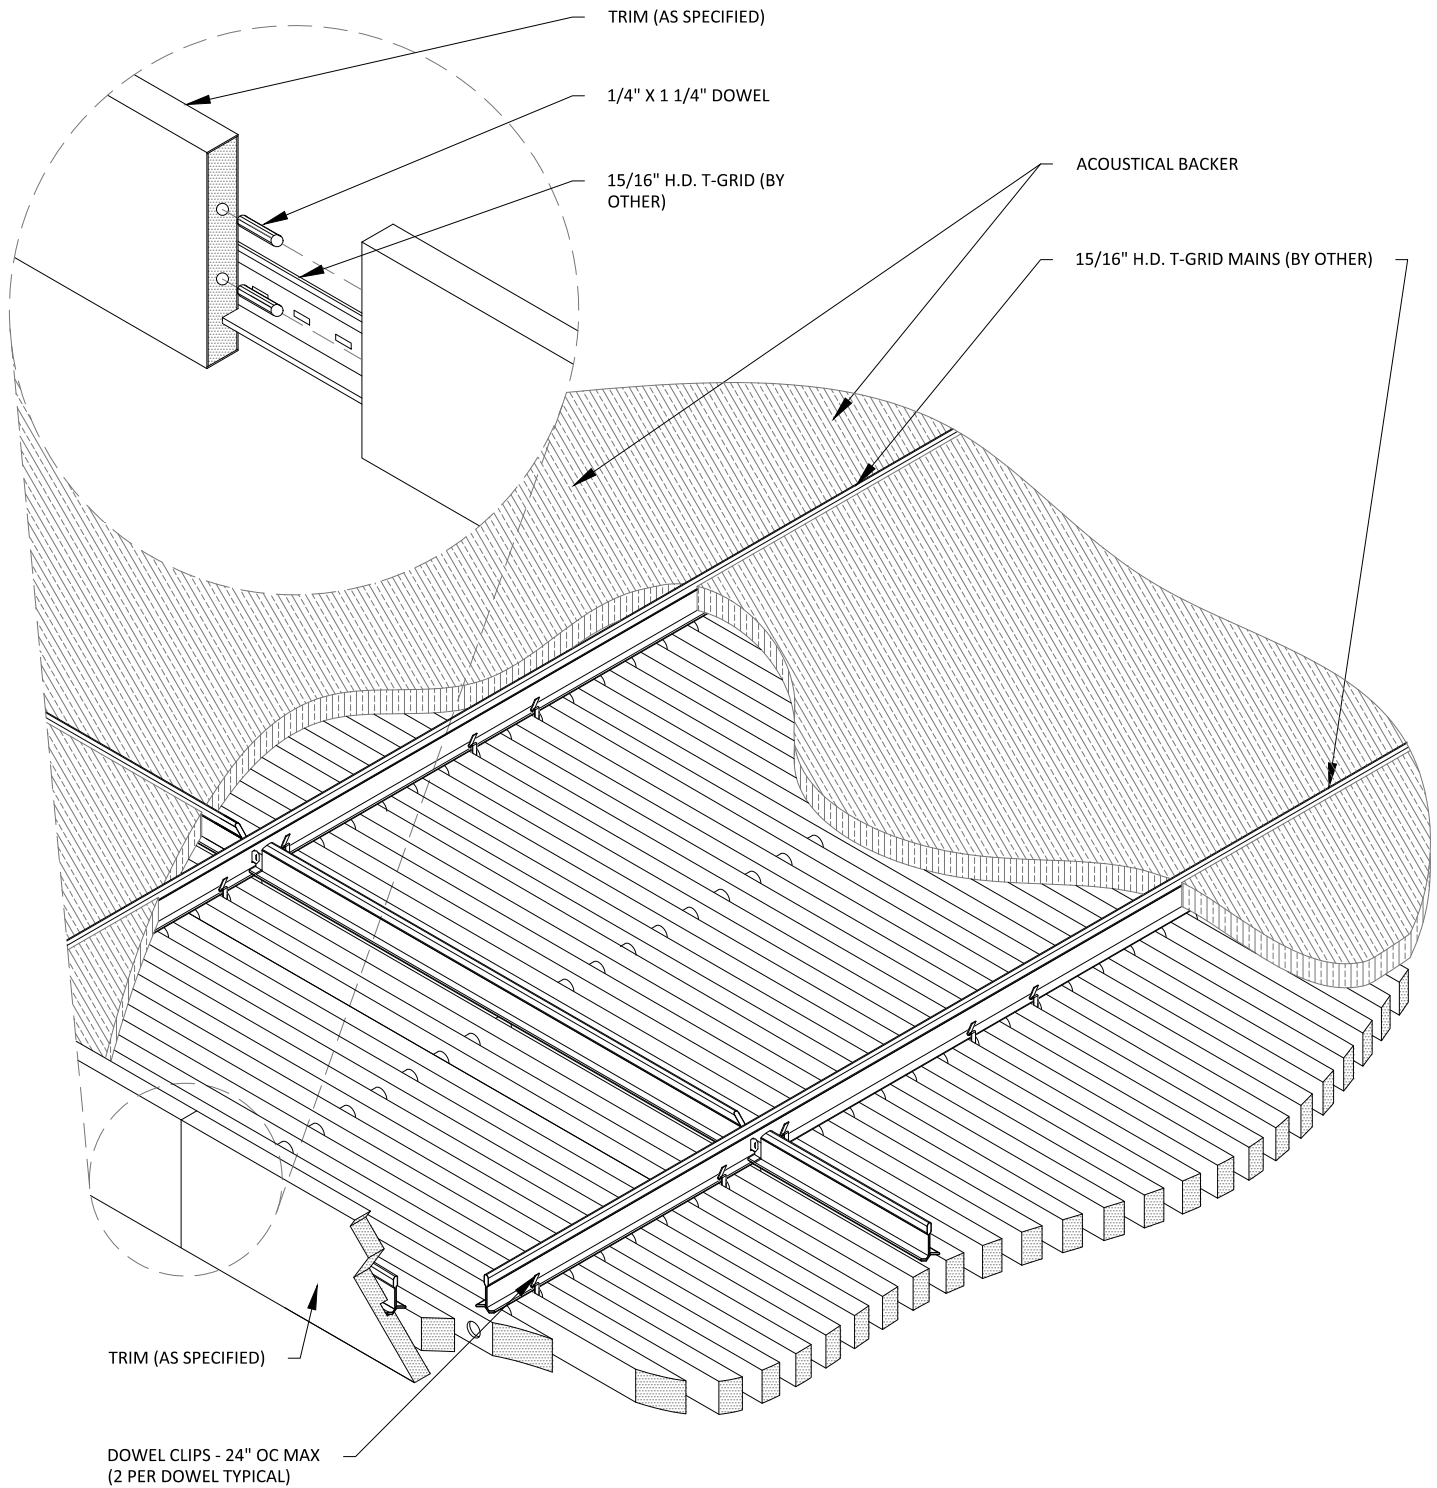


1 CEILING ISOMETRIC - TYP.
1 1/2" = 1'-0"

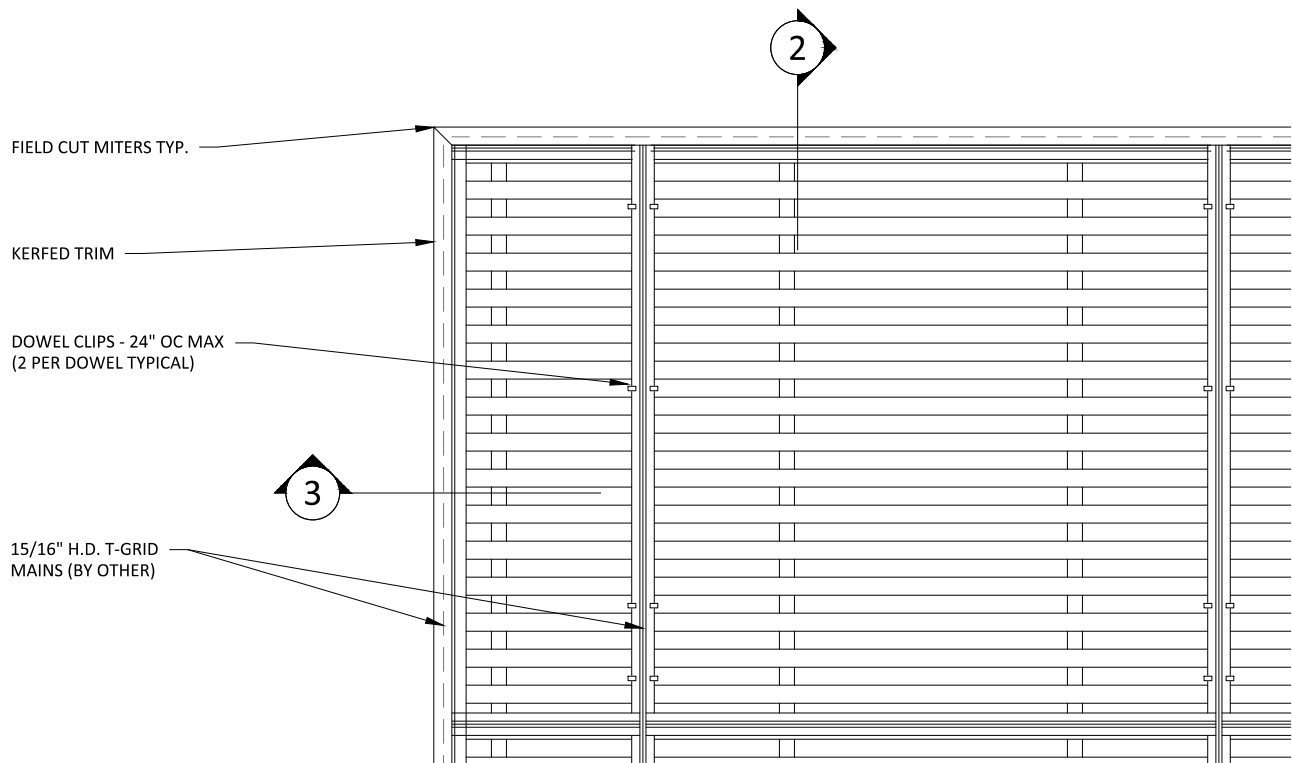


1 TRIM @ MITERED CORNER - PLAN
1 1/2" = 1'-0"

** ALL FIELD CUTS TO ALLOW FOR 1/4" MIN REVEAL FOR EXPANSION & CONTRACTION

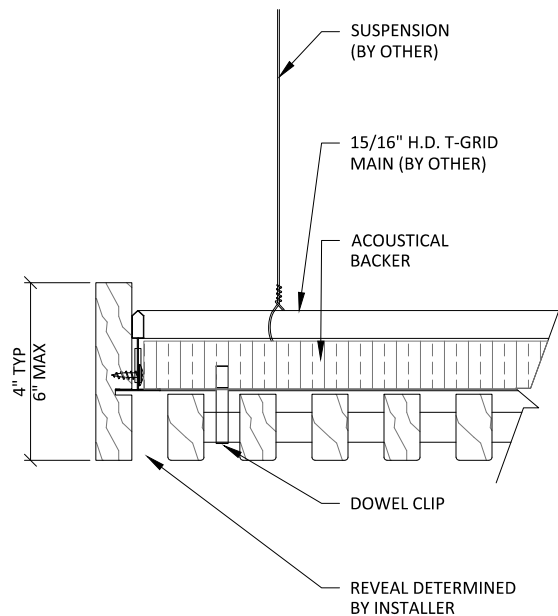


2 TRIM DETAIL 1
3" = 1'-0"

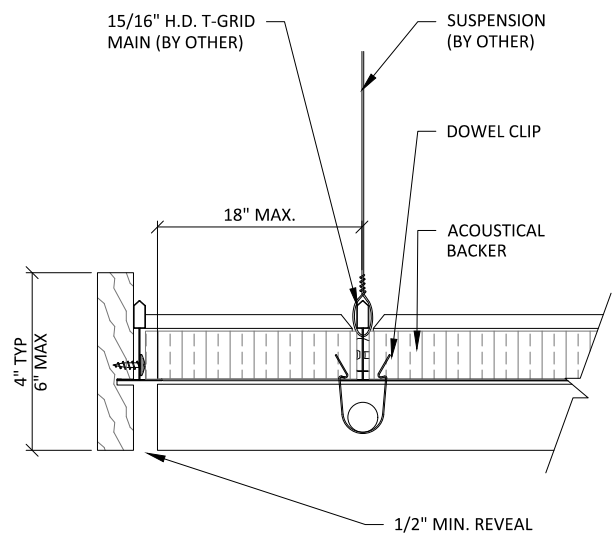


3 TRIM DETAIL 2
3" = 1'-0"


** ALL FIELD CUTS TO ALLOW FOR 1/4" MIN
REVEAL FOR EXPANSION & CONTRACTION

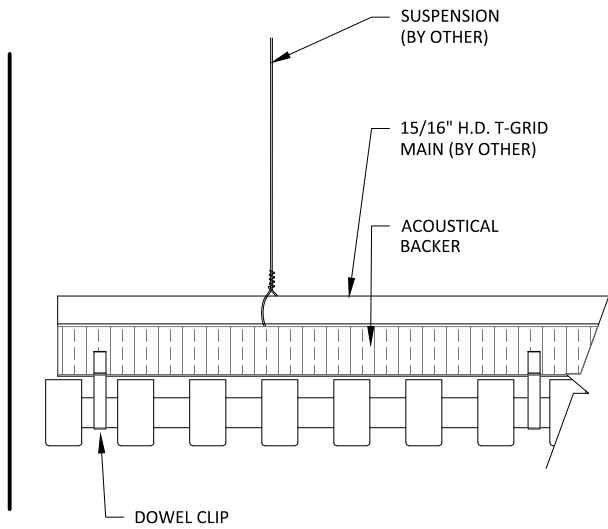


1 EDGE DETAIL 1
3" = 1'-0"

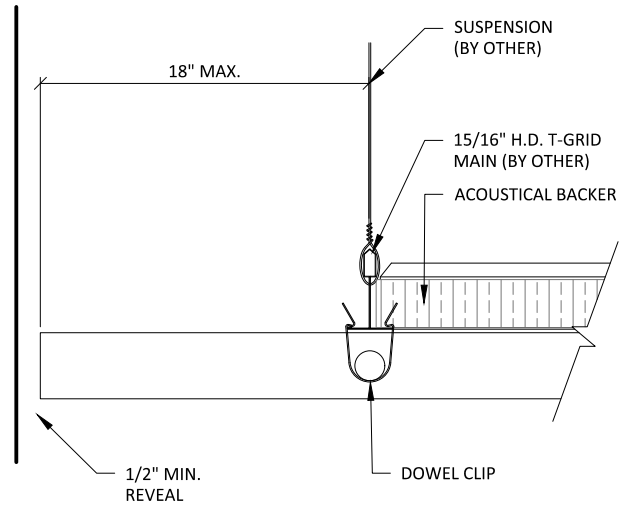

2 EDGE DETAIL 2
3" = 1'-0"

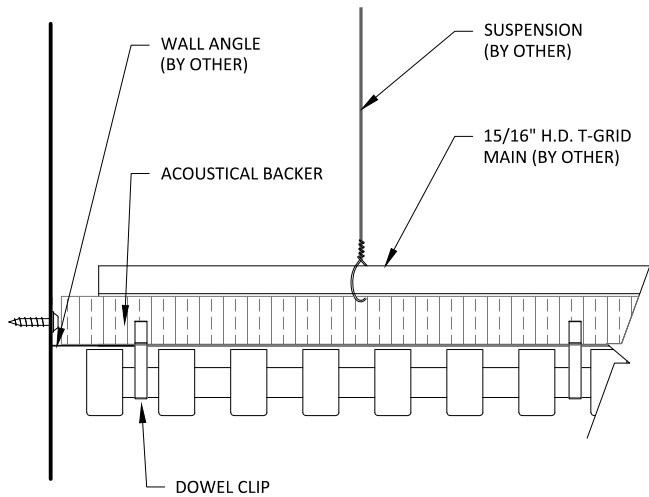

3 EDGE DETAIL 3
3" = 1'-0"

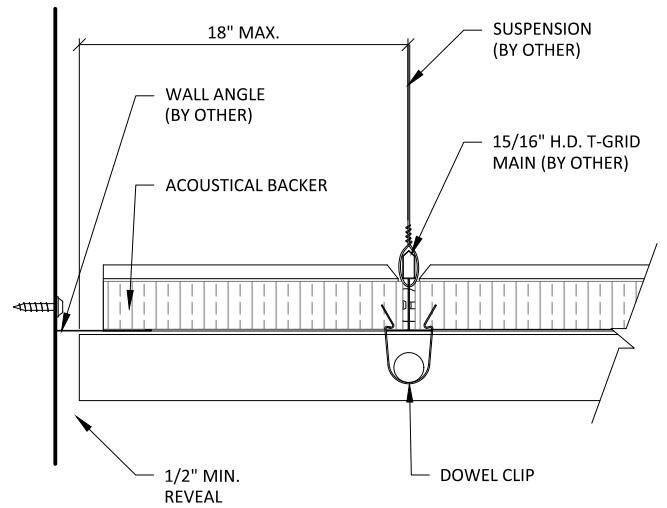


4 EDGE DETAIL 4
3" = 1'-0"

15/16" HEAVY DUTY
T-GRID (BY OTHER)
(2X4 LAYOUT TYP)

INDEPENDENTLY SUPPORTED
CUSTOMER PROVIDED FIXTURE:
FIELD CUT PENETRATION

BLACK DOWEL

DOWEL CLIPS - 24" OC MAX
(2 PER DOWEL TYPICAL)

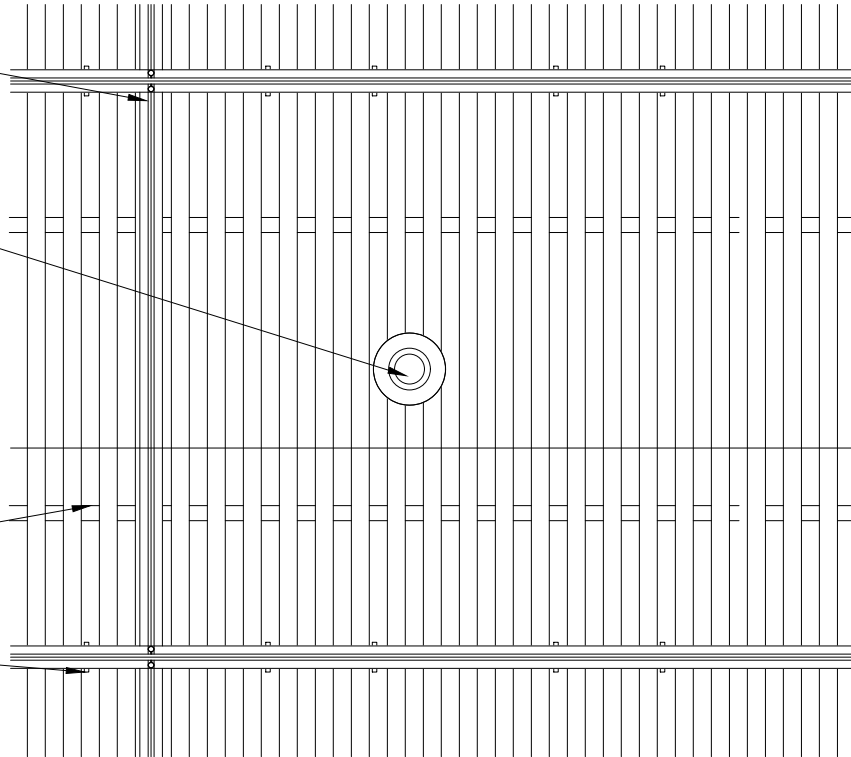

1 SPRINKLER HEAD DETAIL - PLAN VIEW
1 1/2" = 1'-0"

INDEPENDENTLY SUPPORTED
CUSTOMER PROVIDED FIXTURE


FIELD CUT

DOWEL CLIPS - 24" OC MAX
(2 PER DOWEL TYPICAL)

15/16" HEAVY DUTY
T-GRID (BY OTHER)

SUSPENSION
(BY OTHER)

TRIM PLATE
RECOMMENDED
(BY OTHER)

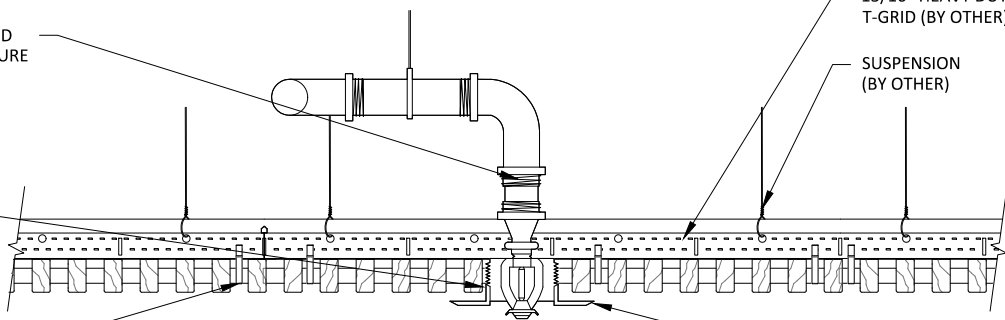

2 SPRINKLER HEAD DETAIL - SECTION VIEW
1 1/2" = 1'-0"

15/16" HEAVY DUTY
T-GRID (BY OTHER)
(2X4 LAYOUT TYP)

INDEPENDENTLY SUPPORTED
CUSTOMER PROVIDED FIXTURE:
FIELD CUT PENETRATION

BLACK DOWEL

DOWEL CLIPS - 24" OC MAX
(2 PER DOWEL TYPICAL)

2

1

CAN LIGHT DETAIL - PLAN VIEW

1 1/2" = 1'-0"

INDEPENDENTLY SUPPORTED
CUSTOMER PROVIDED FIXTURE

FIELD CUT

DOWEL CLIPS - 24" OC MAX
(2 PER DOWEL TYPICAL)

15/16" HEAVY DUTY
T-GRID (BY OTHER)

SUSPENSION
(BY OTHER)

TRIM PLATE
RECOMMENDED
(BY OTHER)

2

CAN LIGHT DETAIL - SECTION VIEW

1 1/2" = 1'-0"

GRILLE-DOWELED (CEILING SYSTEM) - CAN LIGHT DETAILS

SHEET NUMBER

7

SCALE: AS NOTED

LAST REVISED: 5/16/2023

DRAWN BY: BMH

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15/16" HEAVY DUTY
T-GRID (BY OTHER)
(2X4 LAYOUT TYP)

INDEPENDENTLY SUPPORTED
CUSTOMER PROVIDED FIXTURE:
FIELD CUT PENETRATION

BLACK DOWEL

DOWEL CLIPS - 24" OC MAX
(2 PER DOWEL TYPICAL)

2

1

PENDANT LIGHT DETAIL - PLAN VIEW

1 1/2" = 1'-0"

INDEPENDENTLY SUPPORTED
CUSTOMER PROVIDED FIXTURE

FIELD CUT

DOWEL CLIPS - 24" OC MAX
(2 PER DOWEL TYPICAL)

15/16" HEAVY DUTY
T-GRID (BY OTHER)

SUSPENSION
(BY OTHER)

TRIM PLATE
RECOMMENDED
(BY OTHER)

2

PENDANT LIGHT DETAIL - SECTION VIEW

1 1/2" = 1'-0"

GRILLE-DOWELED (CEILING SYSTEM) - PENDANT LIGHT DETAILS

SCALE: AS NOTED

LAST REVISED: 5/16/2023

SHEET NUMBER

8


DRAWN BY: BMH

15/16" HEAVY DUTY
T-GRID (BY OTHER)
(2X4 LAYOUT TYP)

INDEPENDENTLY SUPPORTED
CUSTOMER PROVIDED FIXTURE:
FIELD CUT PENETRATION

BLACK DOWEL

DOWEL CLIPS - 24" OC MAX
(2 PER DOWEL TYPICAL)

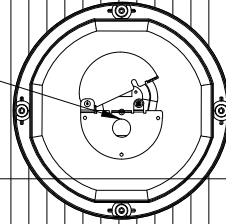

2

1 RECESSED SPEAKER DETAIL - PLAN VIEW

1 1/2" = 1'-0"

INDEPENDENTLY SUPPORTED
CUSTOMER PROVIDED FIXTURE


FIELD CUT

DOWEL CLIPS - 24" OC MAX
(2 PER DOWEL TYPICAL)

15/16" HEAVY DUTY
T-GRID (BY OTHER)

SUSPENSION
(BY OTHER)

TRIM PLATE
RECOMMENDED
(BY OTHER)

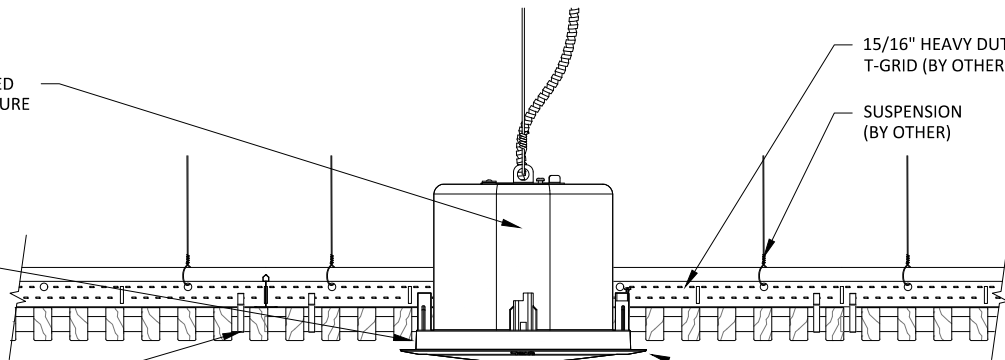

2 RECESSED SPEAKER DETAIL - SECTION VIEW

1 1/2" = 1'-0"

GRILLE-DOWELED (CEILING SYSTEM) - RECESSED SPEAKER DETAILS

SCALE: AS NOTED

LAST REVISED: 5/16/2023

SHEET NUMBER

9

DRAWN BY: BMH

15/16" HEAVY DUTY
T-GRID (BY OTHER)
(2X4 LAYOUT TYP)

INDEPENDENTLY SUPPORTED
CUSTOMER PROVIDED FIXTURE:
FIELD CUT PENETRATION

BLACK DOWEL

DOWEL CLIPS - 24" OC MAX
(2 PER DOWEL TYPICAL)

2

1

DIFFUSER DETAIL - PLAN VIEW

1 1/2" = 1'-0"

INDEPENDENTLY SUPPORTED
CUSTOMER PROVIDED FIXTURE

FIELD CUT

DOWEL CLIPS - 24" OC MAX
(2 PER DOWEL TYPICAL)

15/16" HEAVY DUTY
T-GRID (BY OTHER)

SUSPENSION
(BY OTHER)

TRIM PLATE
RECOMMENDED
(BY OTHER)

2

DIFFUSER DETAIL - SECTION VIEW

1 1/2" = 1'-0"

GRILLE-DOWELED (CEILING SYSTEM) - DIFFUSER DETAILS

SHEET NUMBER

10

SCALE: AS NOTED

LAST REVISED: 5/16/2023

DRAWN BY: BMH

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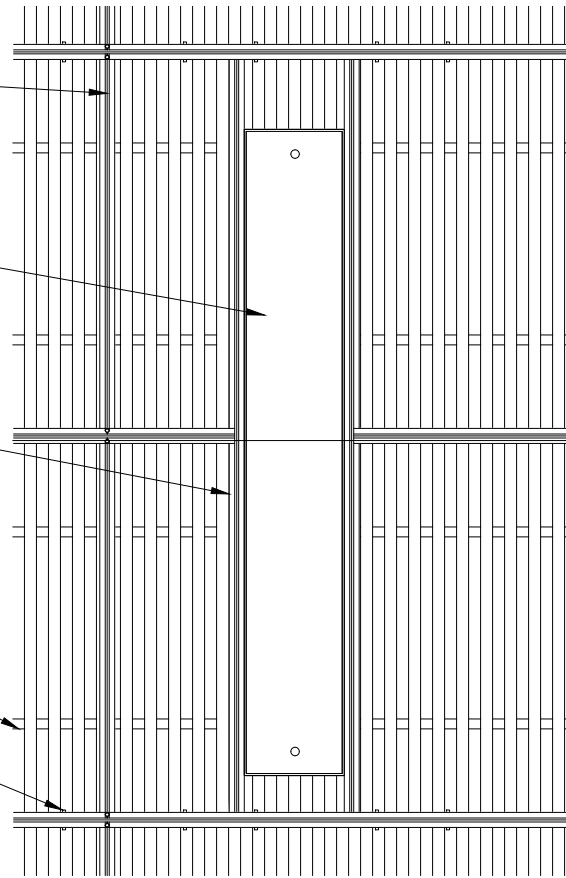
15/16" HEAVY DUTY
T-GRID (BY OTHER)
(2X4 LAYOUT TYP)

INDEPENDENTLY SUPPORTED
LINEAR LIGHT: FIELD CUT
PENETRATION

STUB-IN GRID AS NECESSARY

BLACK DOWEL

DOWEL CLIPS - 24" OC MAX
(2 PER DOWEL TYPICAL)



1

LINEAR LIGHT DETAIL - PLAN VIEW

1" = 1'-0"

INDEPENDENTLY SUPPORTED
CUSTOMER PROVIDED FIXTURE


FIELD CUT

DOWEL CLIPS - 24" OC MAX
(2 PER DOWEL TYPICAL)

15/16" HEAVY DUTY
T-GRID (BY OTHER)

SUSPENSION
(BY OTHER)

TRIM PLATE
RECOMMENDED
(BY OTHER)

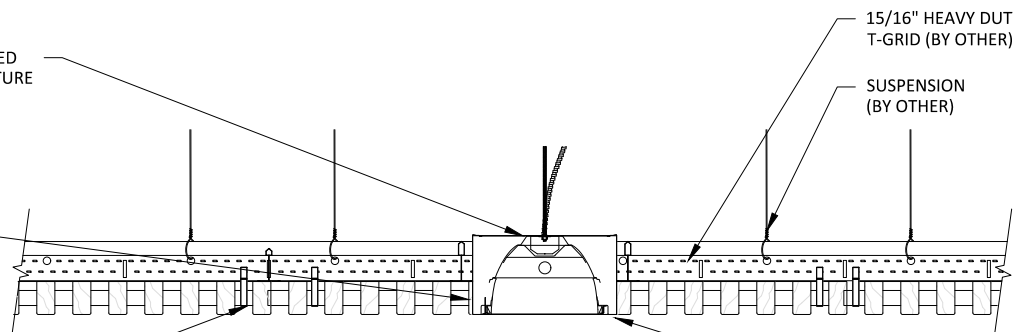

2

LINEAR LIGHT DETAIL - SECTION VIEW

1 1/2" = 1'-0"

ACOUSTICAL BACKER

TYP. WALL ASSEMBLY
(BY OTHER)

FURRING (BY OTHER) TO MATCH
ACOUSTICAL BACKER THICKNESS:
PAINTED BLACK IN FIELD

BLACK DOWEL

2" SCREW (BY OTHER) TYP.

1/2" REVEAL FOR
EXPANSION &
CONTRACTION

16 GA. FINISH NAIL (BY OTHER)

TRIM (OPTIONAL) TO COINCIDE
W/ FURRING THICKNESS; FACE
NAILED & PUTTIED IN FIELD

NOTE: 24" MAXIMUM SCREW/SUPPORT SPACING

1

HORIZONTAL WALL ISOMETRIC - TYP.

1 1/2" = 1'-0"



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Minnesota 55318 P. 800.527.6253

GRILLE-DOWELED (HORIZONTAL WALL SYSTEM) - ISOMETRIC

SCALE: AS NOTED


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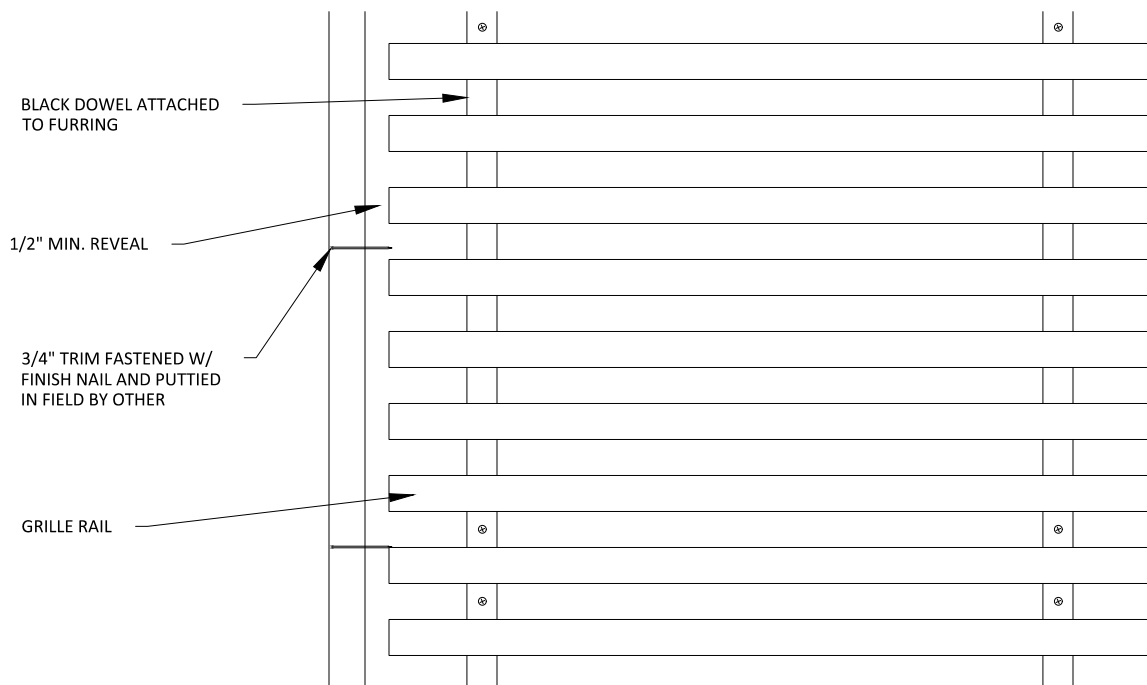
SHEET NUMBER

12

DRAWN BY: BMH



1 HORIZONTAL WALL PLAN @ TRIM
3" = 1'-0"

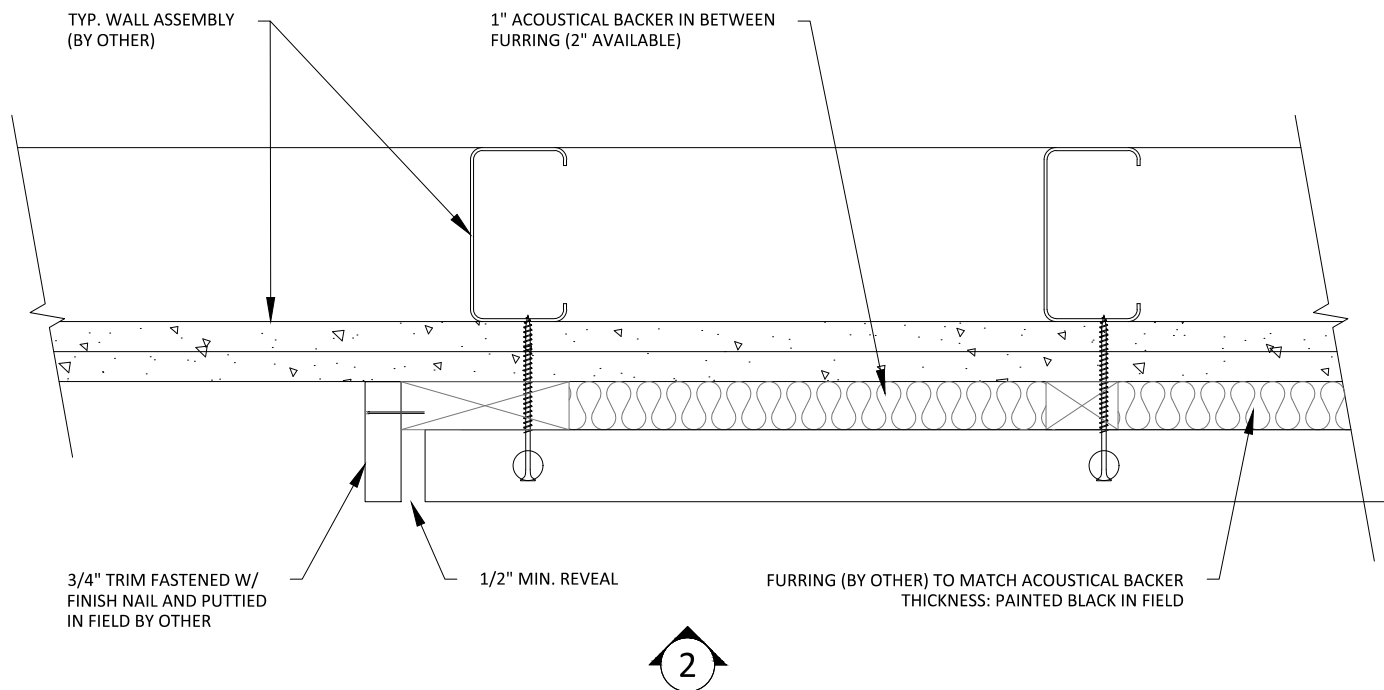

2 HORIZONTAL WALL ELEVATION @ TRIM
3" = 1'-0"

BLACK DOWEL

FURRING (BY OTHER) TO MATCH
ACOUSTICAL BACKER THICKNESS

BLACK DOWEL SCREWED
TO FURRING IN FIELD

BASE AS SCHEDULED (BY OTHER)

2

1

HORIZONTAL WALL ELEVATION @ BASEBOARD

3" = 1'-0"

1" ACOUSTICAL BACKER (2" AVAILABLE)

BLACK DOWEL SCREWED
TO FURRING IN FIELD

TYP. WALL SYSTEM (BY OTHER)

BASE AS SCHEDULED (BY OTHER)

2


HORIZONTAL WALL SECTION @ BASEBOARD

3" = 1'-0"

BLACK DOWEL SCREWED
TO FURRING IN FIELD

FURRING (BY OTHER) TO MATCH
ACOUSTICAL BACKER THICKNESS

OUTLET PENETRATION FIELD CUT

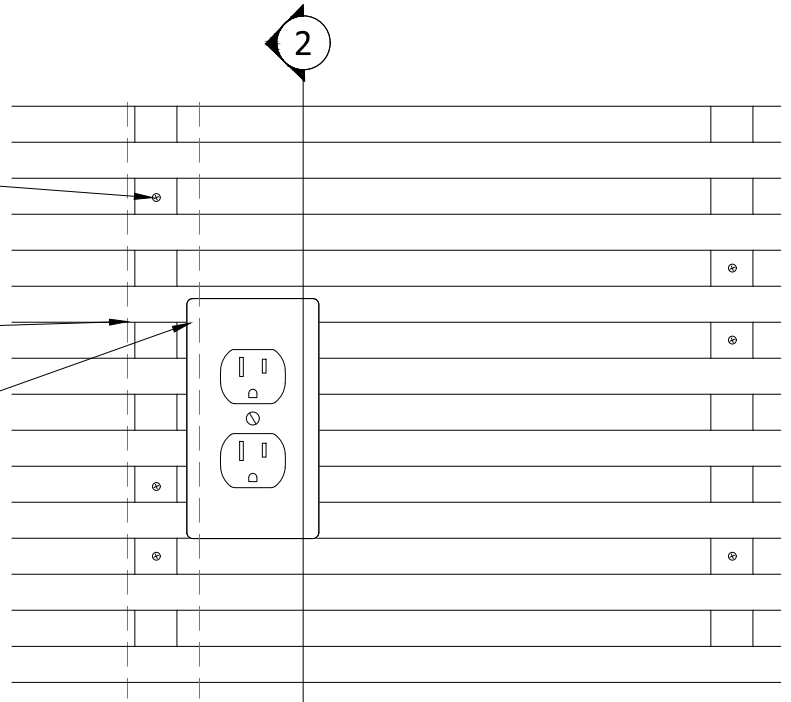

1

HORIZONTAL WALL ELEVATION @ OUTLET


3" = 1'-0"

1" ACOUSTICAL BACKER (2" AVAILABLE)

OUTLET PENETRATION FIELD CUT

BLACK DOWEL SCREWED
TO FURRING IN FIELD

TYP. WALL SYSTEM (BY OTHER)

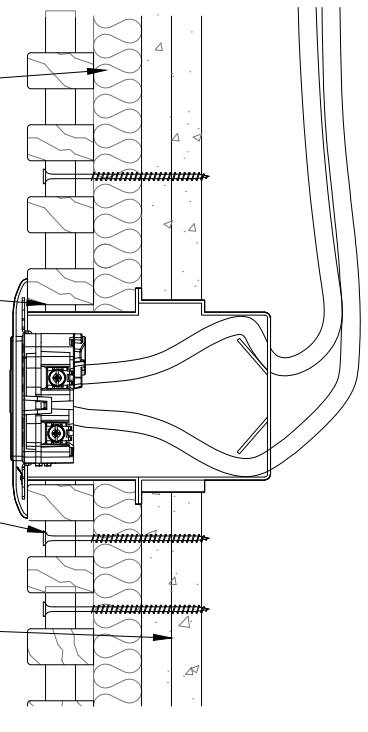

2

HORIZONTAL WALL SECTION @ OUTLET

3" = 1'-0"

GRILLE-DOWELED (HORIZONTAL WALL SYSTEM) - OUTLET DETAILS

SCALE: AS NOTED

LAST REVISED: 5/16/2023

SHEET NUMBER


15

DRAWN BY: BMH

BLACK DOWEL SCREWED
TO FURRING IN FIELD

FURRING (BY OTHER) TO MATCH
ACOUSTICAL BACKER THICKNESS

LIGHT SWITCH PENETRATION FIELD CUT

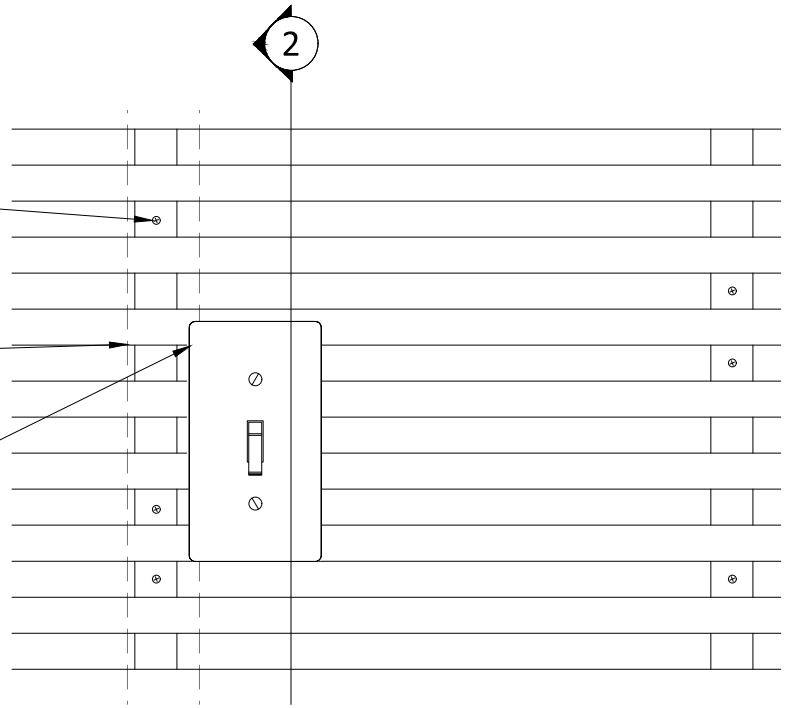

1 HORIZONTAL WALL ELEVATION @ LIGHT SWITCH


3" = 1'-0"

1" ACOUSTICAL BACKER (2" AVAILABLE)

LIGHT SWITCH PENETRATION FIELD CUT


BLACK DOWEL SCREWED
TO FURRING IN FIELD

TYP. WALL SYSTEM (BY OTHER)

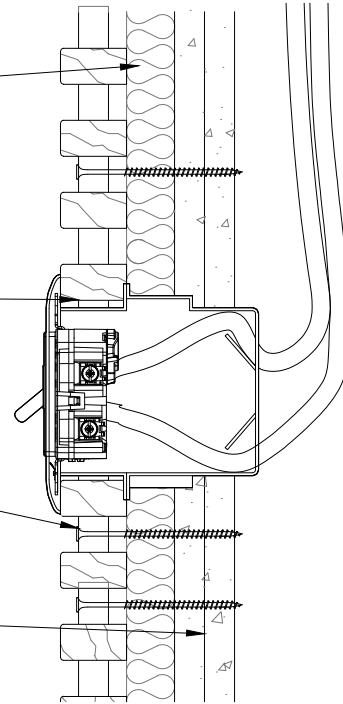


2 HORIZONTAL WALL SECTION @ LIGHT SWITCH


3" = 1'-0"

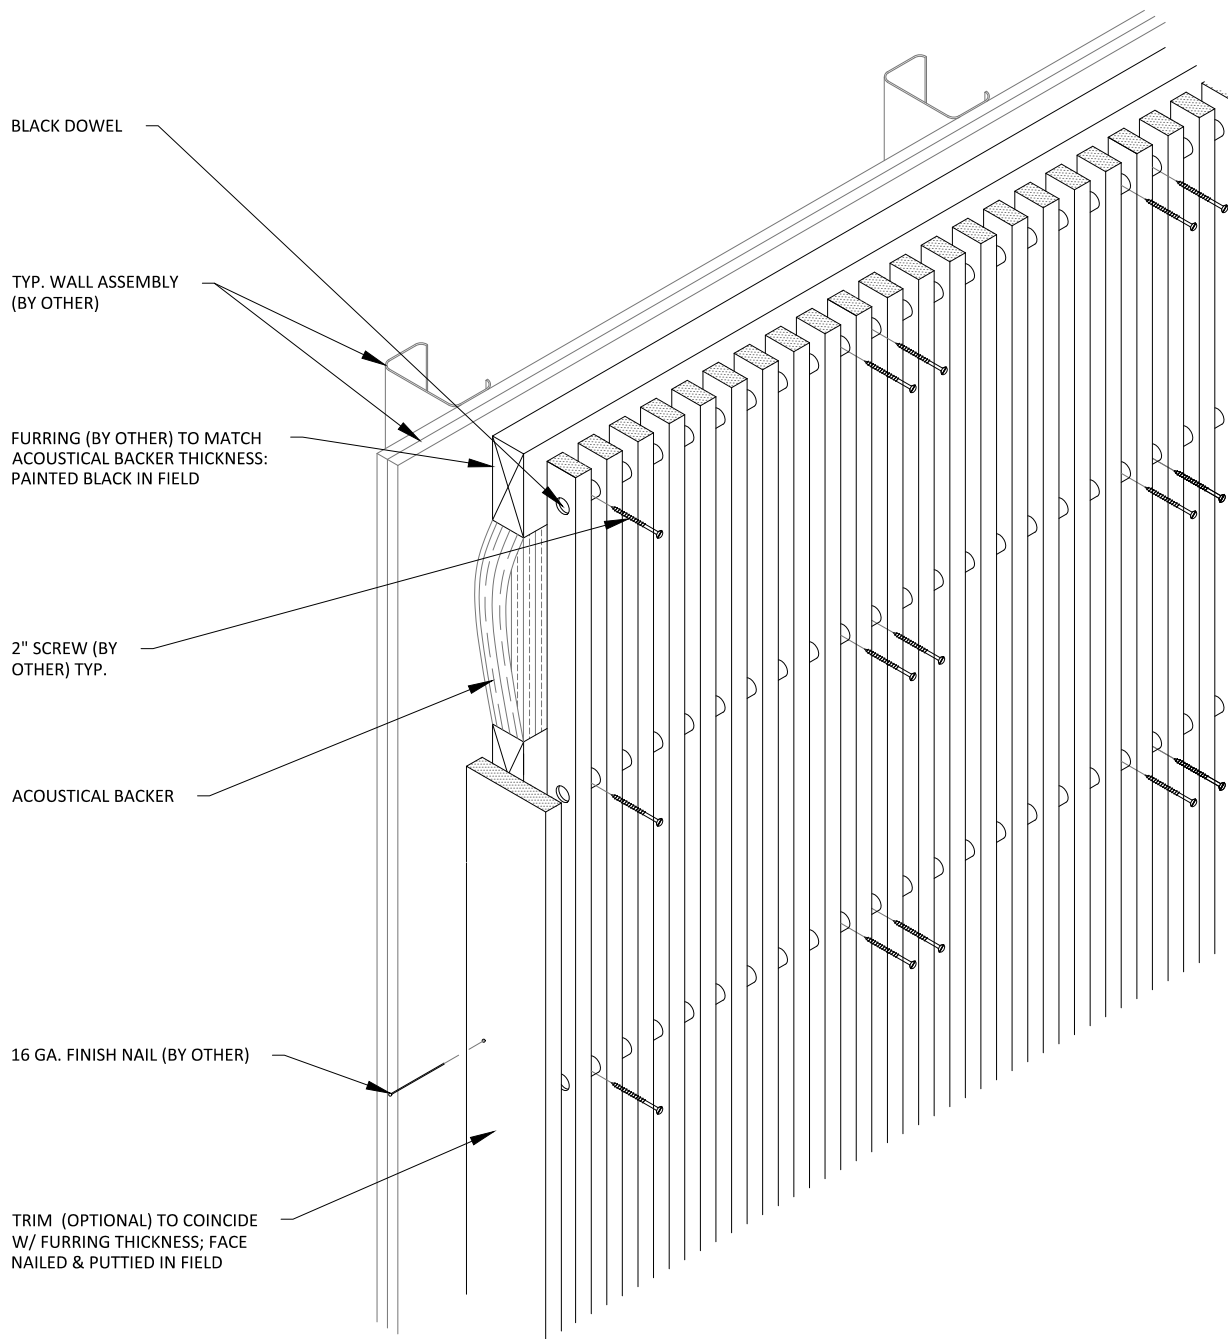


1 VERTICAL WALL ISOMETRIC - TYP.
1 1/2" = 1'-0"

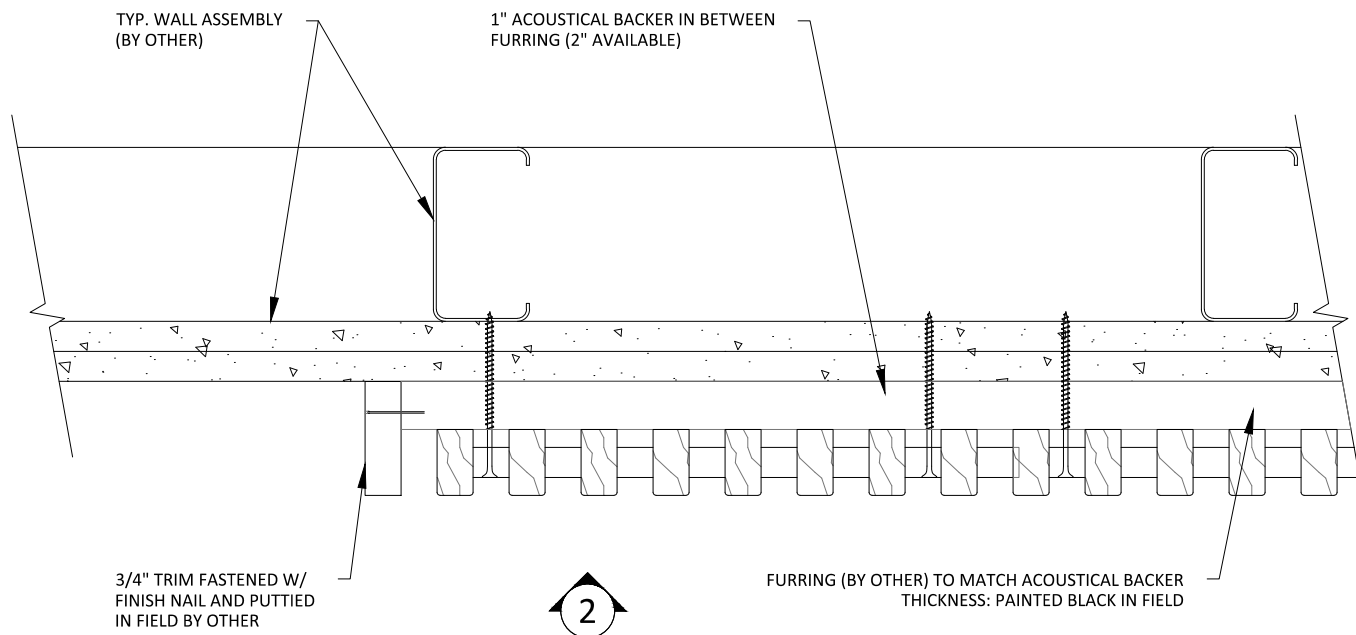


1 VERTICAL WALL PLAN @ TRIM
3" = 1'-0"

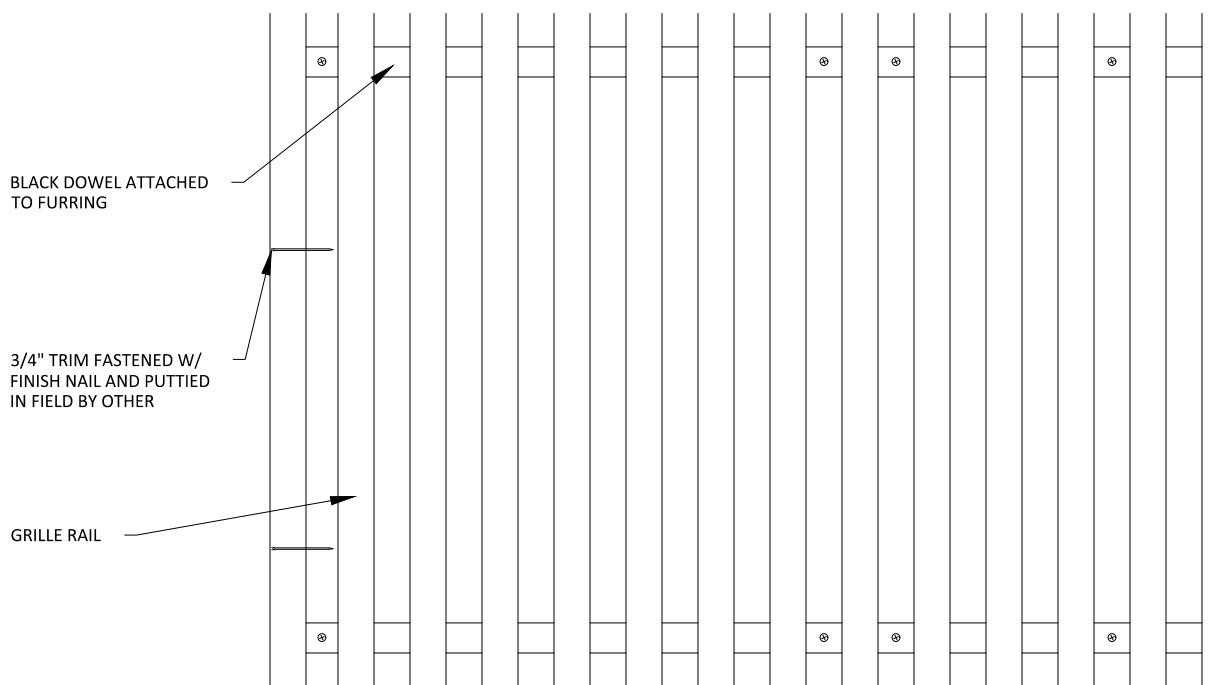


2 VERTICAL WALL ELEVATION @ TRIM
3" = 1'-0"

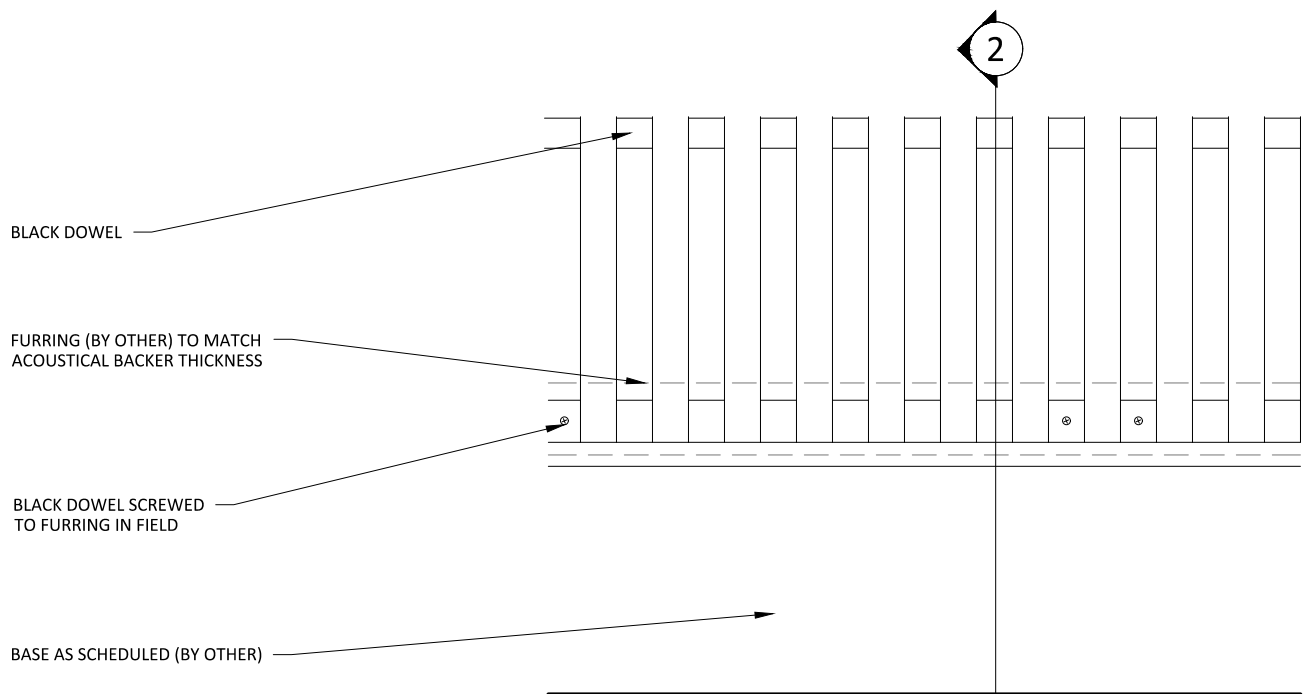


1 VERTICAL WALL ELEVATION @ BASEBOARD 3" = 1'-0"

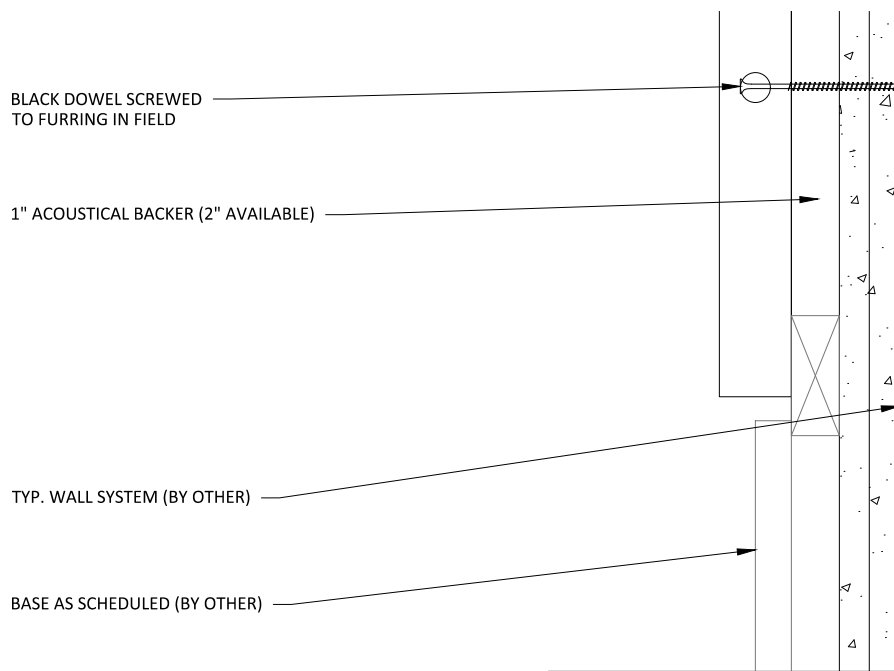


2 VERTICAL WALL SECTION @ BASEBOARD 3" = 1'-0"

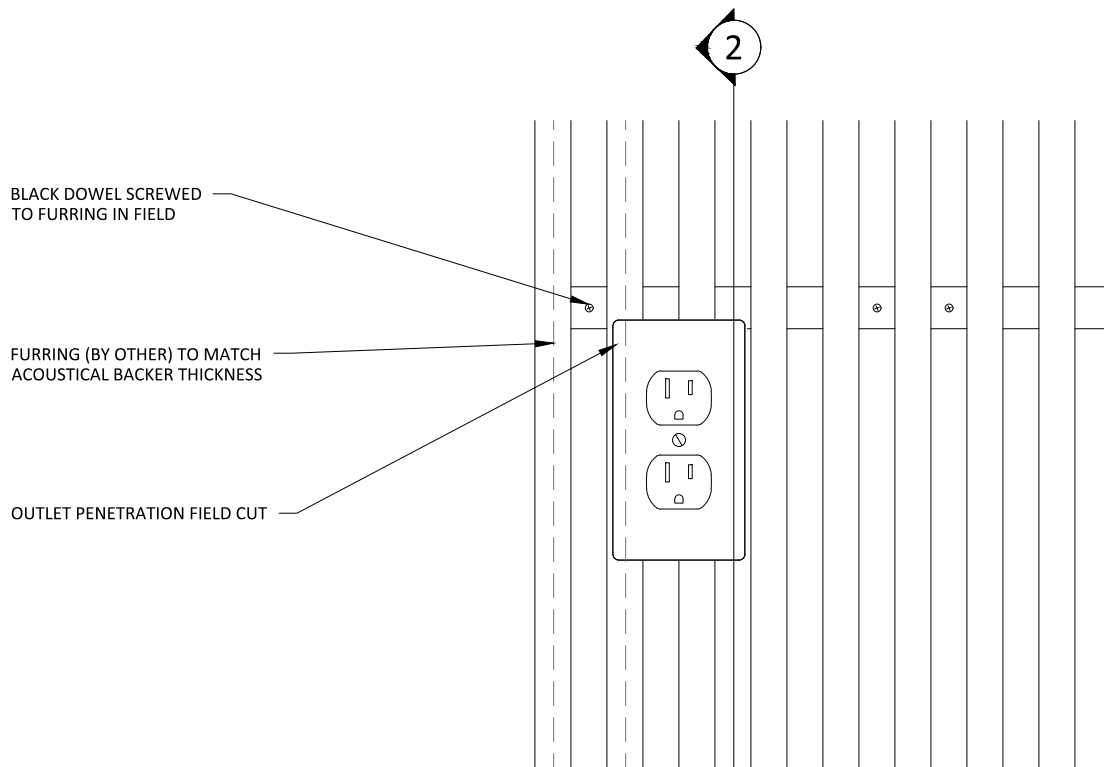


1 VERTICAL WALL ELEVATION @ OUTLET
3" = 1'-0"

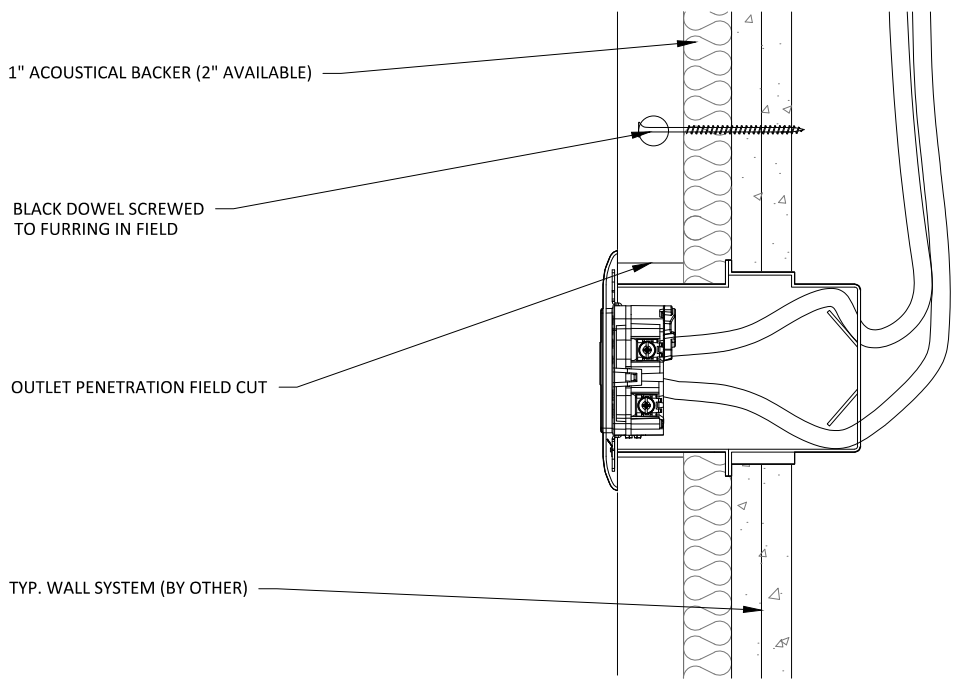


2 VERTICAL WALL SECTION @ OUTLET
3" = 1'-0"

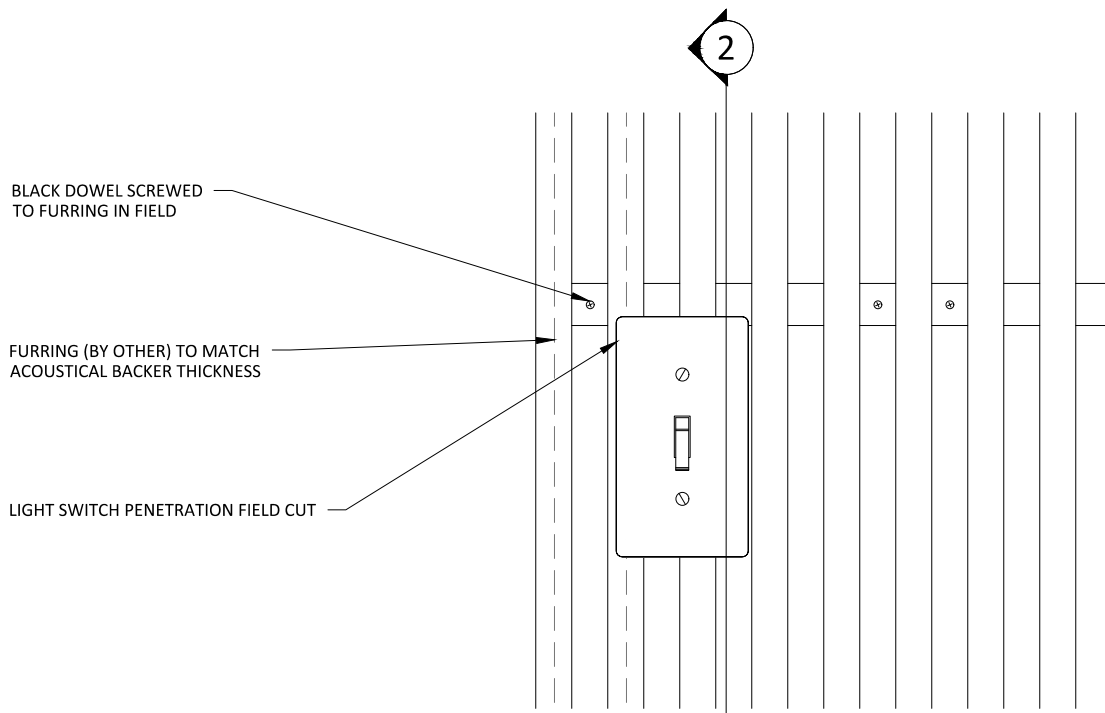


1 VERTICAL WALL ELEVATION @ LIGHT SWITCH
3" = 1'-0"

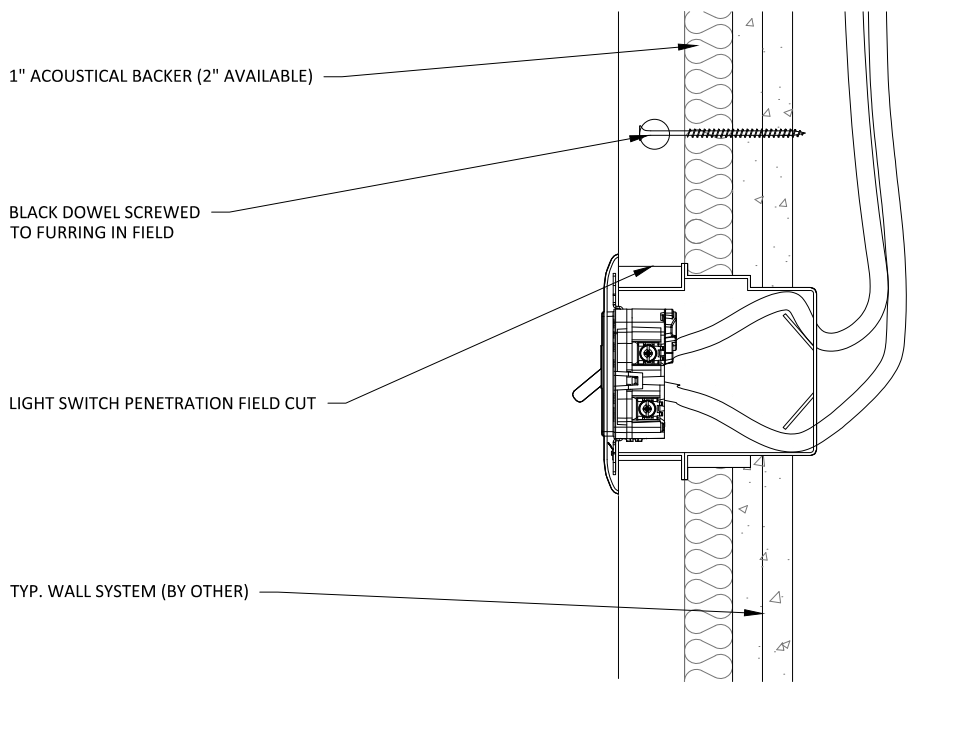


2 VERTICAL WALL SECTION @ LIGHT SWITCH
3" = 1'-0"

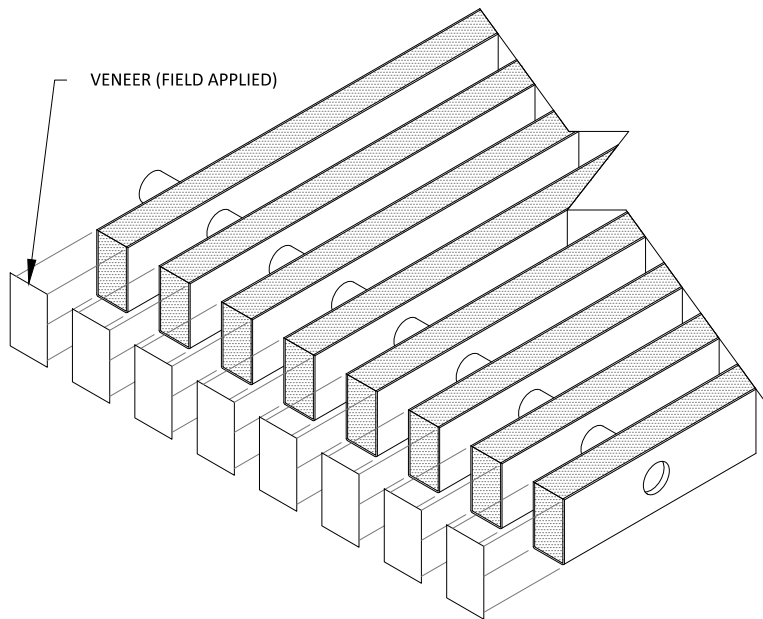

1 STEP 1
3" = 1'-0"

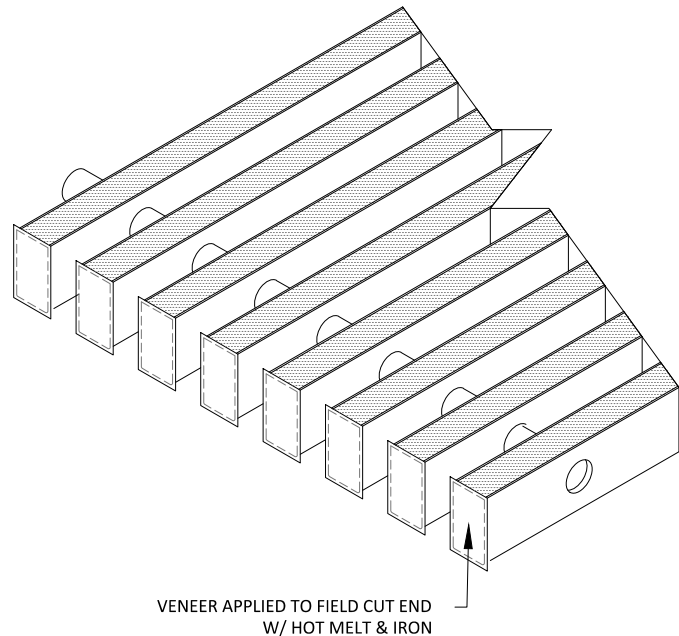

2 STEP 2
3" = 1'-0"

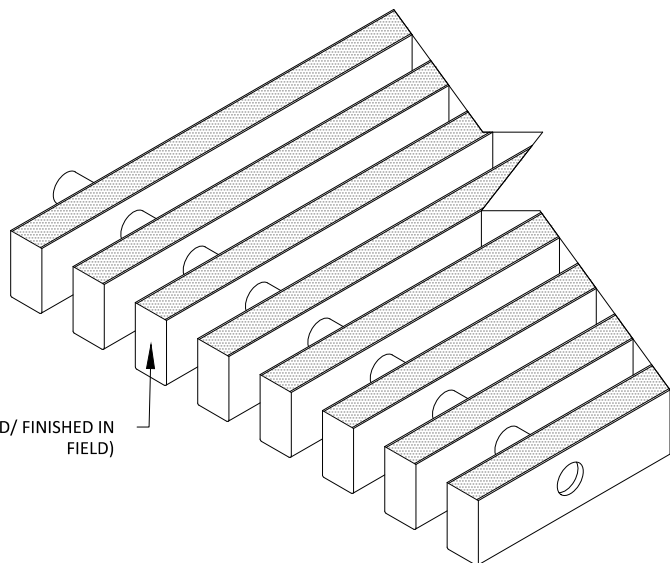

3 STEP 3
3" = 1'-0"

NOTE: FOR SOLID WOOD RAILS, NO VENEER NEEDS TO BE APPLIED - INSTEAD, REFINISH THE CUT END IN FIELD