




**1** TYPICAL SECTION VIEW  
3" = 1'-0"

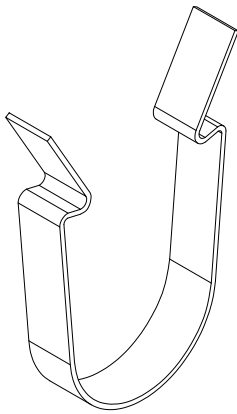

ISOMETRIC

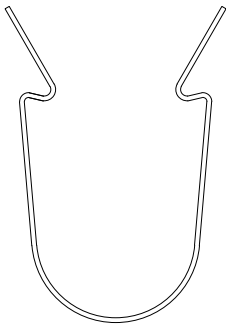


ELEVATION

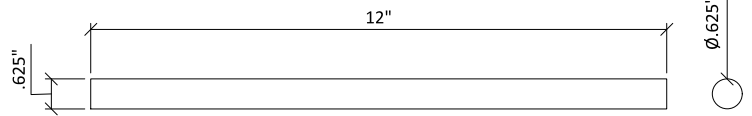


**2** DOWEL CLIP  
1' = 1'-0"

**3** BLACK DOWEL  
3" = 1'-0"

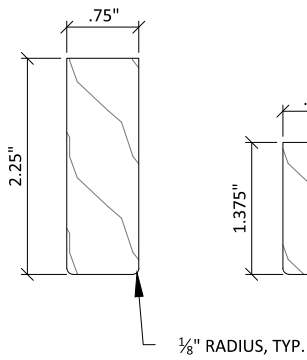





SOLID WOOD RAIL

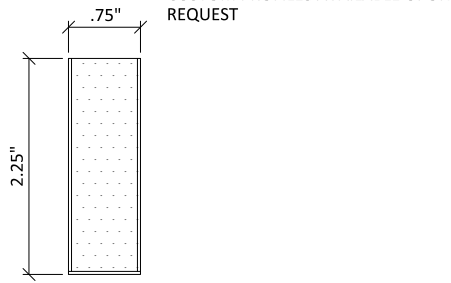

VENEERED RAIL


## 1 TYPICAL RAIL PROFILES

6" = 1'-0"

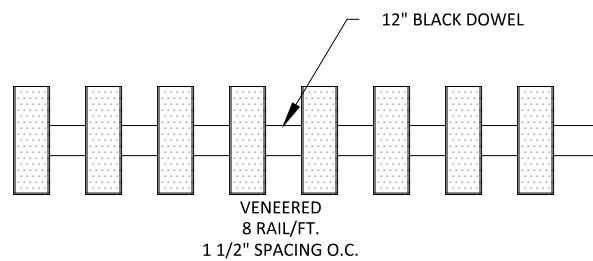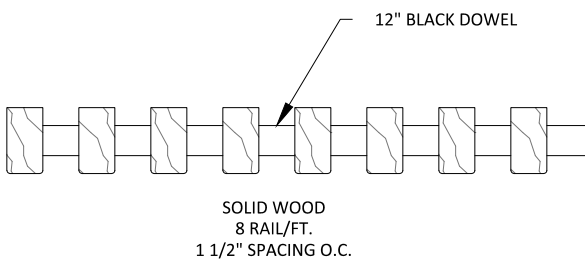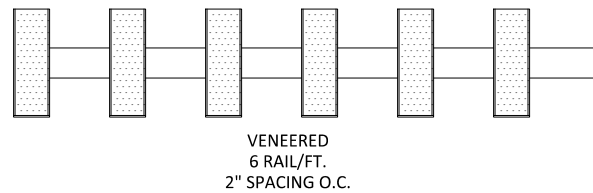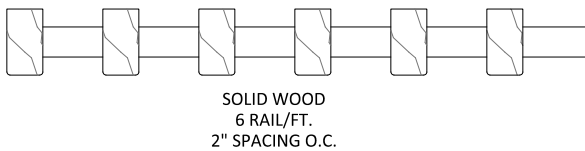


## 2 TYPICAL 12 INCH MODULES

3" = 1'-0"

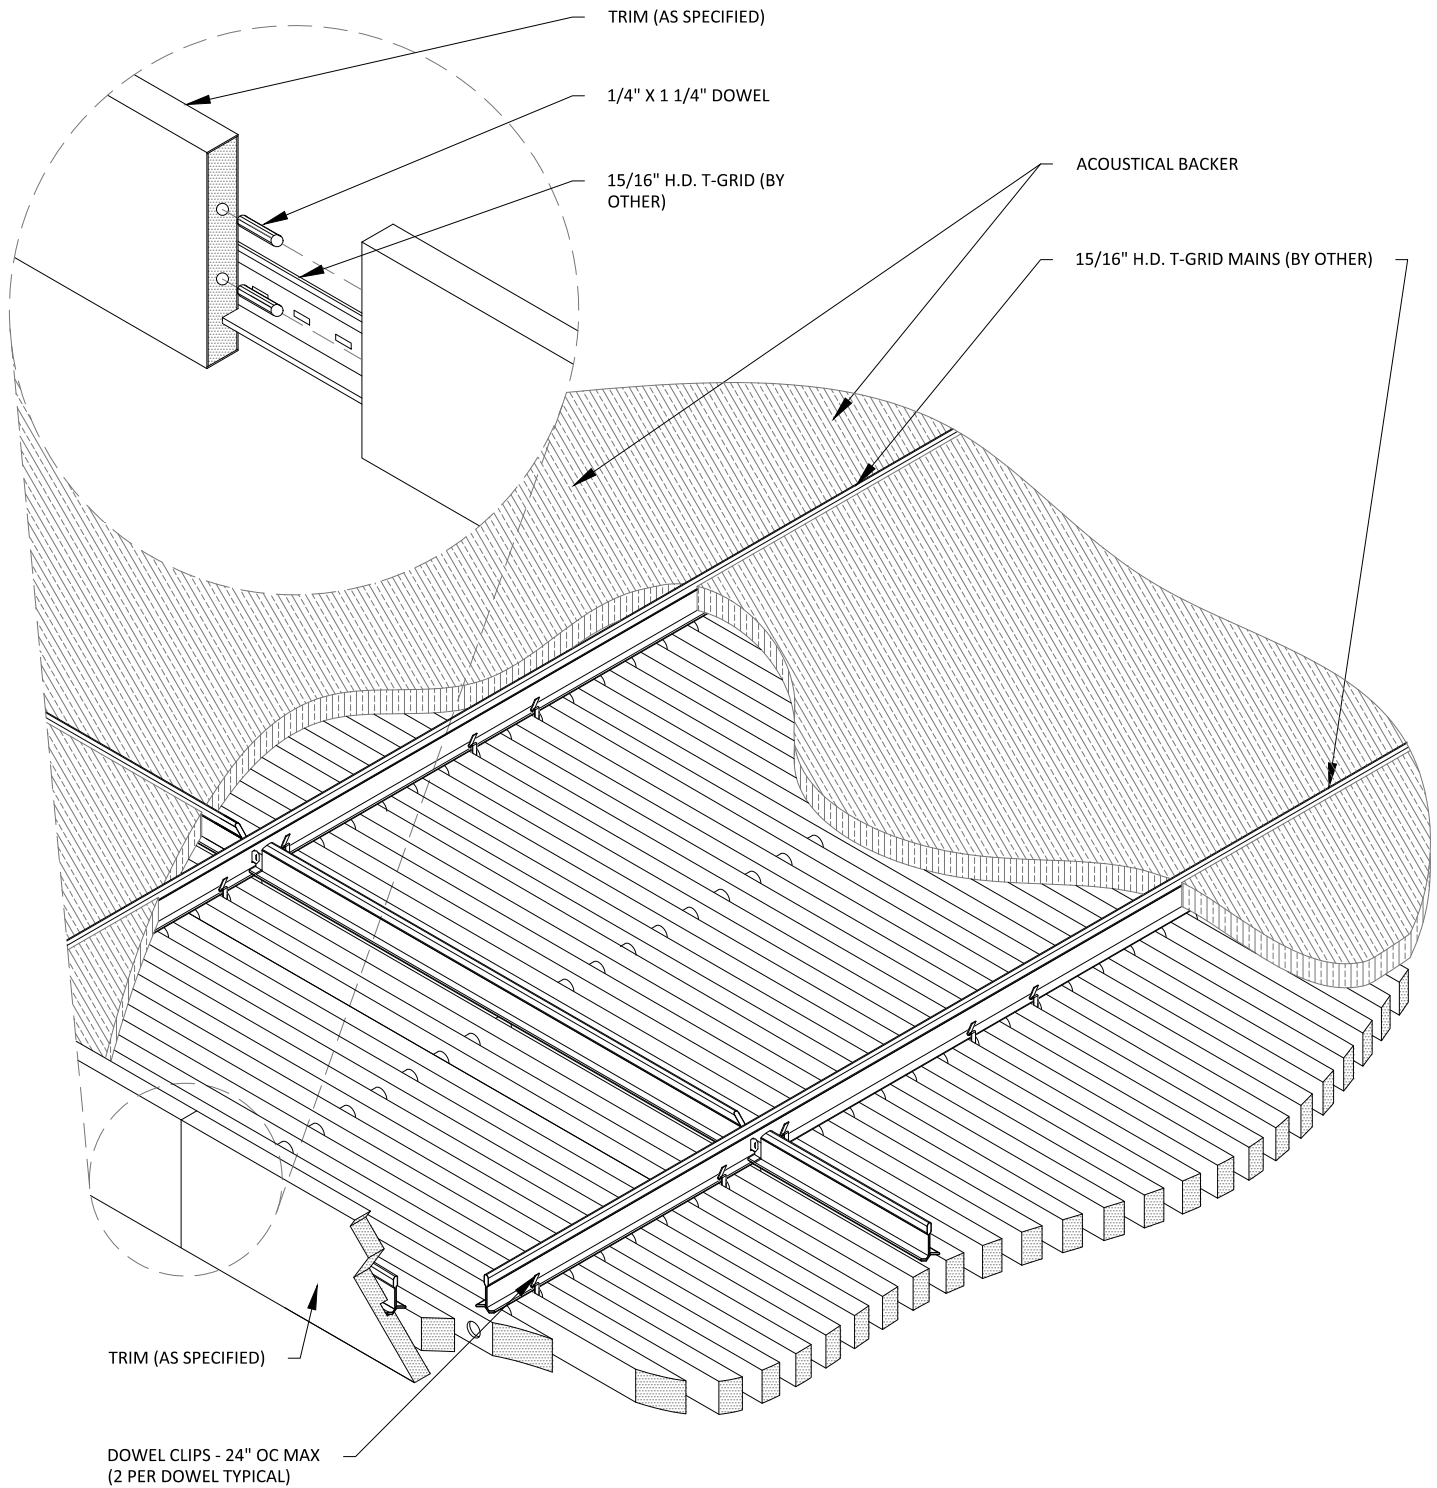


1 CEILING ISOMETRIC - TYP.  
1 1/2" = 1'-0"

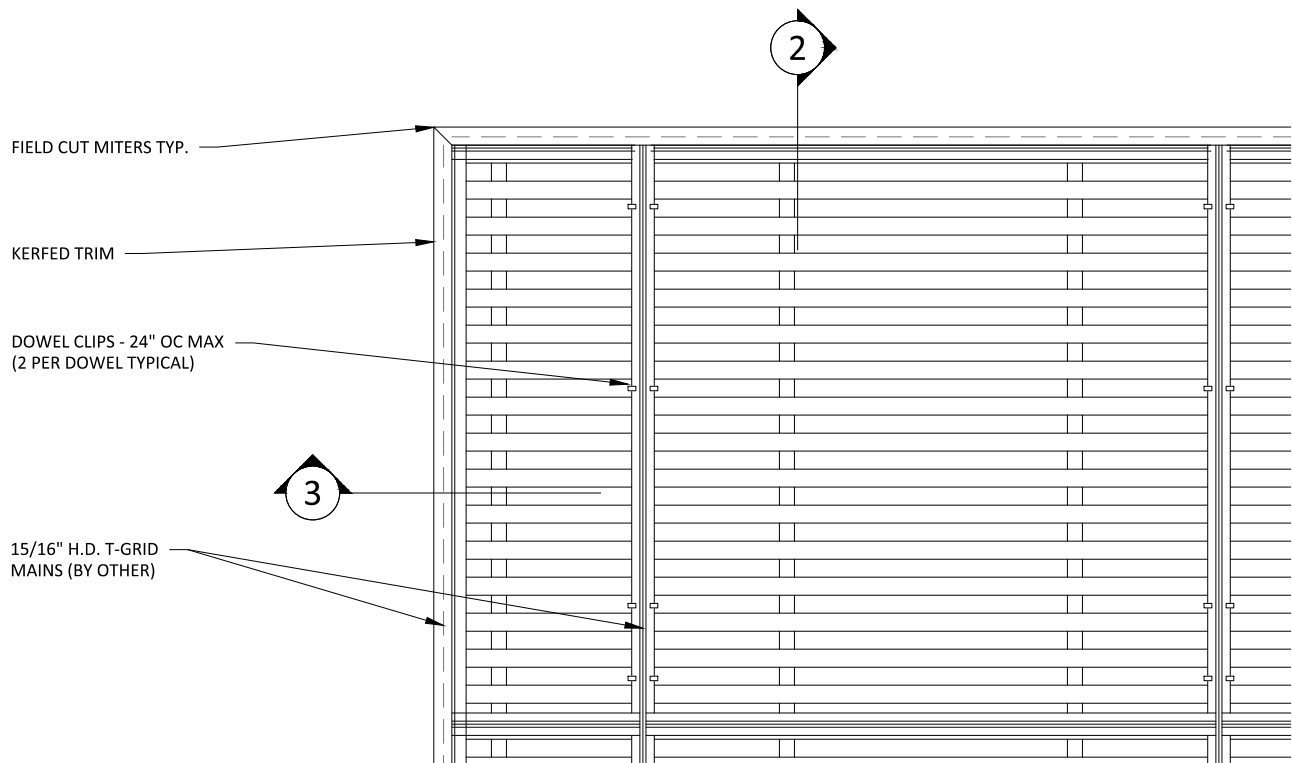


**1 TRIM @ MITERED CORNER - PLAN**  
1 1/2" = 1'-0"

\*\* ALL FIELD CUTS TO ALLOW FOR 1/4" MIN REVEAL FOR EXPANSION & CONTRACTION

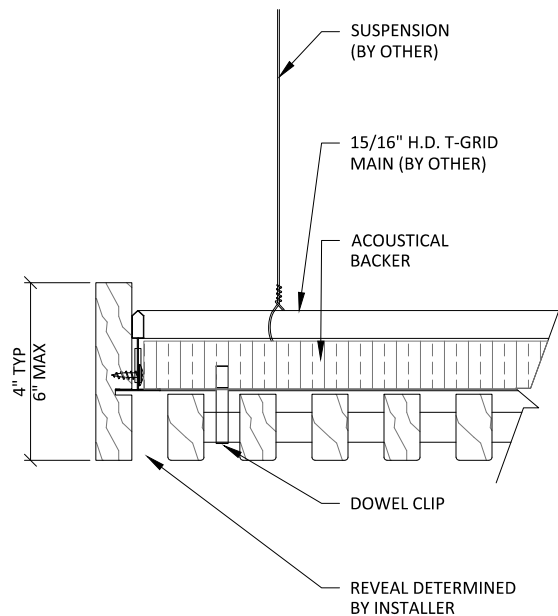


**2 TRIM DETAIL 1**  
3" = 1'-0"

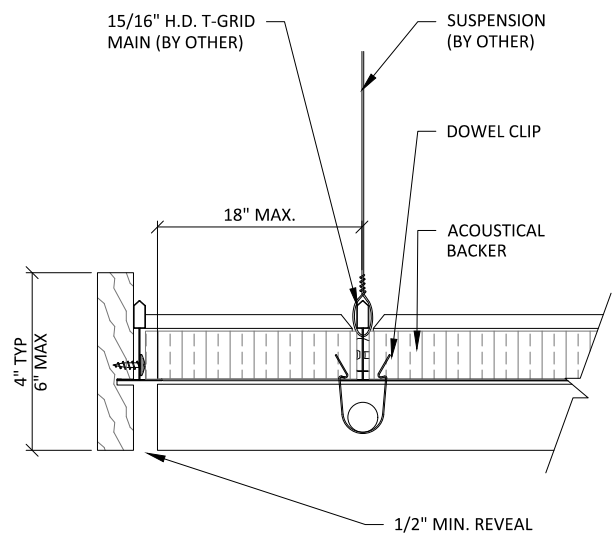


**3 TRIM DETAIL 2**  
3" = 1'-0"


\*\* ALL FIELD CUTS TO ALLOW FOR 1/4" MIN  
REVEAL FOR EXPANSION & CONTRACTION

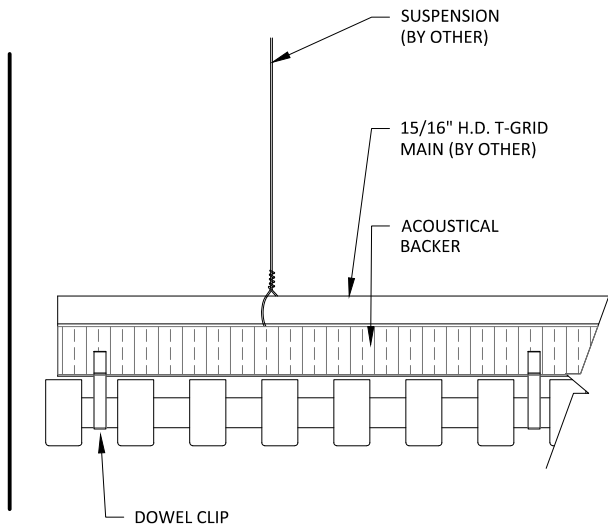


1 EDGE DETAIL 1  
3" = 1'-0"

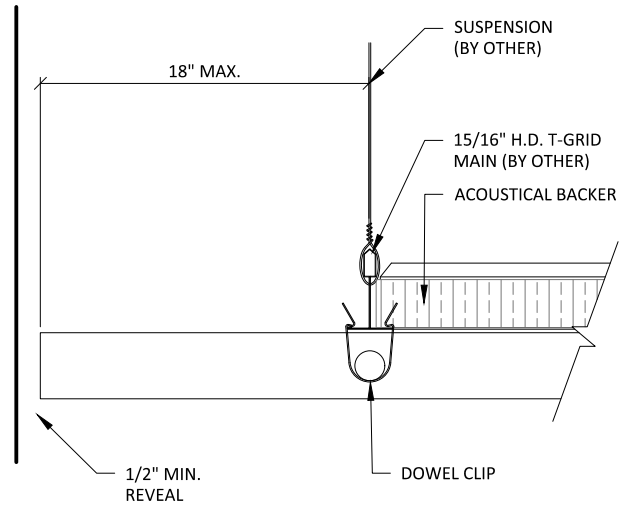

2 EDGE DETAIL 2  
3" = 1'-0"

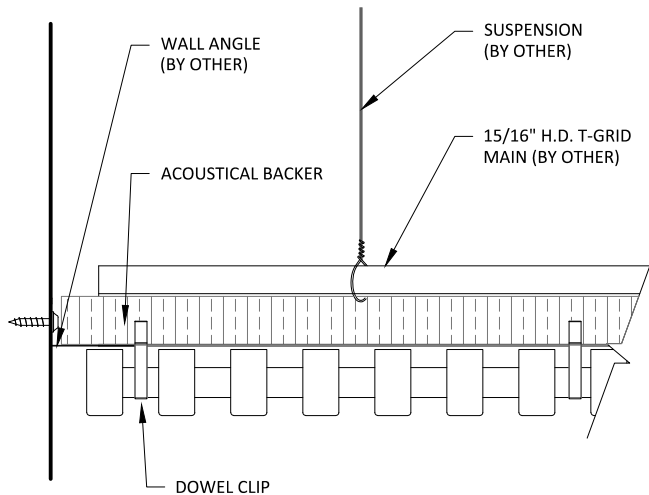

3 EDGE DETAIL 3  
3" = 1'-0"

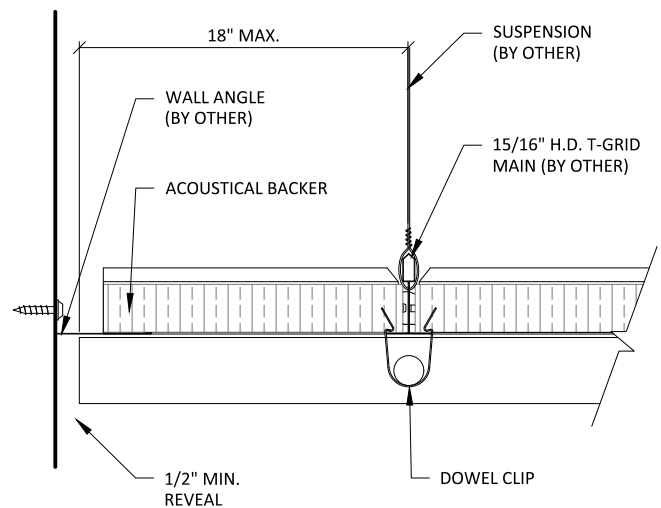

4 EDGE DETAIL 4  
3" = 1'-0"

15/16" HEAVY DUTY  
T-GRID (BY OTHER)  
(2X4 LAYOUT TYP)

INDEPENDENTLY SUPPORTED  
CUSTOMER PROVIDED FIXTURE:  
FIELD CUT PENETRATION


BLACK DOWEL

DOWEL CLIPS - 24" OC MAX  
(2 PER DOWEL TYPICAL)

2

## 1 SPRINKLER HEAD DETAIL - PLAN VIEW

1 1/2" = 1'-0"

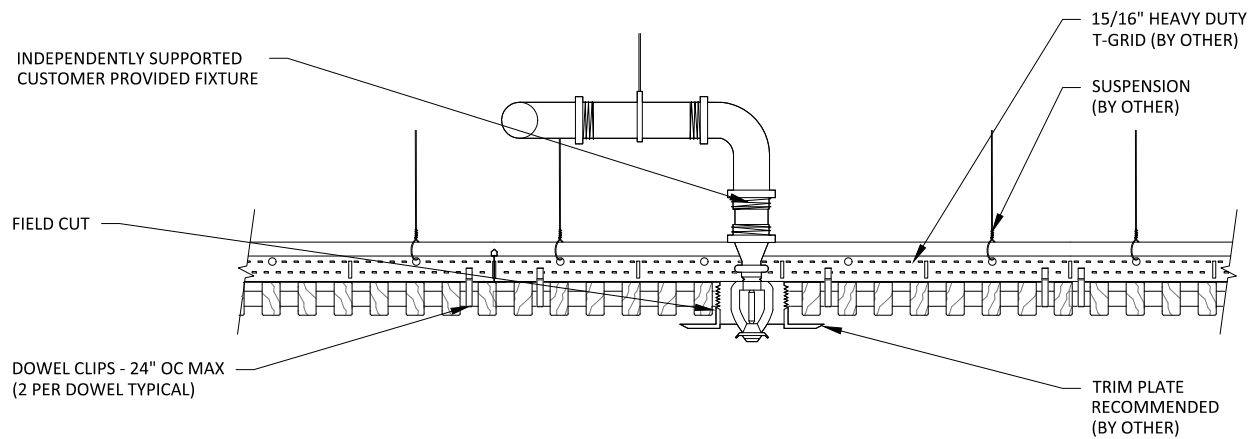

## 2 SPRINKLER HEAD DETAIL - SECTION VIEW

1 1/2" = 1'-0"

# GRILLE-DOWELED (CEILING SYSTEM) - SPRINKLER HEAD DETAILS

SCALE: AS NOTED

LAST REVISED: 5/16/2023

SHEET NUMBER

6


DRAWN BY: BMH

15/16" HEAVY DUTY  
T-GRID (BY OTHER)  
(2X4 LAYOUT TYP)

INDEPENDENTLY SUPPORTED  
CUSTOMER PROVIDED FIXTURE:  
FIELD CUT PENETRATION

BLACK DOWEL

DOWEL CLIPS - 24" OC MAX  
(2 PER DOWEL TYPICAL)

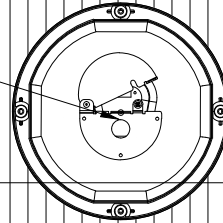

2

1

#### CAN LIGHT DETAIL - PLAN VIEW

1 1/2" = 1'-0"

INDEPENDENTLY SUPPORTED  
CUSTOMER PROVIDED FIXTURE

FIELD CUT

DOWEL CLIPS - 24" OC MAX  
(2 PER DOWEL TYPICAL)

15/16" HEAVY DUTY  
T-GRID (BY OTHER)

SUSPENSION  
(BY OTHER)

TRIM PLATE  
RECOMMENDED  
(BY OTHER)

2

#### CAN LIGHT DETAIL - SECTION VIEW

1 1/2" = 1'-0"

## GRILLE-DOWELED (CEILING SYSTEM) - CAN LIGHT DETAILS

SHEET NUMBER


7

SCALE: AS NOTED


LAST REVISED: 5/16/2023

DRAWN BY: BMH

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**1** PENDANT LIGHT DETAIL - PLAN VIEW  
1 1/2" = 1'-0"

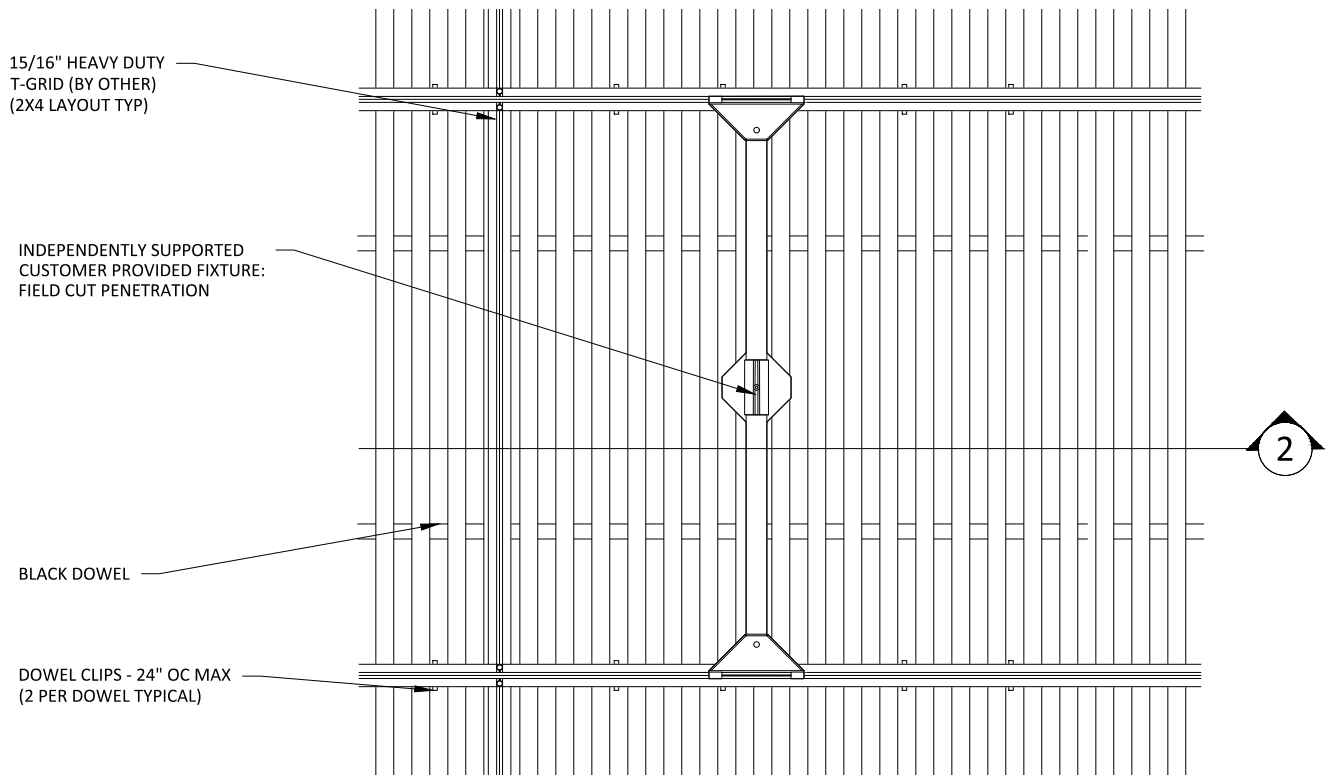

**2** PENDANT LIGHT DETAIL - SECTION VIEW  
1 1/2" = 1'-0"

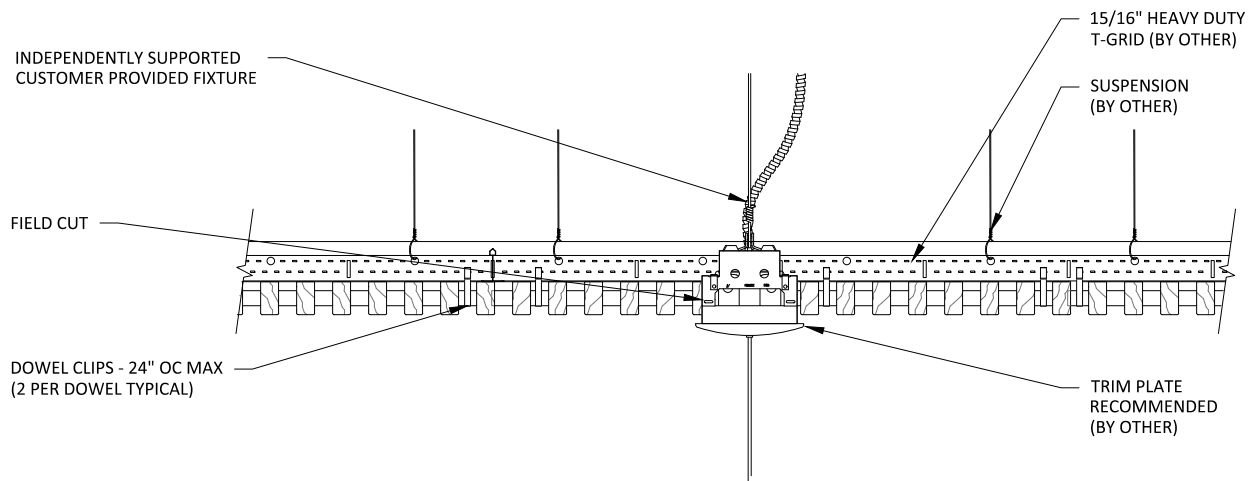


15/16" HEAVY DUTY  
T-GRID (BY OTHER)  
(2X4 LAYOUT TYP)

INDEPENDENTLY SUPPORTED  
CUSTOMER PROVIDED FIXTURE:  
FIELD CUT PENETRATION

BLACK DOWEL

DOWEL CLIPS - 24" OC MAX  
(2 PER DOWEL TYPICAL)

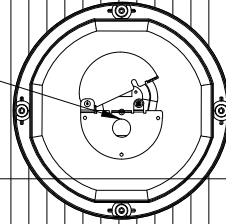

2

## 1 RECESSED SPEAKER DETAIL - PLAN VIEW

1 1/2" = 1'-0"

INDEPENDENTLY SUPPORTED  
CUSTOMER PROVIDED FIXTURE


FIELD CUT

DOWEL CLIPS - 24" OC MAX  
(2 PER DOWEL TYPICAL)

15/16" HEAVY DUTY  
T-GRID (BY OTHER)

SUSPENSION  
(BY OTHER)

TRIM PLATE  
RECOMMENDED  
(BY OTHER)

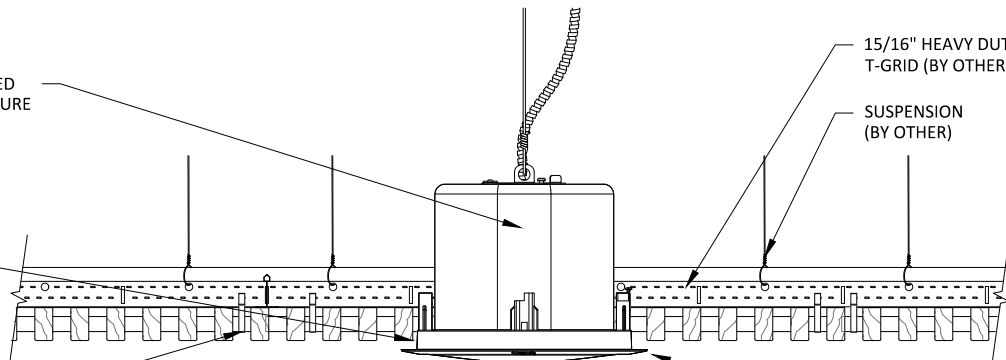

## 2 RECESSED SPEAKER DETAIL - SECTION VIEW

1 1/2" = 1'-0"

# GRILLE-DOWELED (CEILING SYSTEM) - RECESSED SPEAKER DETAILS

SCALE: AS NOTED

LAST REVISED: 5/16/2023

SHEET NUMBER

9

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15/16" HEAVY DUTY  
T-GRID (BY OTHER)  
(2X4 LAYOUT TYP)

INDEPENDENTLY SUPPORTED  
CUSTOMER PROVIDED FIXTURE:  
FIELD CUT PENETRATION

BLACK DOWEL

DOWEL CLIPS - 24" OC MAX  
(2 PER DOWEL TYPICAL)

2

1

#### DIFFUSER DETAIL - PLAN VIEW

1 1/2" = 1'-0"

INDEPENDENTLY SUPPORTED  
CUSTOMER PROVIDED FIXTURE

FIELD CUT

DOWEL CLIPS - 24" OC MAX  
(2 PER DOWEL TYPICAL)

15/16" HEAVY DUTY  
T-GRID (BY OTHER)

SUSPENSION  
(BY OTHER)

TRIM PLATE  
RECOMMENDED  
(BY OTHER)

2

#### DIFFUSER DETAIL - SECTION VIEW

1 1/2" = 1'-0"

## GRILLE-DOWELED (CEILING SYSTEM) - DIFFUSER DETAILS

SHEET NUMBER

10

SCALE: AS NOTED

LAST REVISED: 5/16/2023

DRAWN BY: BMH

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15/16" HEAVY DUTY  
T-GRID (BY OTHER)  
(2X4 LAYOUT TYP)

INDEPENDENTLY SUPPORTED  
LINEAR LIGHT: FIELD CUT  
PENETRATION

STUB-IN GRID AS NECESSARY

BLACK DOWEL

DOWEL CLIPS - 24" OC MAX  
(2 PER DOWEL TYPICAL)

2

# 1 LINEAR LIGHT DETAIL - PLAN VIEW

1" = 1'-0"

INDEPENDENTLY SUPPORTED  
CUSTOMER PROVIDED FIXTURE

FIELD CUT

DOWEL CLIPS - 24" OC MAX  
(2 PER DOWEL TYPICAL)

15/16" HEAVY DUTY  
T-GRID (BY OTHER)

SUSPENSION  
(BY OTHER)

TRIM PLATE  
RECOMMENDED  
(BY OTHER)

# 2 LINEAR LIGHT DETAIL - SECTION VIEW

1 1/2" = 1'-0"

ACOUSTICAL BACKER

TYP. WALL ASSEMBLY  
(BY OTHER)

FURRING (BY OTHER) TO MATCH  
ACOUSTICAL BACKER THICKNESS:  
PAINTED BLACK IN FIELD

BLACK DOWEL

2" SCREW (BY OTHER) TYP.

1/2" REVEAL FOR  
EXPANSION &  
CONTRACTION

16 GA. FINISH NAIL (BY OTHER)


TRIM (OPTIONAL) TO COINCIDE  
W/ FURRING THICKNESS; FACE  
NAILED & PUTTIED IN FIELD

NOTE: 24" MAXIMUM SCREW/SUPPORT SPACING


1

HORIZONTAL WALL ISOMETRIC - TYP.

1 1/2" = 1'-0"

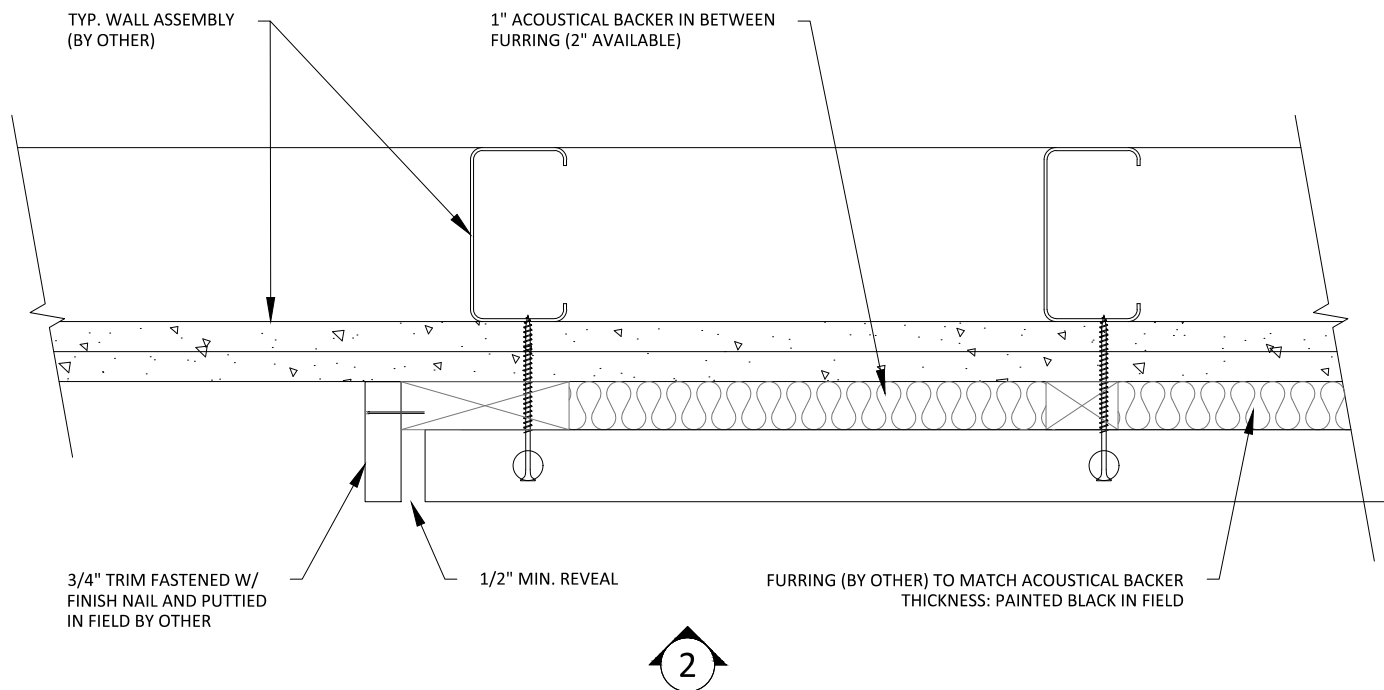

1 HORIZONTAL WALL PLAN @ TRIM  
3" = 1'-0"

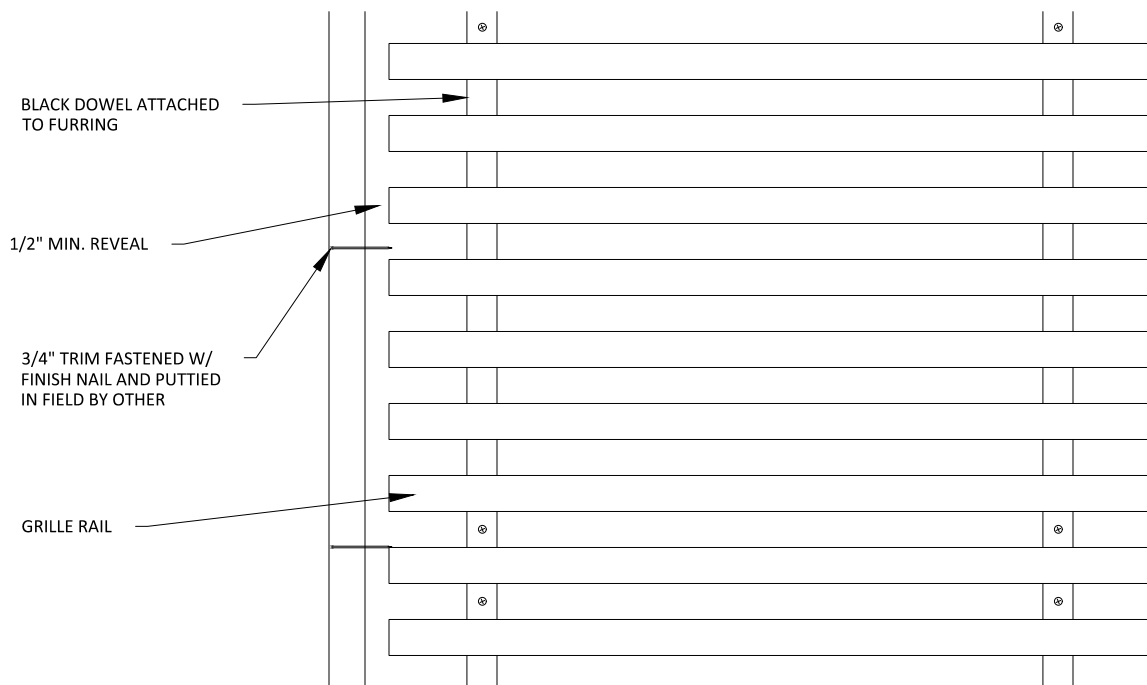

2 HORIZONTAL WALL ELEVATION @ TRIM  
3" = 1'-0"

BLACK DOWEL

FURRING (BY OTHER) TO MATCH  
ACOUSTICAL BACKER THICKNESS

BLACK DOWEL SCREWED  
TO FURRING IN FIELD

BASE AS SCHEDULED (BY OTHER)

2

# 1 HORIZONTAL WALL ELEVATION @ BASEBOARD

3" = 1'-0"

1" ACOUSTICAL BACKER (2" AVAILABLE)

BLACK DOWEL SCREWED  
TO FURRING IN FIELD

TYP. WALL SYSTEM (BY OTHER)

BASE AS SCHEDULED (BY OTHER)


# 2 HORIZONTAL WALL SECTION @ BASEBOARD

3" = 1'-0"

BLACK DOWEL SCREWED  
TO FURRING IN FIELD

FURRING (BY OTHER) TO MATCH  
ACOUSTICAL BACKER THICKNESS

OUTLET PENETRATION FIELD CUT

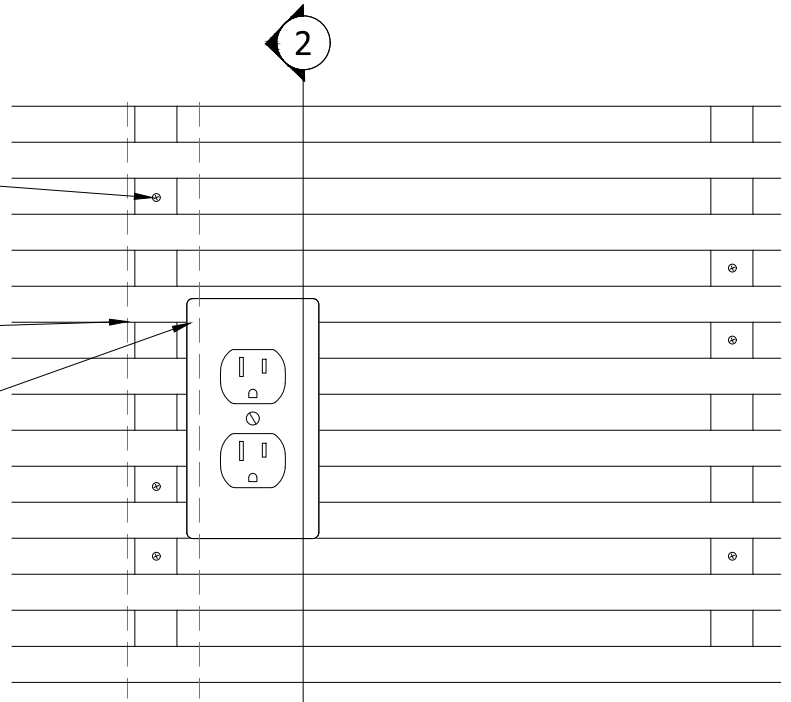

1

# HORIZONTAL WALL ELEVATION @ OUTLET


3" = 1'-0"

1" ACOUSTICAL BACKER (2" AVAILABLE)

OUTLET PENETRATION FIELD CUT

BLACK DOWEL SCREWED  
TO FURRING IN FIELD

TYP. WALL SYSTEM (BY OTHER)

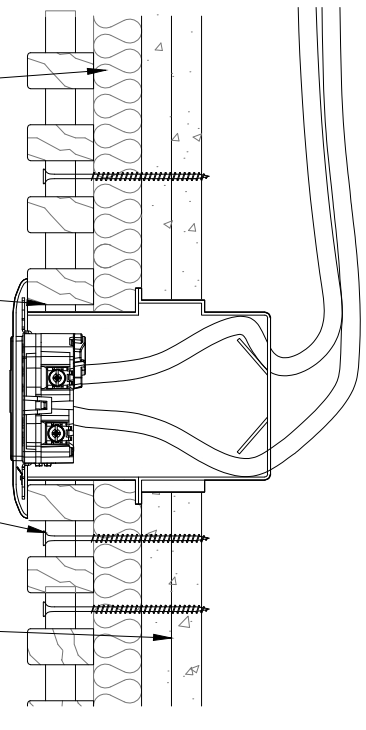

2

# HORIZONTAL WALL SECTION @ OUTLET

3" = 1'-0"

## GRILLE-DOWELED (HORIZONTAL WALL SYSTEM) - OUTLET DETAILS

SCALE: AS NOTED

LAST REVISED: 5/16/2023

SHEET NUMBER


15

DRAWN BY: BMH

BLACK DOWEL SCREWED  
TO FURRING IN FIELD

FURRING (BY OTHER) TO MATCH  
ACOUSTICAL BACKER THICKNESS

LIGHT SWITCH PENETRATION FIELD CUT

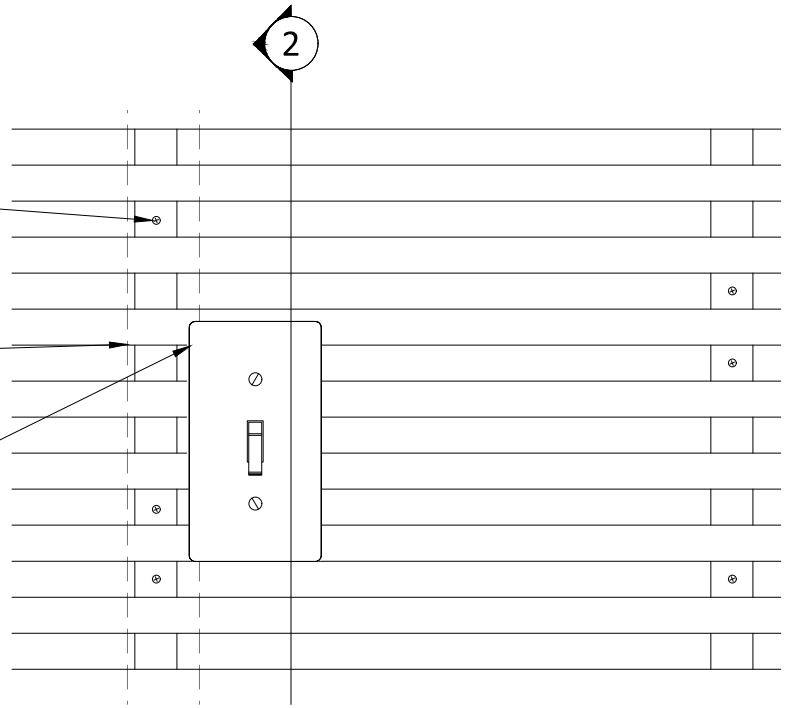

## 1 HORIZONTAL WALL ELEVATION @ LIGHT SWITCH


3" = 1'-0"

1" ACOUSTICAL BACKER (2" AVAILABLE)

LIGHT SWITCH PENETRATION FIELD CUT

BLACK DOWEL SCREWED  
TO FURRING IN FIELD


TYP. WALL SYSTEM (BY OTHER)

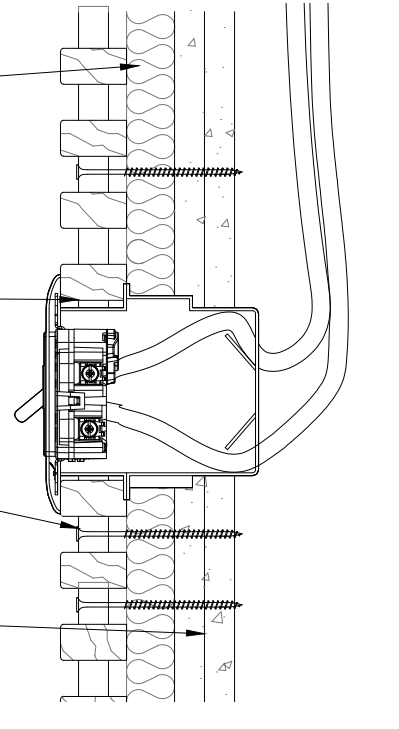

## 2 HORIZONTAL WALL SECTION @ LIGHT SWITCH

3" = 1'-0"




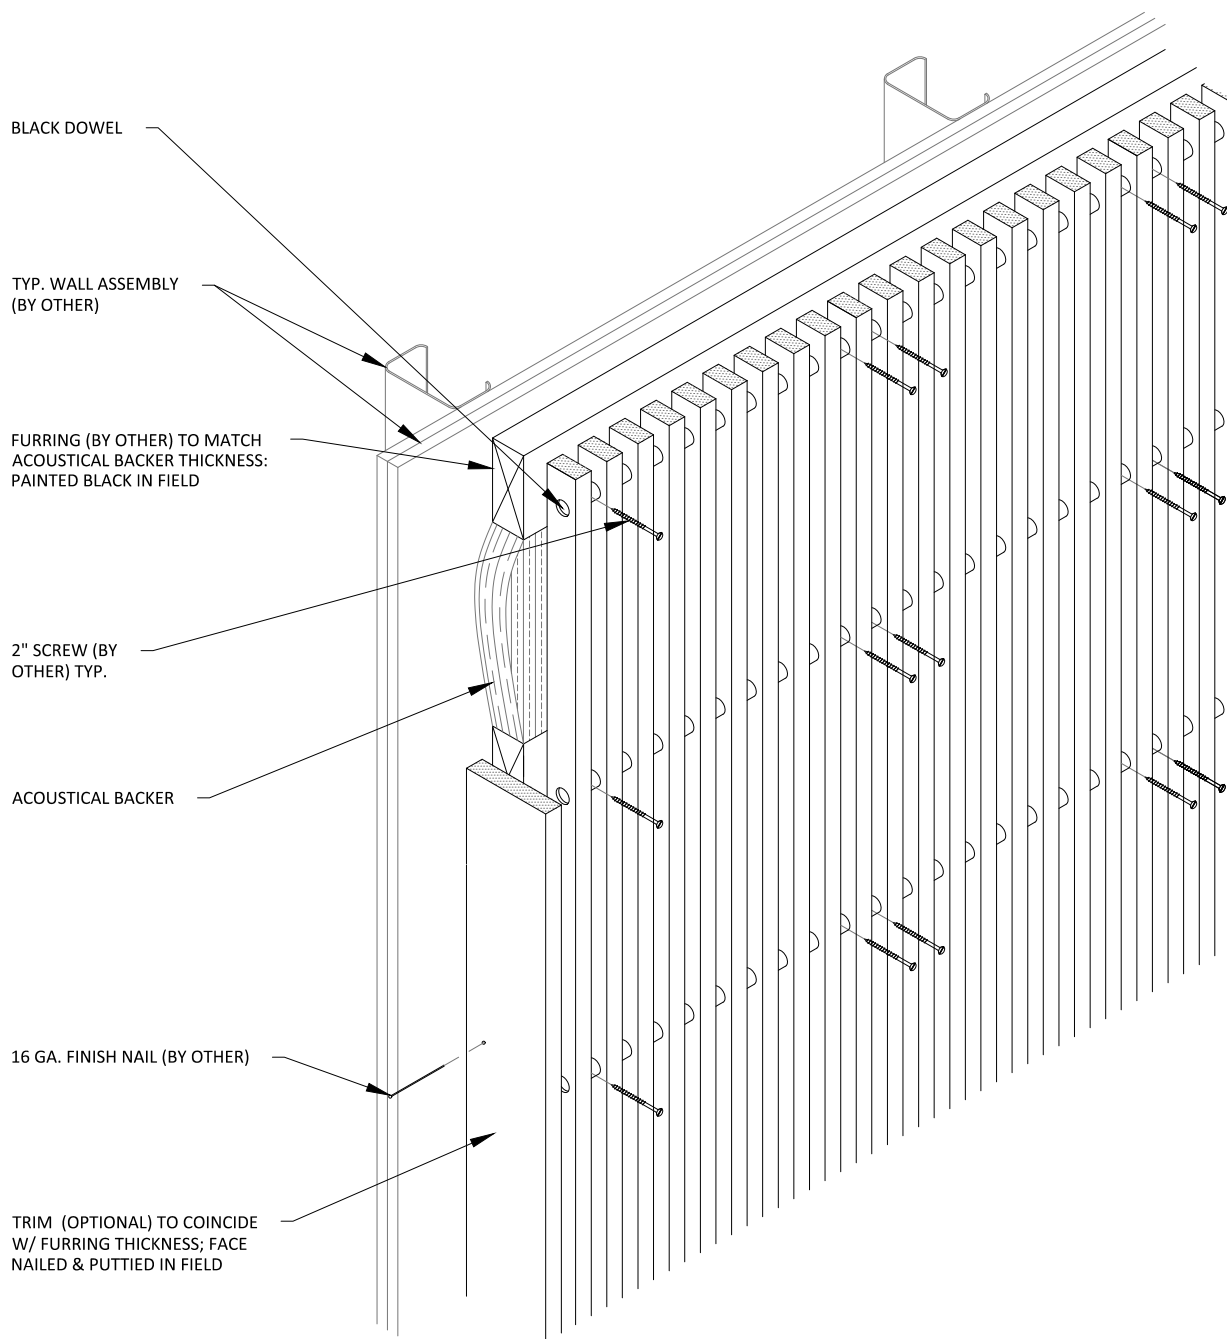


1

VERTICAL WALL ISOMETRIC - TYP.


1 1/2" = 1'-0"

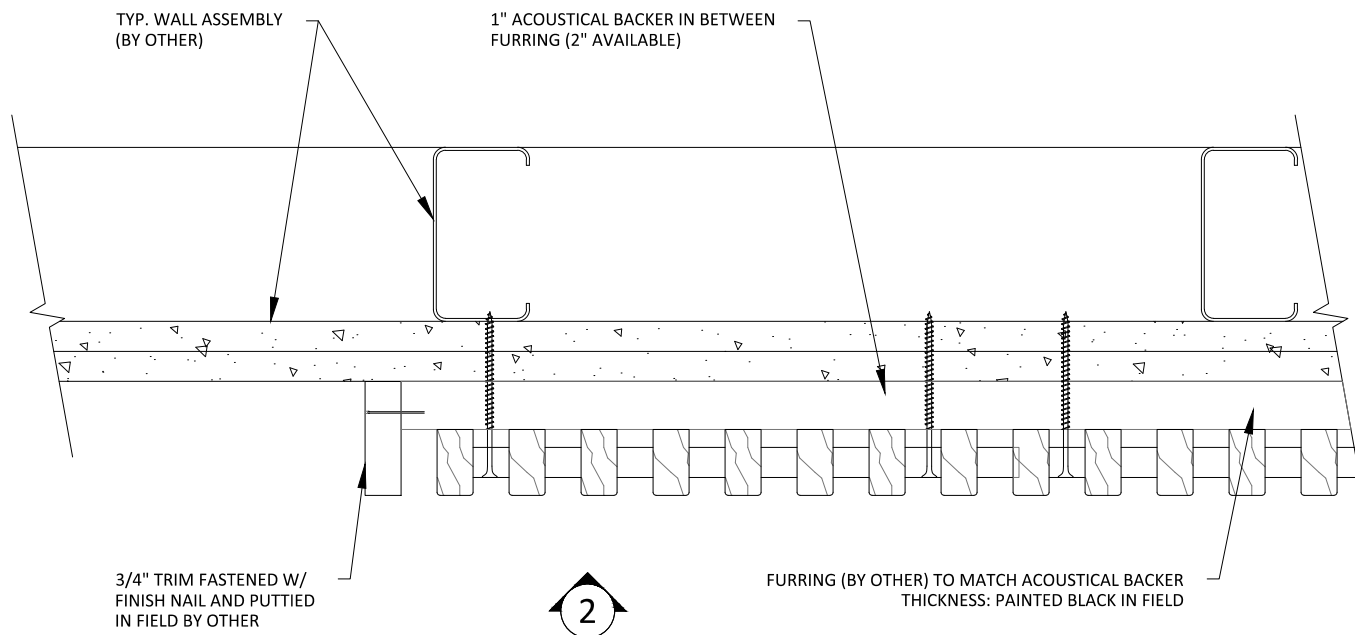


1 VERTICAL WALL PLAN @ TRIM  
3" = 1'-0"

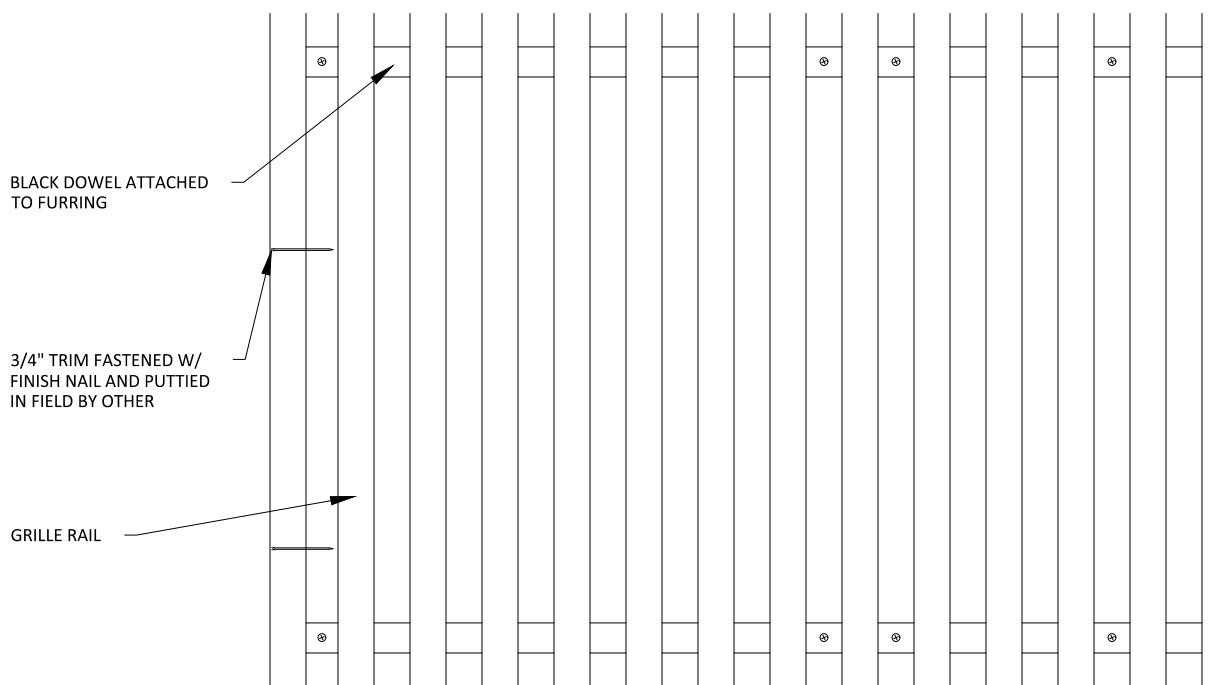

2 VERTICAL WALL ELEVATION @ TRIM  
3" = 1'-0"

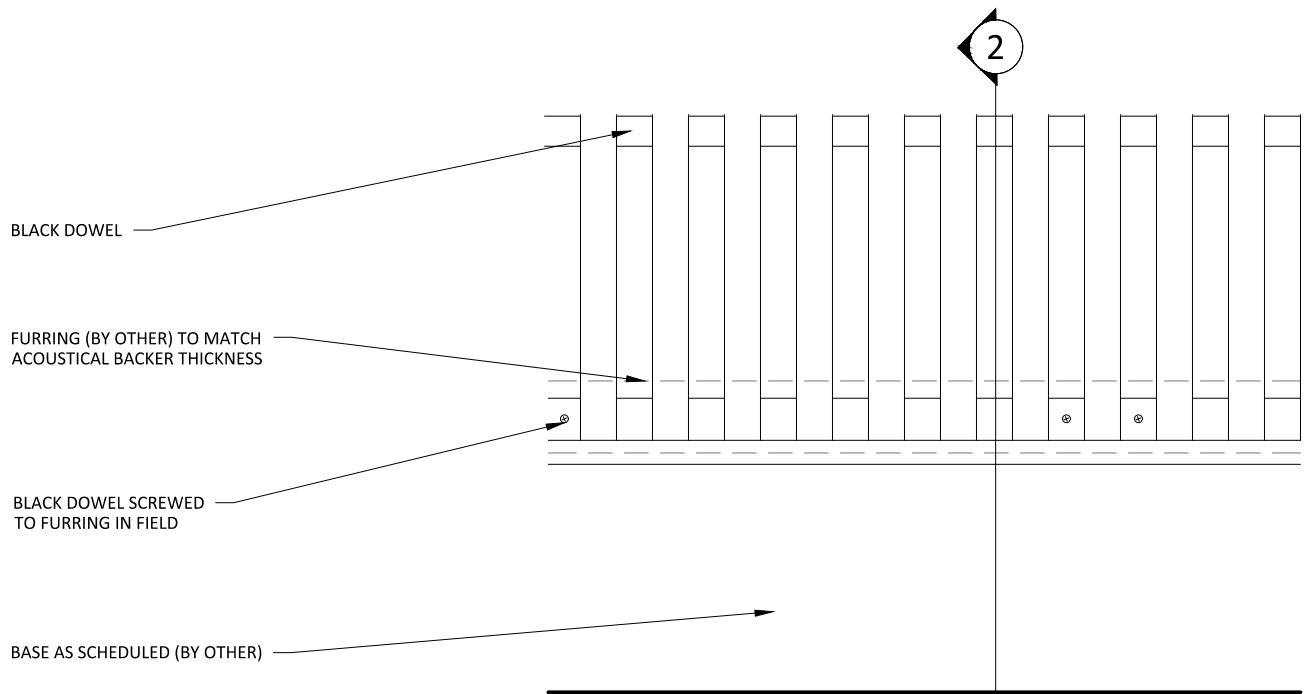

**1** VERTICAL WALL ELEVATION @ BASEBOARD  
3" = 1'-0"

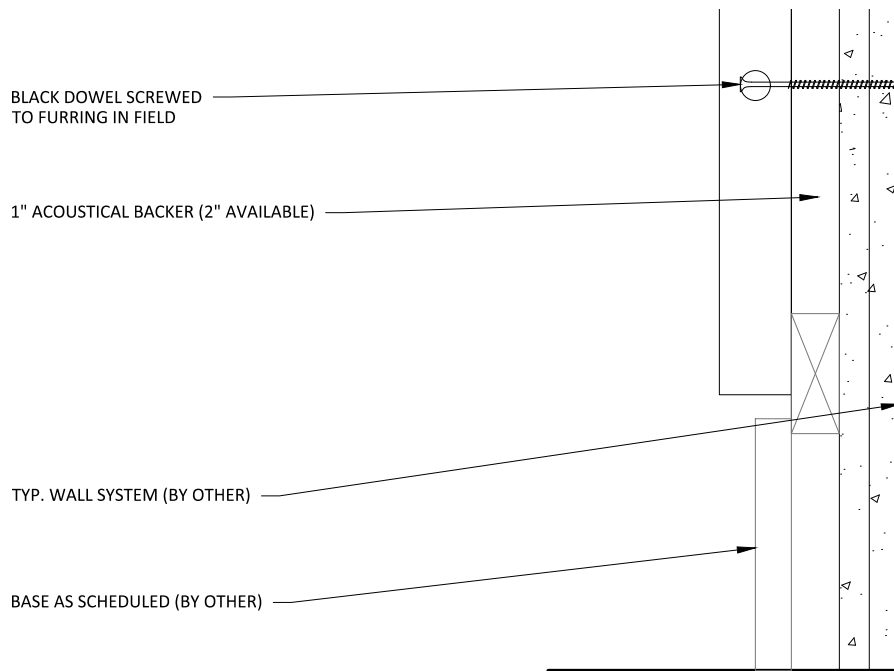


**2** VERTICAL WALL SECTION @ BASEBOARD  
3" = 1'-0"

BLACK DOWEL SCREWED  
TO FURRING IN FIELD

FURRING (BY OTHER) TO MATCH  
ACOUSTICAL BACKER THICKNESS

OUTLET PENETRATION FIELD CUT

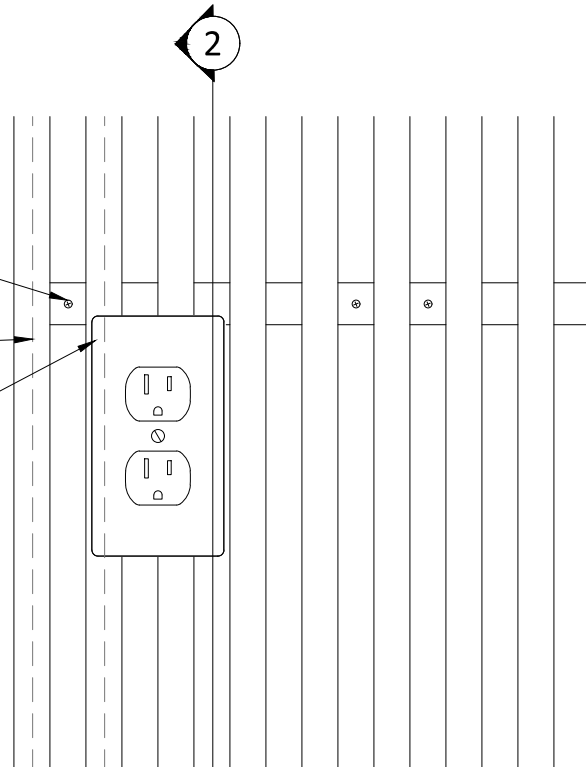


**1** VERTICAL WALL ELEVATION @ OUTLET  
3" = 1'-0"

1" ACOUSTICAL BACKER (2" AVAILABLE)


BLACK DOWEL SCREWED  
TO FURRING IN FIELD

OUTLET PENETRATION FIELD CUT


TYP. WALL SYSTEM (BY OTHER)

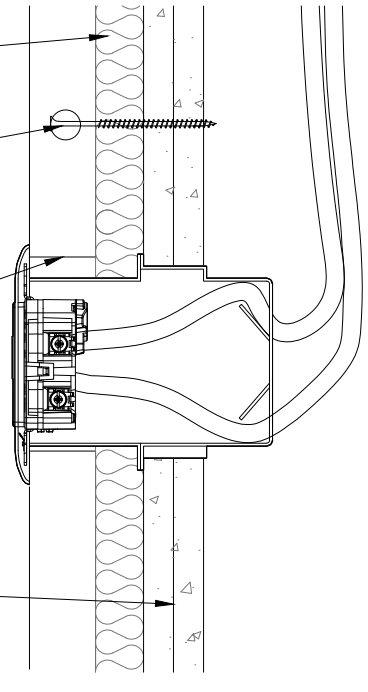


**2** VERTICAL WALL SECTION @ OUTLET  
3" = 1'-0"

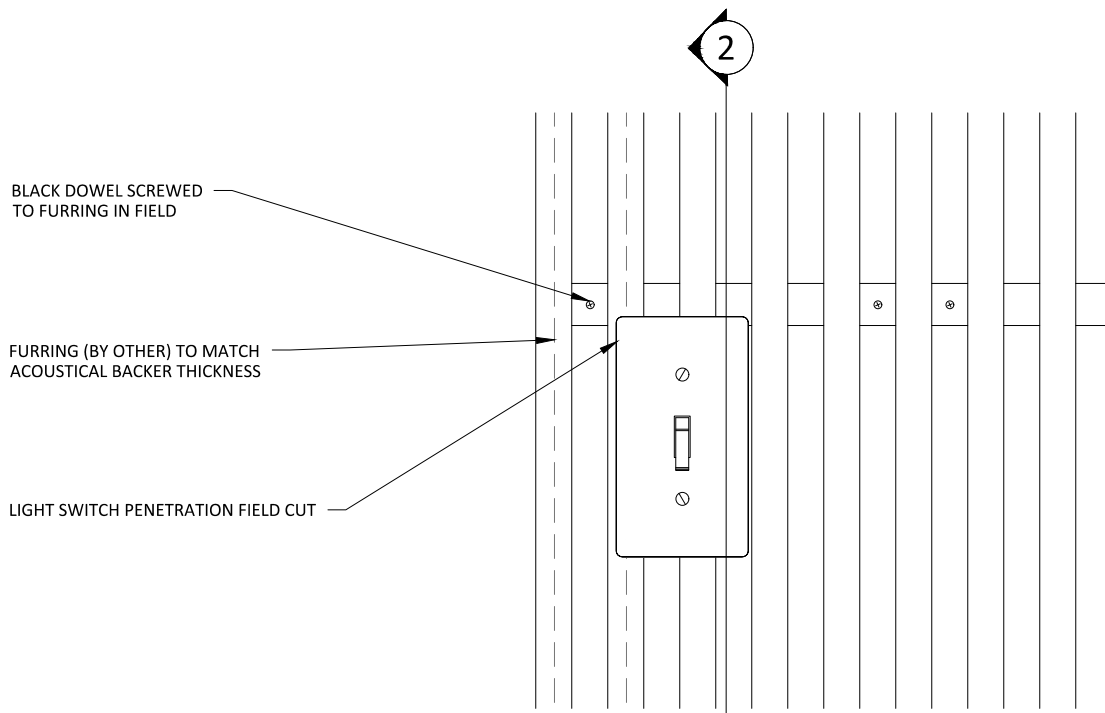


**1** VERTICAL WALL ELEVATION @ LIGHT SWITCH  
3" = 1'-0"

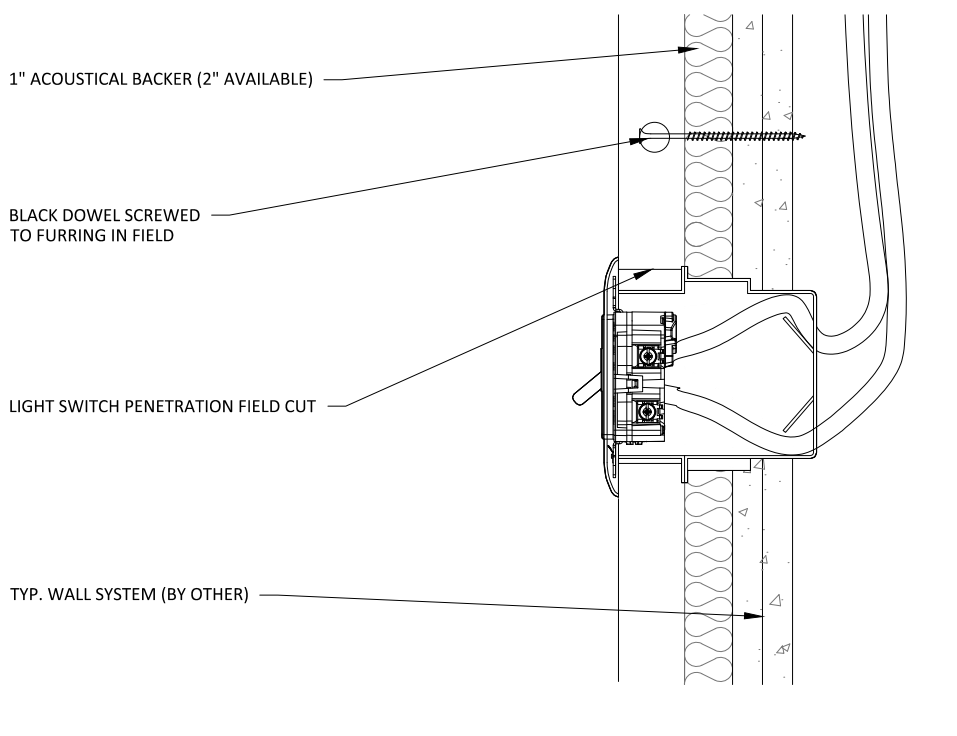

**2** VERTICAL WALL SECTION @ LIGHT SWITCH  
3" = 1'-0"

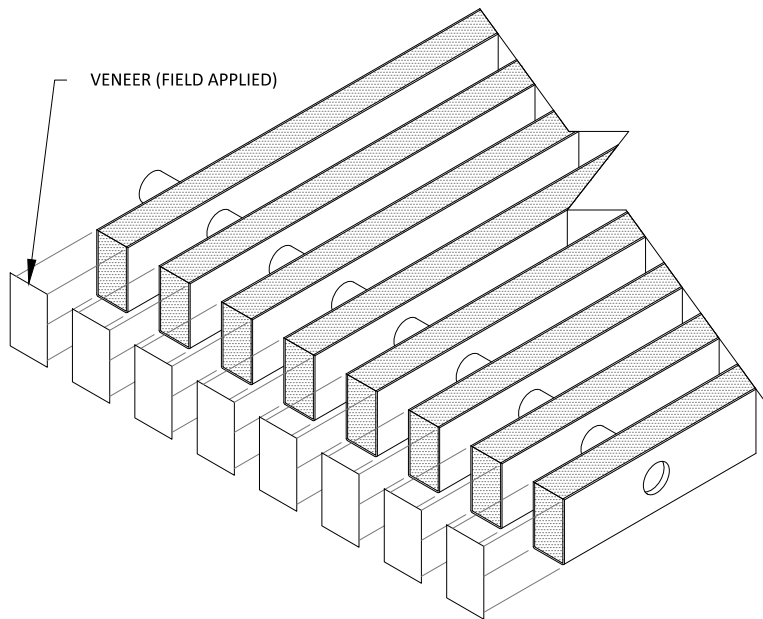


1 STEP 1  
3" = 1'-0"

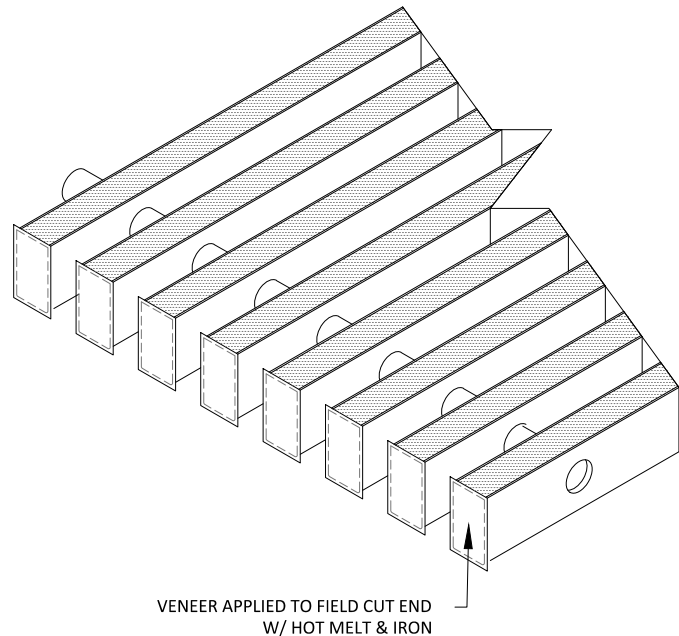

2 STEP 2  
3" = 1'-0"

NOTE: FOR SOLID WOOD RAILS, NO VENEER NEEDS TO BE APPLIED - INSTEAD, REFINISH THE CUT END IN FIELD

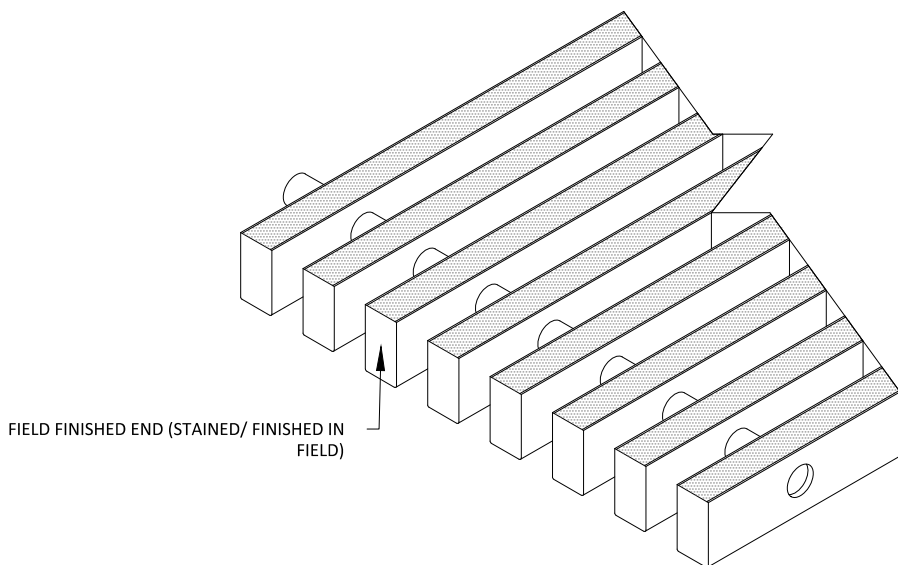

3 STEP 3  
3" = 1'-0"