



1 TYPICAL AUDITION PLANK SECTION DETAIL
6" = 1'-0"

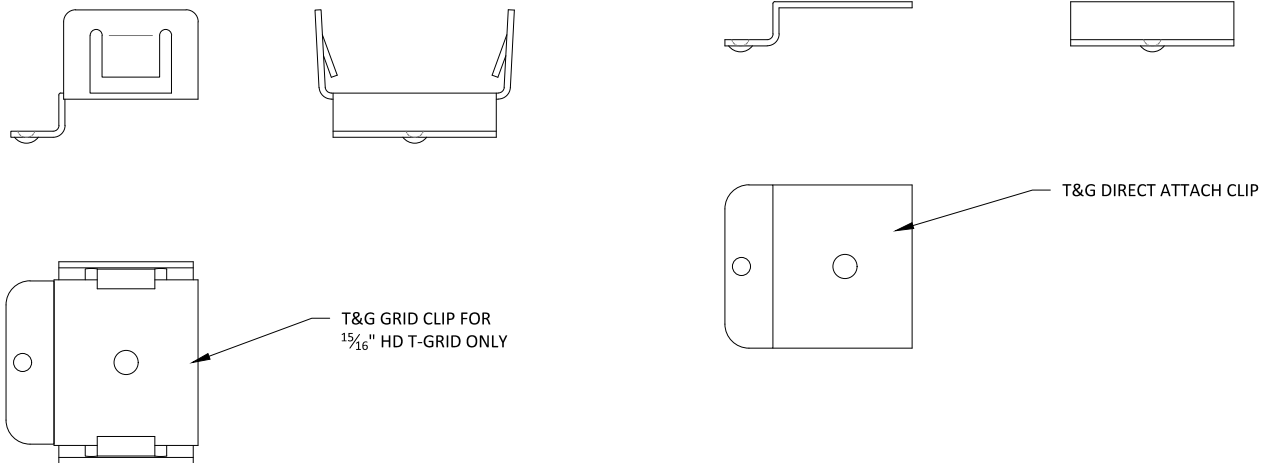


2 T&G GRID CLIP
1' = 1'-0"


3 T&G DIRECT ATTACH CLIP
1' = 1'-0"

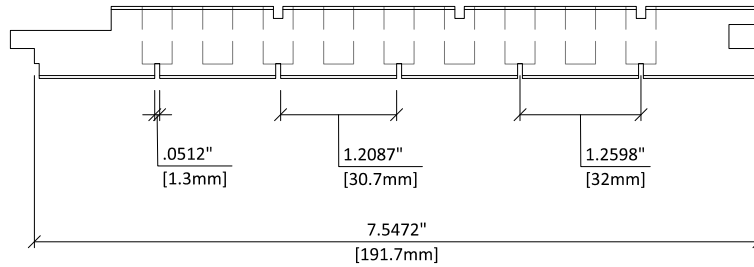

AUDITION 32


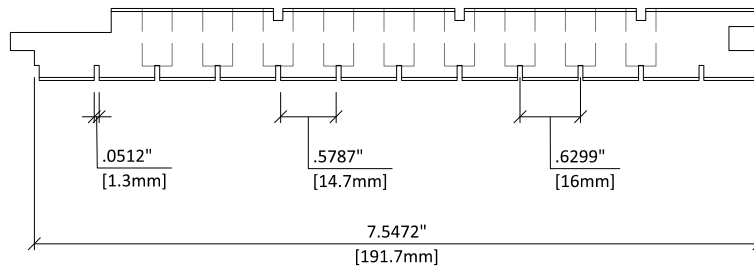


AUDITION 16

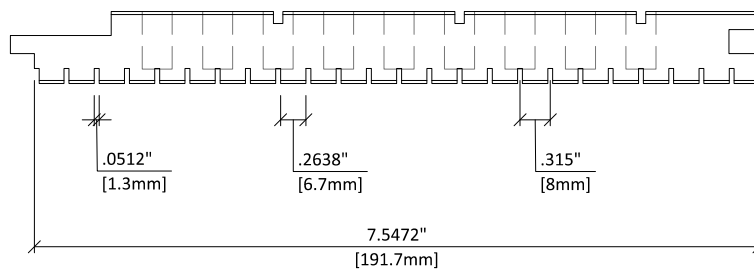



AUDITION 8


1 PANEL OPTIONS 6" = 1'-0"

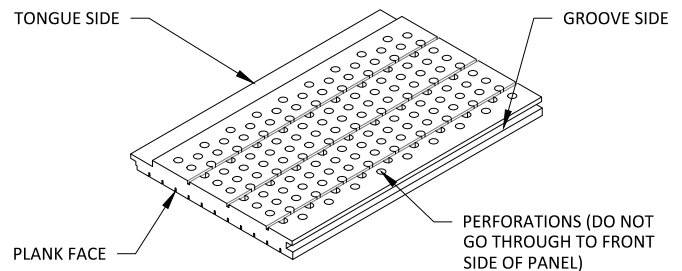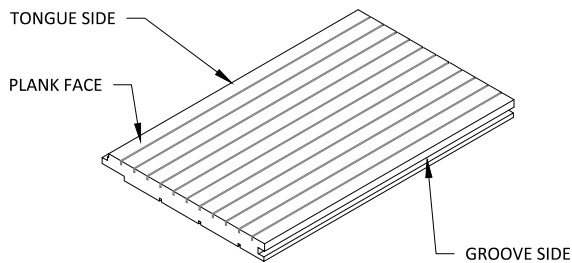


2 FRONT OF PANEL ISOMETRIC 1 1/2" = 1'-0"

3 BACK OF PANEL ISOMETRIC 1 1/2" = 1'-0"

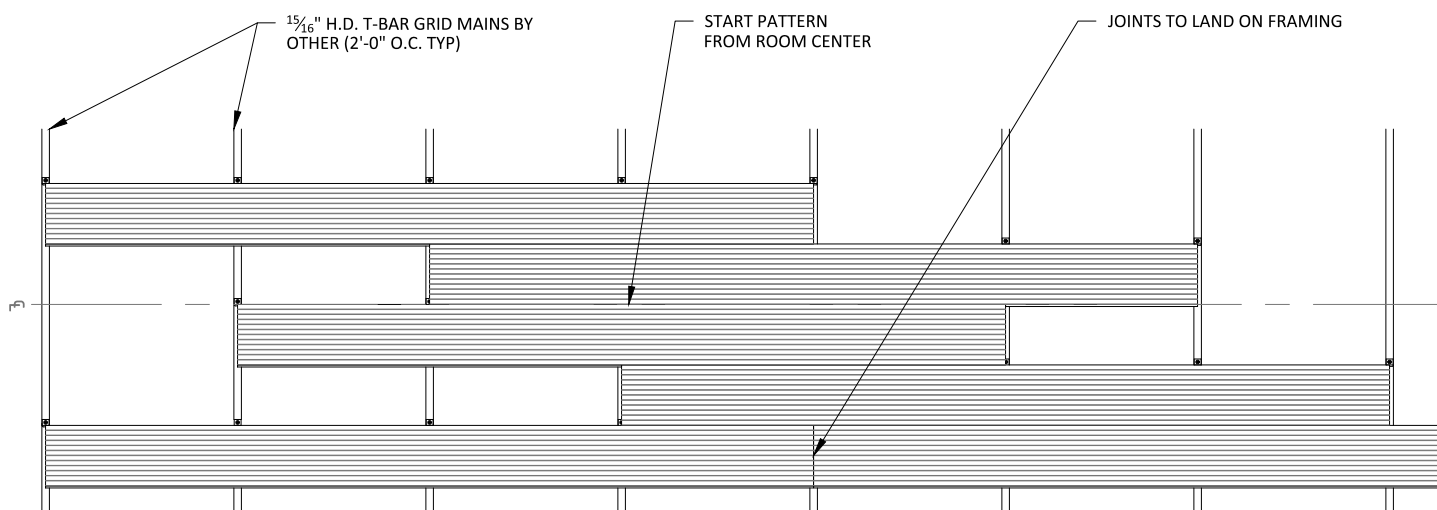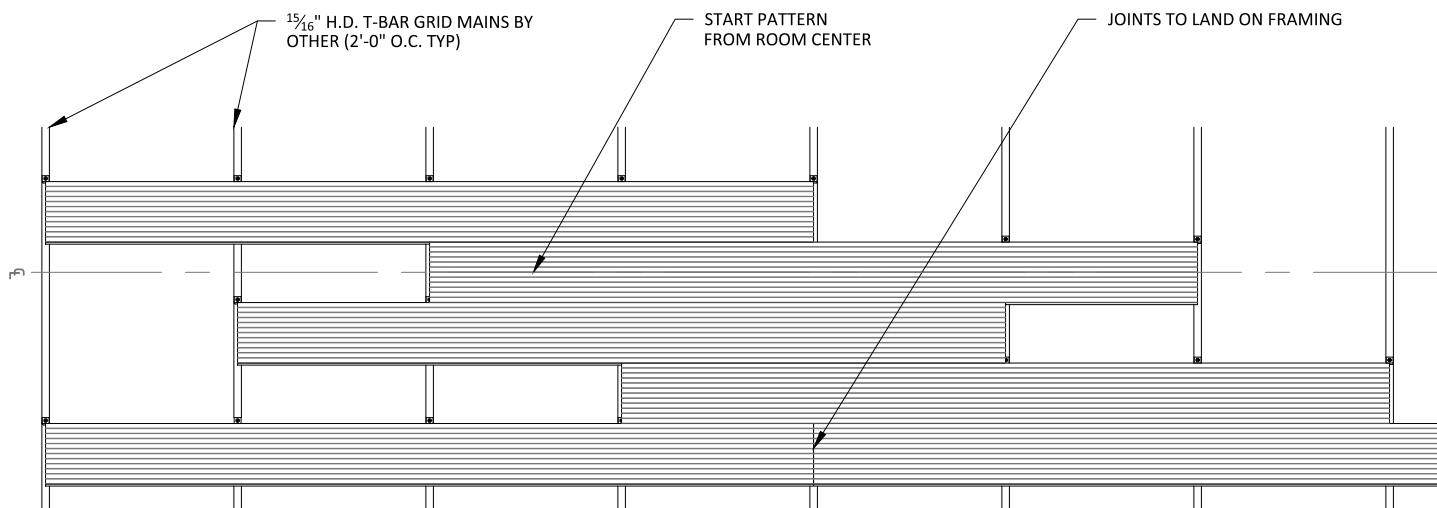


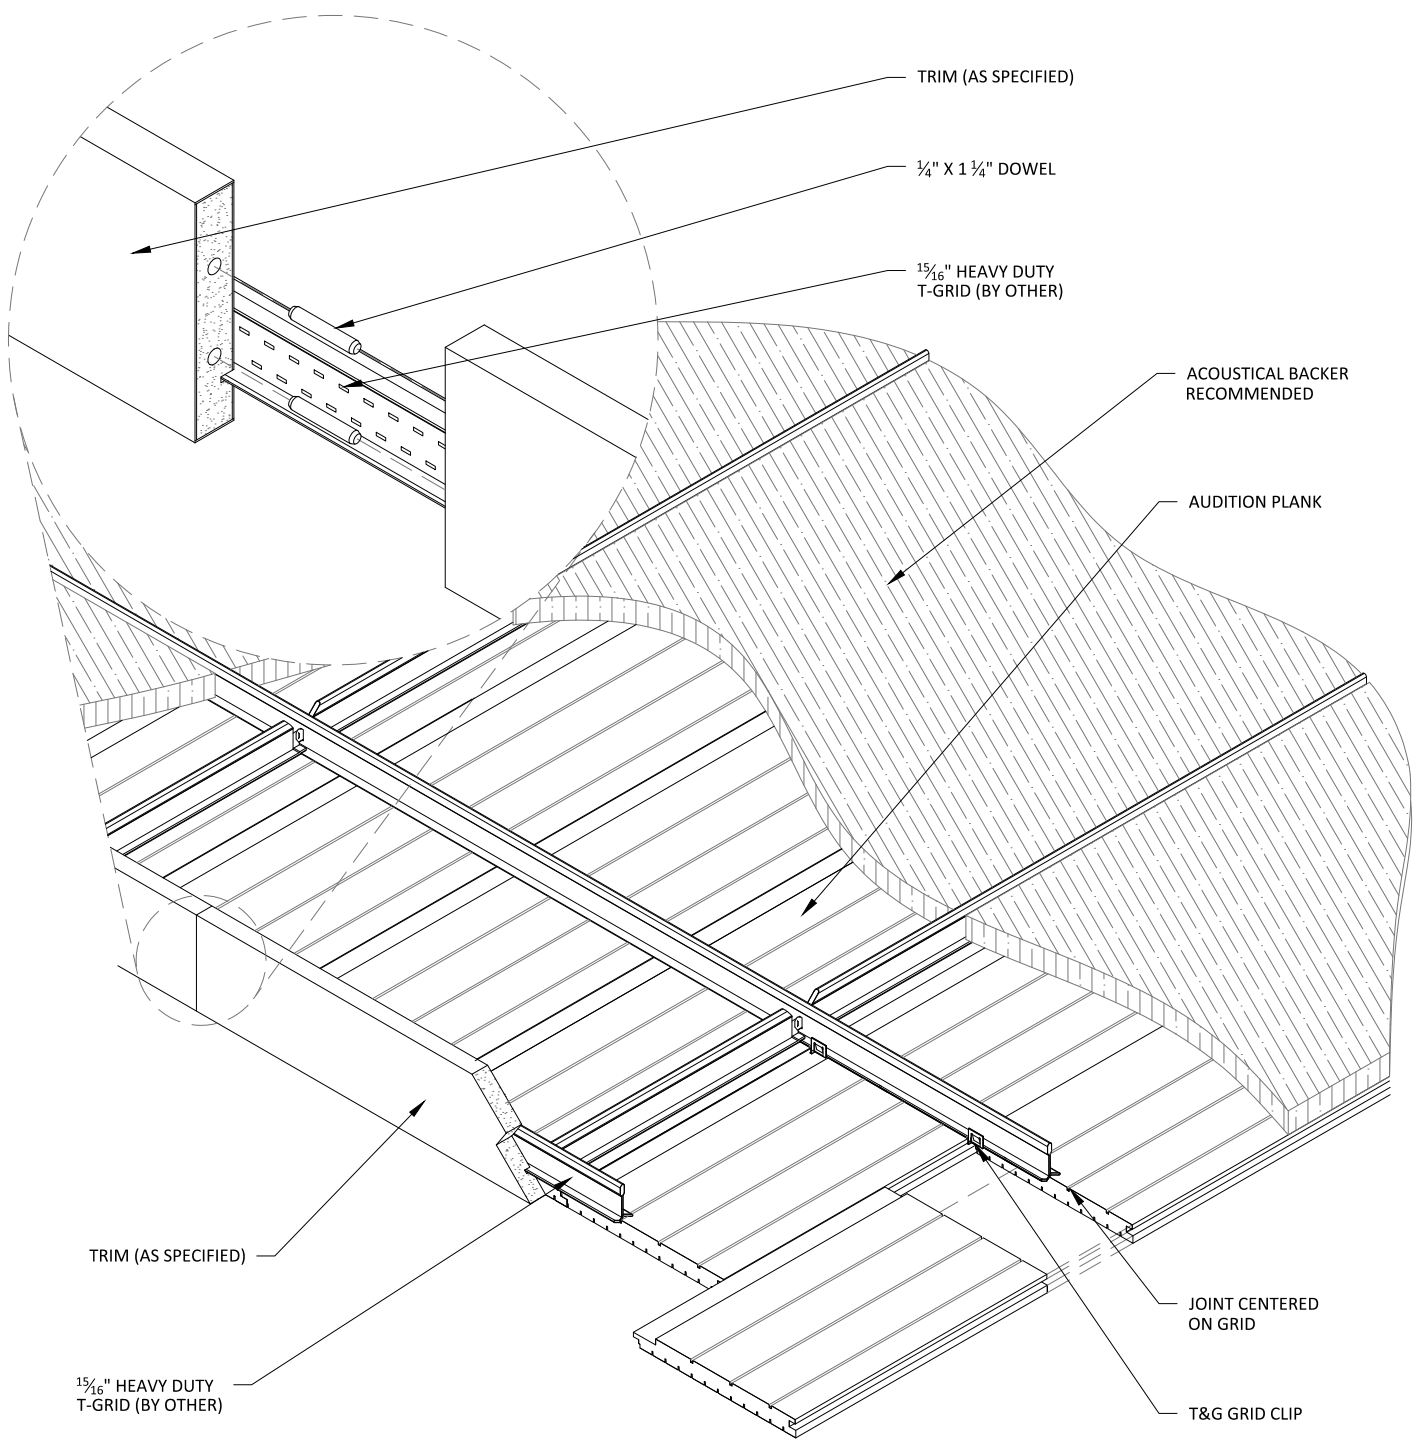


1 ISOMETRIC VIEW - TYP.
1 1/2" = 1'-0"

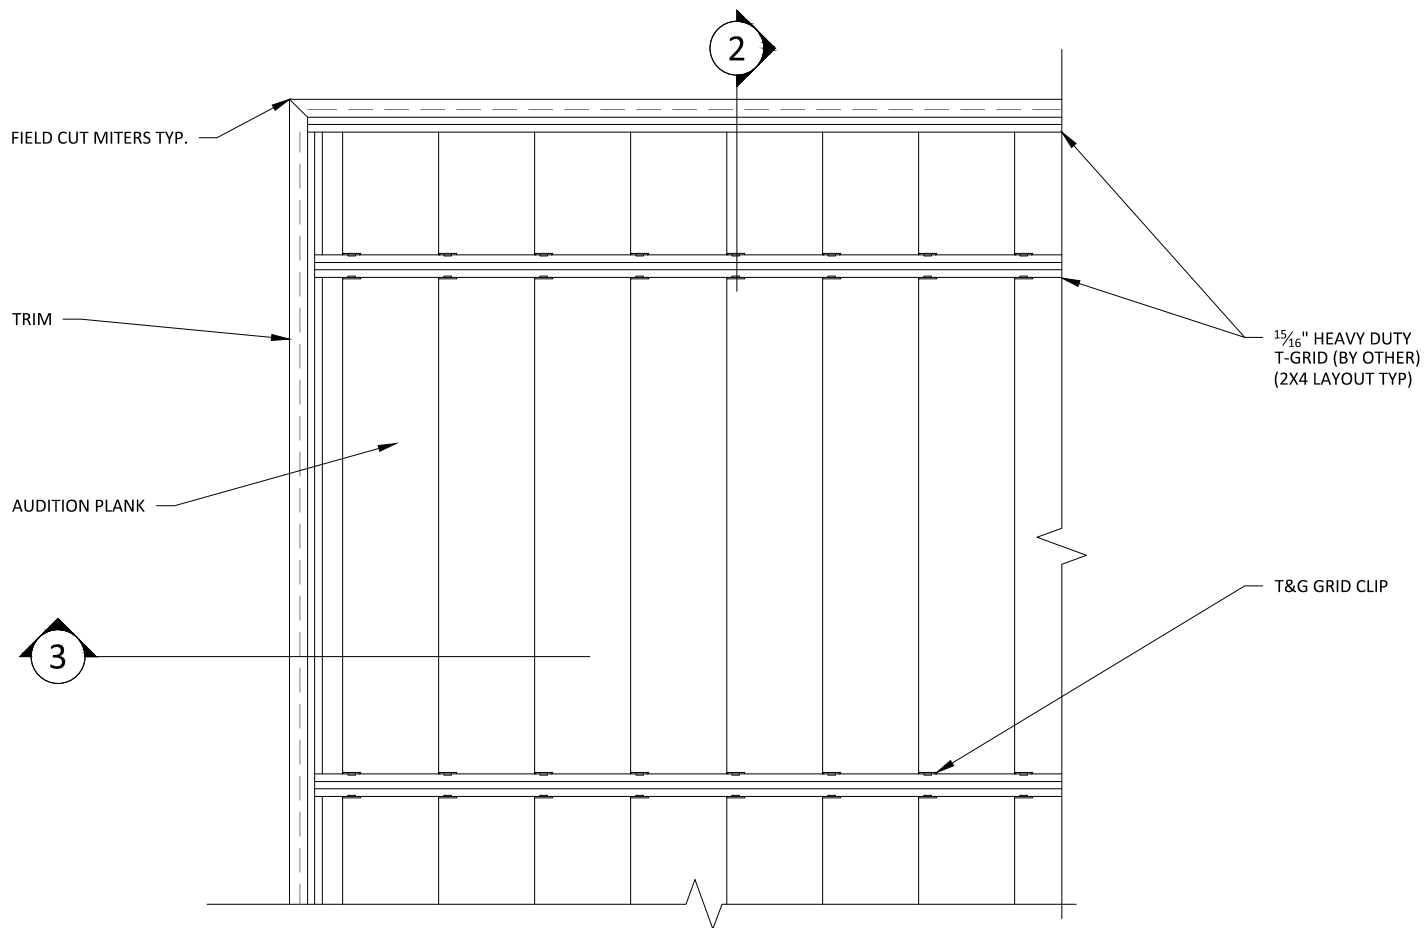


1 TRIM @ MITERED CORNER - PLAN
1 1/2" = 1'-0"

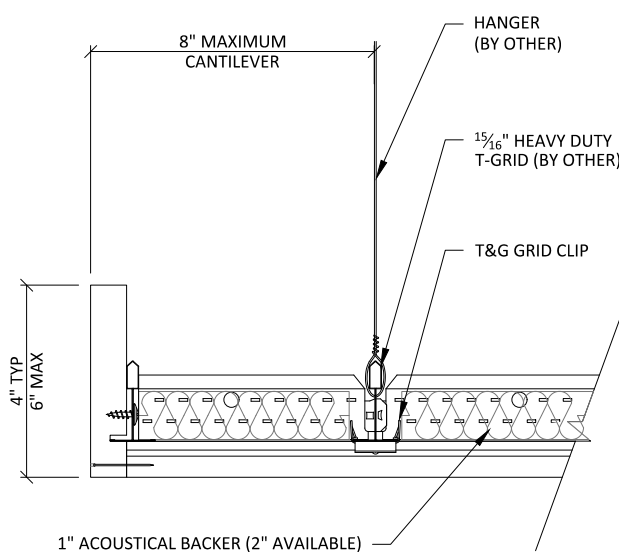


2 TRIM DETAIL 1
3" = 1'-0"

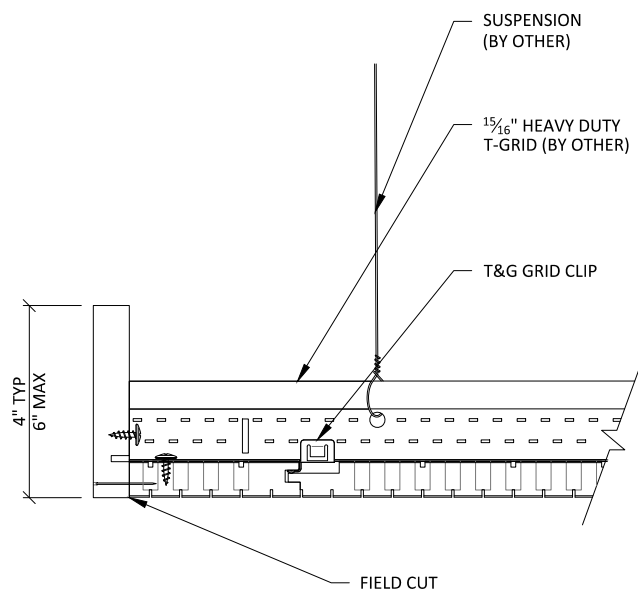


3 TRIM DETAIL 2
3" = 1'-0"

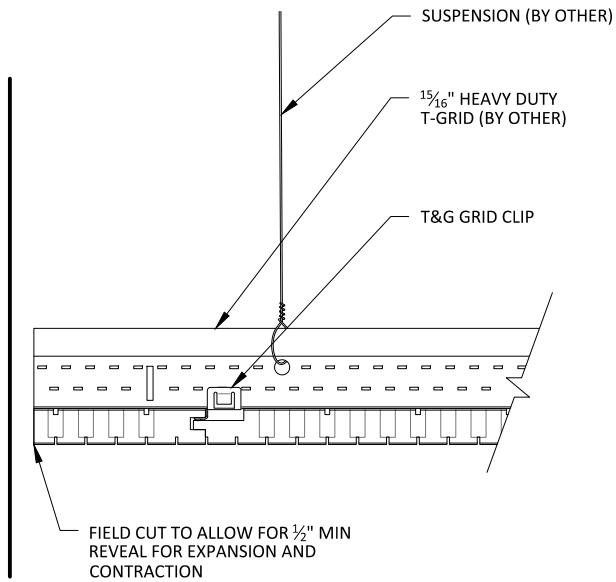


1 EDGE DETAIL 1
3" = 1'-0"

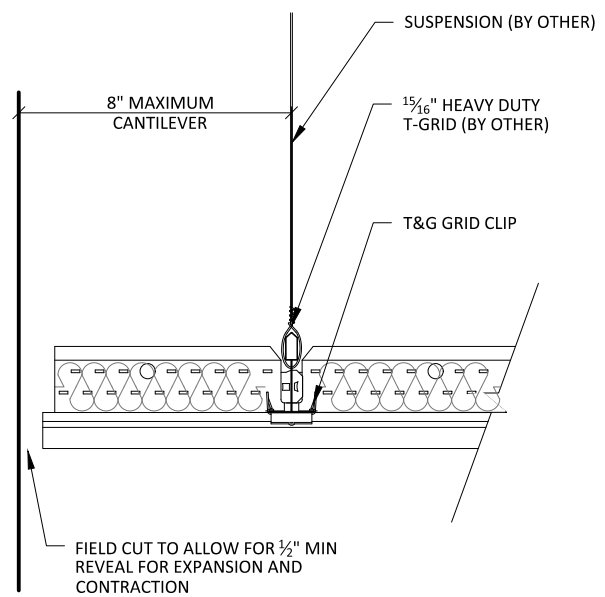


2 EDGE DETAIL 2
3" = 1'-0"

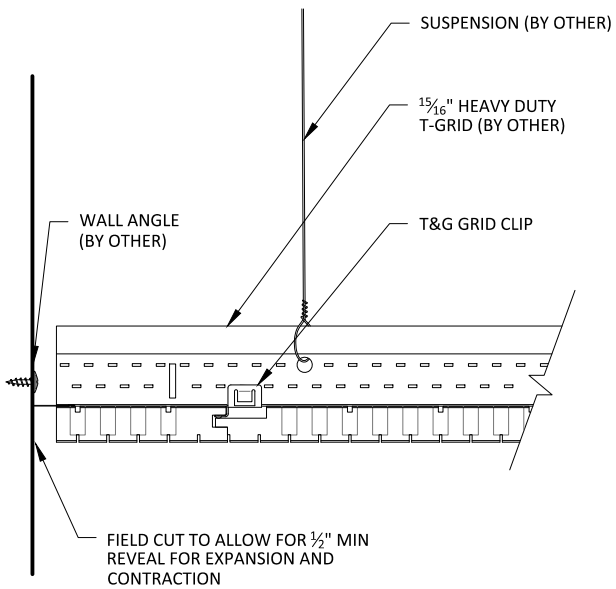


3 EDGE DETAIL 3
3" = 1'-0"

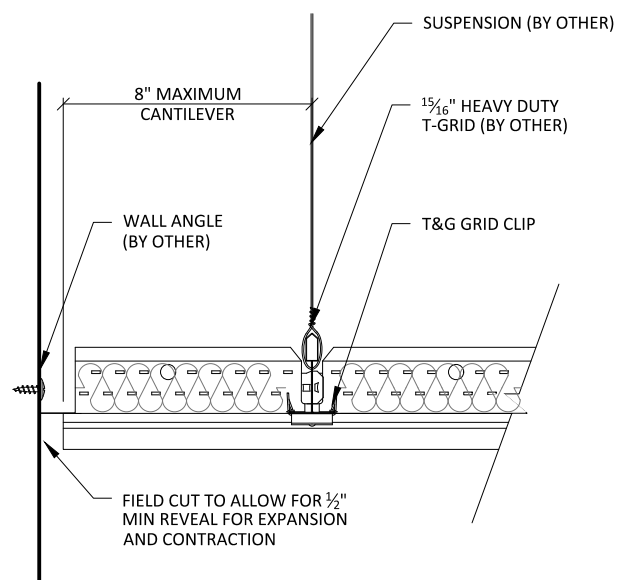

4 EDGE DETAIL 4
3" = 1'-0"

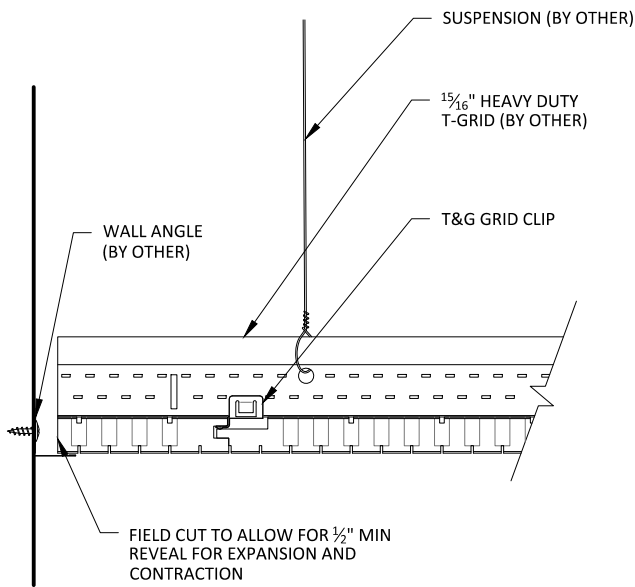

1 EDGE DETAIL 5
3" = 1'-0"

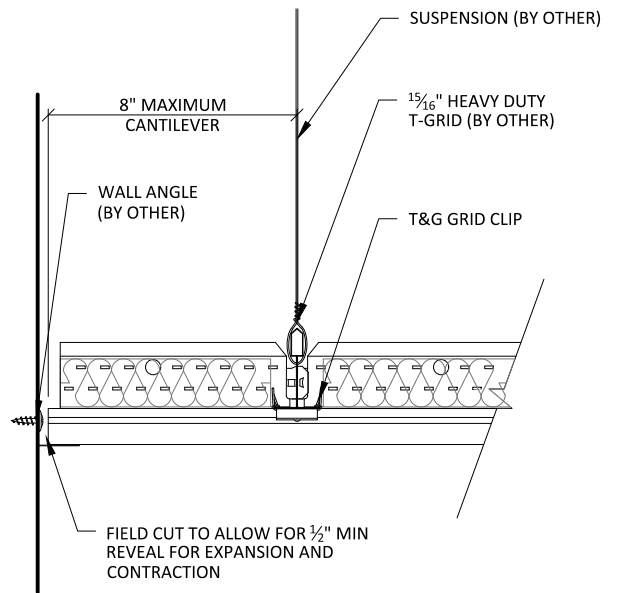

2 EDGE DETAIL 6
3" = 1'-0"


1 1/16" HEAVY DUTY
T-GRID (BY OTHER)
(2X4 LAYOUT TYP)

AUDITION PLANK

INDEPENDENTLY SUPPORTED
CUSTOMER FIXTURE: FIELD CUT
PENETRATION

IF PENETRATION EXCEEDS
3/8 BOARD WIDTH, SUPPORT
BRACKETS ARE NEEDED
(BY OTHER)

T&G GRID CLIP

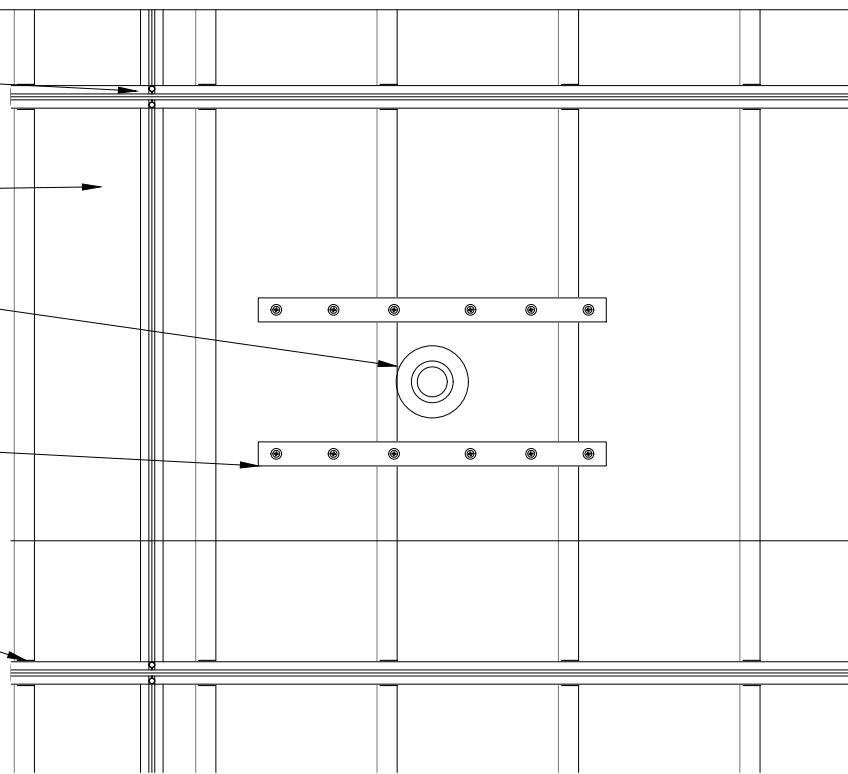

1

SPRINKLER HEAD DETAIL - PLAN VIEW


1 1/2" = 1'-0"

IF PENETRATION EXCEEDS
3/8 BOARD WIDTH, SUPPORT
BRACKETS ARE NEEDED
(BY OTHER)

SUSPENSION (BY OTHER)

T&G GRID CLIP

1 1/16" HEAVY DUTY
T-GRID (BY OTHER)
(2X4 LAYOUT TYP)

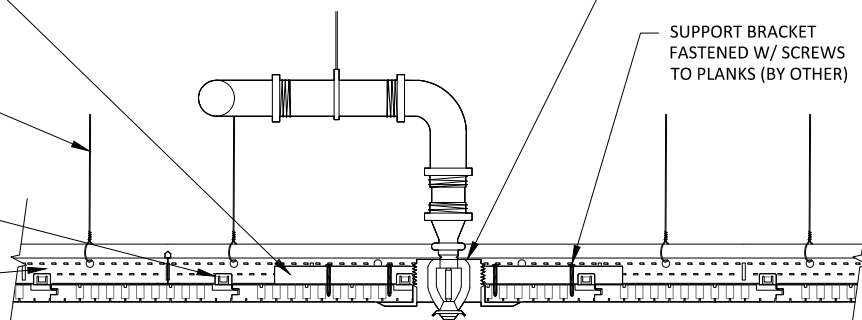

INDEPENDENTLY SUPPORTED
CUSTOMER FIXTURE: FIELD CUT
PENETRATION

SUPPORT BRACKET
FASTENED W/ SCREWS
TO PLANKS (BY OTHER)

2

SPRINKLER HEAD DETAIL - SECTION VIEW

1 1/2" = 1'-0"

AUDITION T&G CEILING SYSTEM - SPRINKLER HEAD DETAIL

SCALE: AS NOTED

LAST REVISED: 7/6/2020

SHEET NUMBER

8

DRAWN BY: BH

15/16" HEAVY DUTY
T-GRID (BY OTHER)
(2X4 LAYOUT TYP)

AUDITION PLANK

INDEPENDENTLY SUPPORTED
CUSTOMER FIXTURE: FIELD CUT
PENETRATION

IF PENETRATION EXCEEDS
2/3 BOARD WIDTH, SUPPORT
BRACKETS ARE NEEDED
(BY OTHER)

T&G GRID CLIP

2

1

CAN LIGHT DETAIL - PLAN VIEW

1 1/2" = 1'-0"

IF PENETRATION EXCEEDS
2/3 BOARD WIDTH, SUPPORT
BRACKETS ARE NEEDED
(BY OTHER)

SUSPENSION (BY OTHER)

T&G GRID CLIP

15/16" HEAVY DUTY
T-GRID (BY OTHER)
(2X4 LAYOUT TYP)

INDEPENDENTLY SUPPORTED
CUSTOMER FIXTURE: FIELD CUT
PENETRATION

SUPPORT BRACKET
FASTENED W/ SCREWS
TO PLANKS (BY OTHER)

2

CAN LIGHT DETAIL - SECTION VIEW

1 1/2" = 1'-0"


1 5/16" HEAVY DUTY
T-GRID (BY OTHER)
(2X4 LAYOUT TYP)

AUDITION PLANK

INDEPENDENTLY SUPPORTED
CUSTOMER FIXTURE: FIELD CUT
PENETRATION

IF PENETRATION EXCEEDS
2/3 BOARD WIDTH, SUPPORT
BRACKETS ARE NEEDED
(BY OTHER)

T&G GRID CLIP

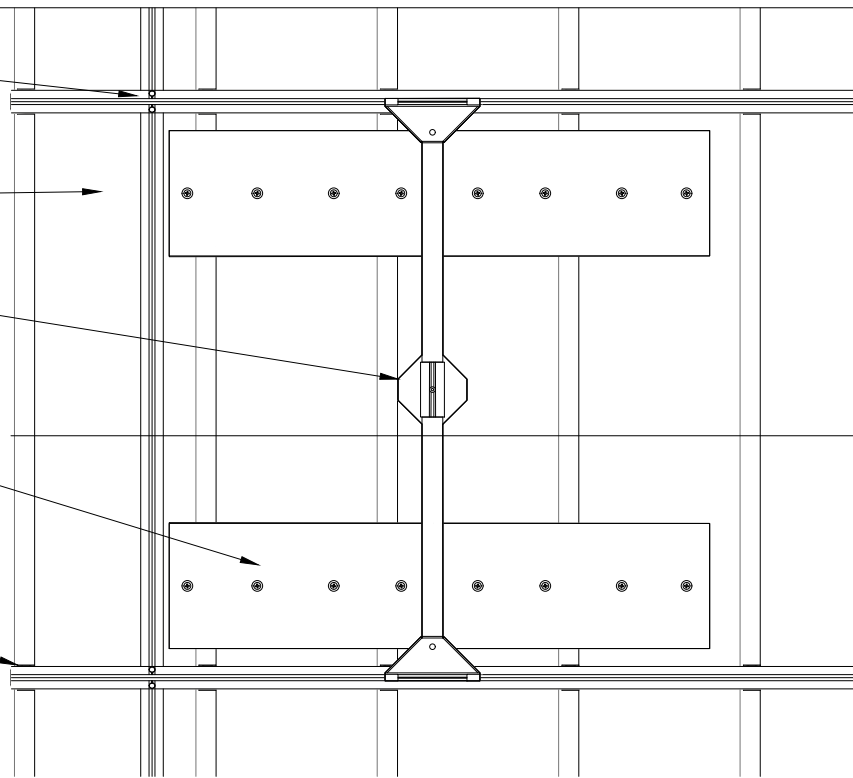

2

1

PENDANT LIGHT DETAIL - PLAN VIEW


1 1/2" = 1'-0"

IF PENETRATION EXCEEDS
2/3 BOARD WIDTH, SUPPORT
BRACKETS ARE NEEDED
(BY OTHER)

SUSPENSION (BY OTHER)

T&G GRID CLIP

1 5/16" HEAVY DUTY
T-GRID (BY OTHER)
(2X4 LAYOUT TYP)

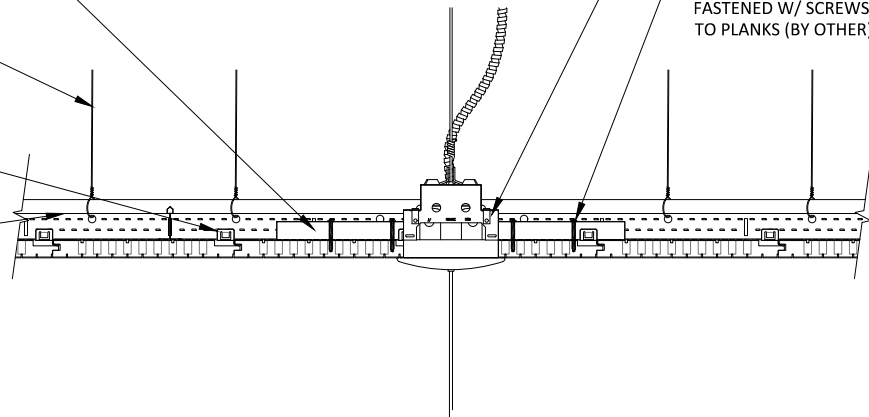

INDEPENDENTLY SUPPORTED
CUSTOMER FIXTURE: FIELD CUT
PENETRATION

SUPPORT BRACKET
FASTENED W/ SCREWS
TO PLANKS (BY OTHER)

2

PENDANT LIGHT DETAIL - SECTION DETAIL

1 1/2" = 1'-0"

1 1/16" HEAVY DUTY
T-GRID (BY OTHER)
(2X4 LAYOUT TYP)

AUDITION PLANK

INDEPENDENTLY SUPPORTED
CUSTOMER FIXTURE: FIELD CUT
PENETRATION

IF PENETRATION EXCEEDS
2/3 BOARD WIDTH, SUPPORT
BRACKETS ARE NEEDED
(BY OTHER)

T&G GRID CLIP

2

1

RECESSED SPEAKER DETAIL - PLAN VIEW

1 1/2" = 1'-0"

IF PENETRATION EXCEEDS
2/3 BOARD WIDTH, SUPPORT
BRACKETS ARE NEEDED
(BY OTHER)

SUSPENSION (BY OTHER)

T&G GRID CLIP

1 1/16" HEAVY DUTY
T-GRID (BY OTHER)
(2X4 LAYOUT TYP)


INDEPENDENTLY SUPPORTED
CUSTOMER FIXTURE: FIELD CUT
PENETRATION

SUPPORT BRACKET
FASTENED W/ SCREWS
TO PLANKS (BY OTHER)


2

RECESSED SPEAKER DETAIL - SECTION VIEW

1 1/2" = 1'-0"

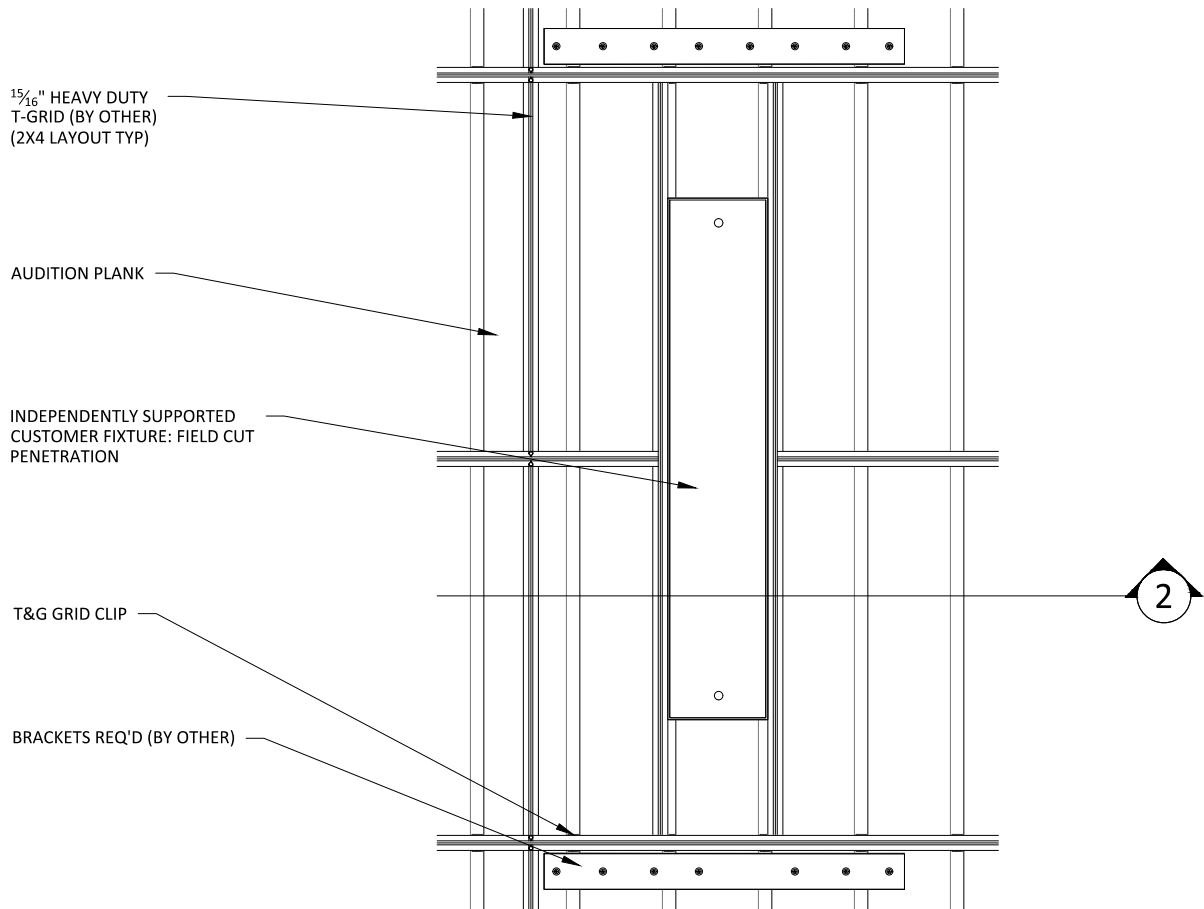

1 LINEAR LIGHT DETAIL - PLAN VIEW
1" = 1'-0"

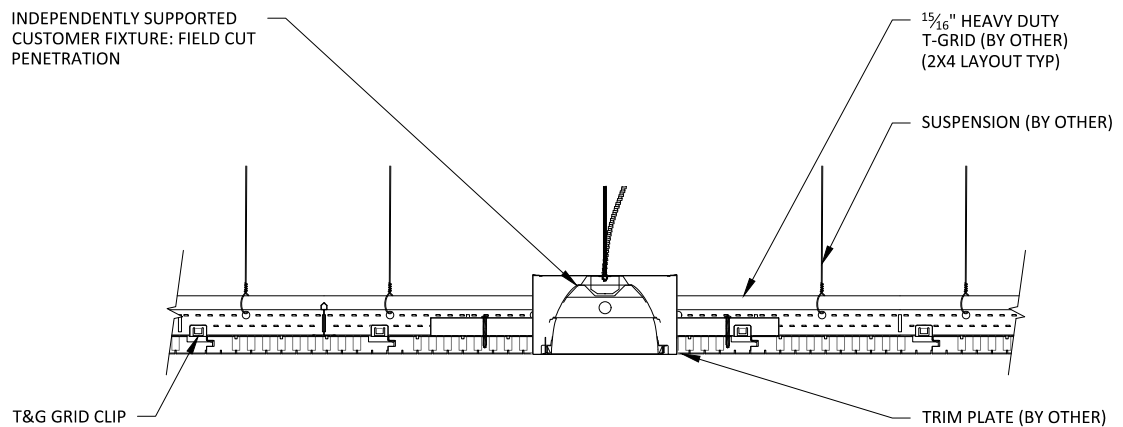

2 LINEAR LIGHT DETAIL - SECTION VIEW
1 1/2" = 1'-0"

1 5/16" HEAVY DUTY
T-GRID (BY OTHER)
(2X4 LAYOUT TYP)

AUDITION PLANK

INDEPENDENTLY SUPPORTED
CUSTOMER FIXTURE: FIELD CUT
PENETRATION

IF PENETRATION EXCEEDS
2/3 BOARD WIDTH, SUPPORT
BRACKETS ARE NEEDED
(BY OTHER)

T&G GRID CLIP

2

1

LINEAR DIFFUSER DETAIL - PLAN VIEW

1 1/2" = 1'-0"

IF PENETRATION EXCEEDS
2/3 BOARD WIDTH, SUPPORT
BRACKETS ARE NEEDED
(BY OTHER)

SUSPENSION (BY OTHER)

T&G GRID CLIP

1 5/16" HEAVY DUTY
T-GRID (BY OTHER)
(2X4 LAYOUT TYP)


INDEPENDENTLY SUPPORTED
CUSTOMER FIXTURE: FIELD CUT
PENETRATION

SUPPORT BRACKET
FASTENED W/ SCREWS
TO PLANKS (BY OTHER)


2

LINEAR DIFFUSER DETAIL - SECTION VIEW

1 1/2" = 1'-0"

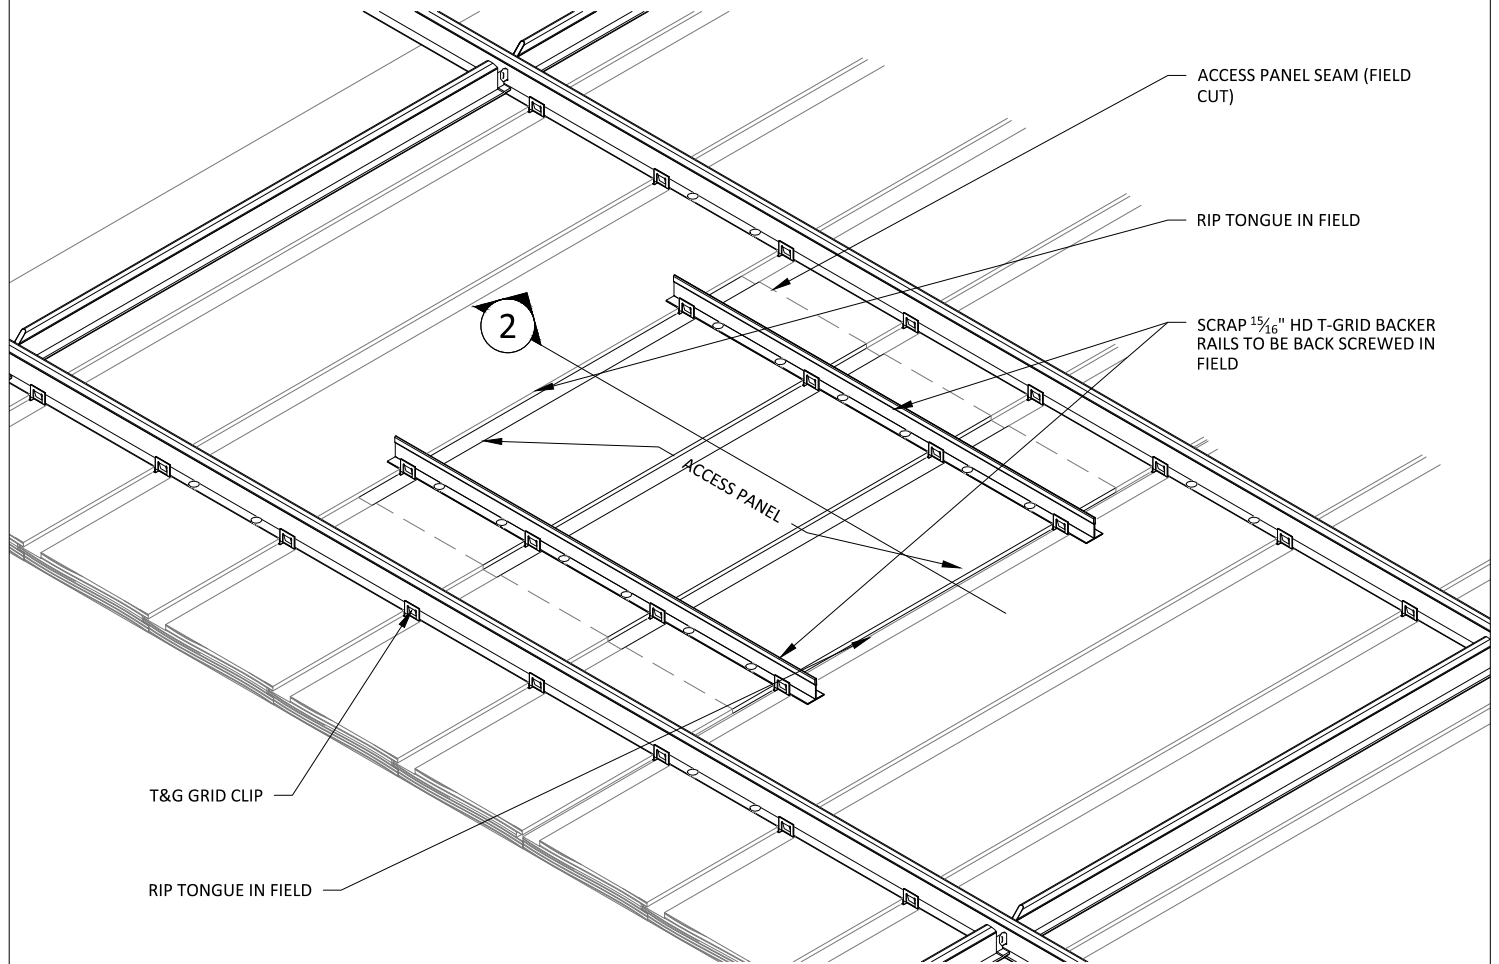

1 ACCESS PANEL DETAIL
1 1/2" = 1'-0"



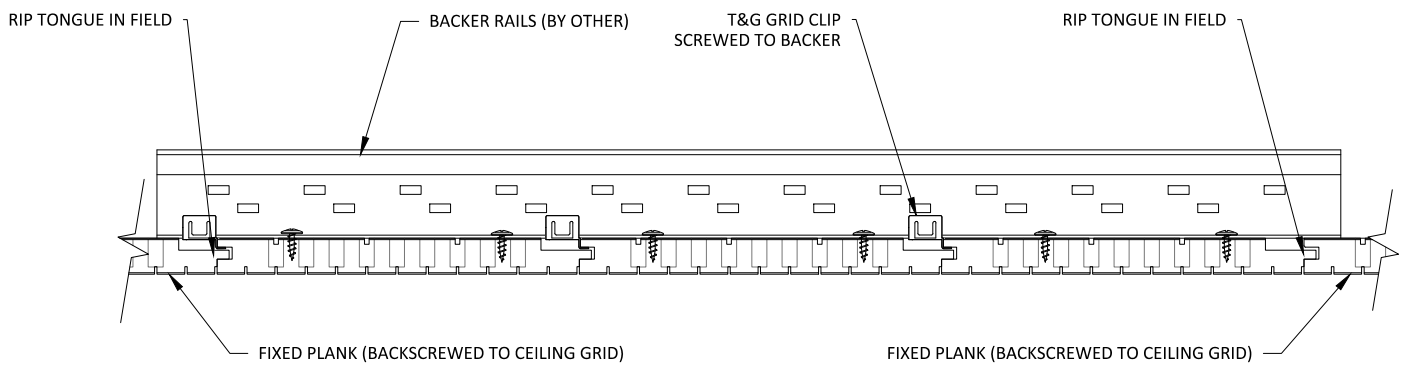


2 ACCESS PANEL SECTION
3" = 1'-0"

FURRING (BY OTHER): ACOUSTICAL
BACKER RECOMMENDED BETWEEN
FURRING (1" AND 2" AVAILABLE)

T&G DIRECT ATTACH CLIP
SCREWED TO FRAMING

TYP. WALL ASSEMBLY (BY OTHER)

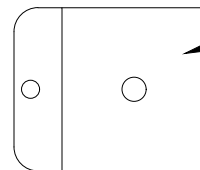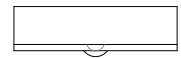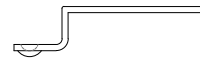


T&G DIRECT ATTACH CLIP

1 LINEAR HORIZONTAL WALL SECTION

3" = 1'-0"

2 DIRECT ATTACHMENT CLIP


1" = 1'-0"

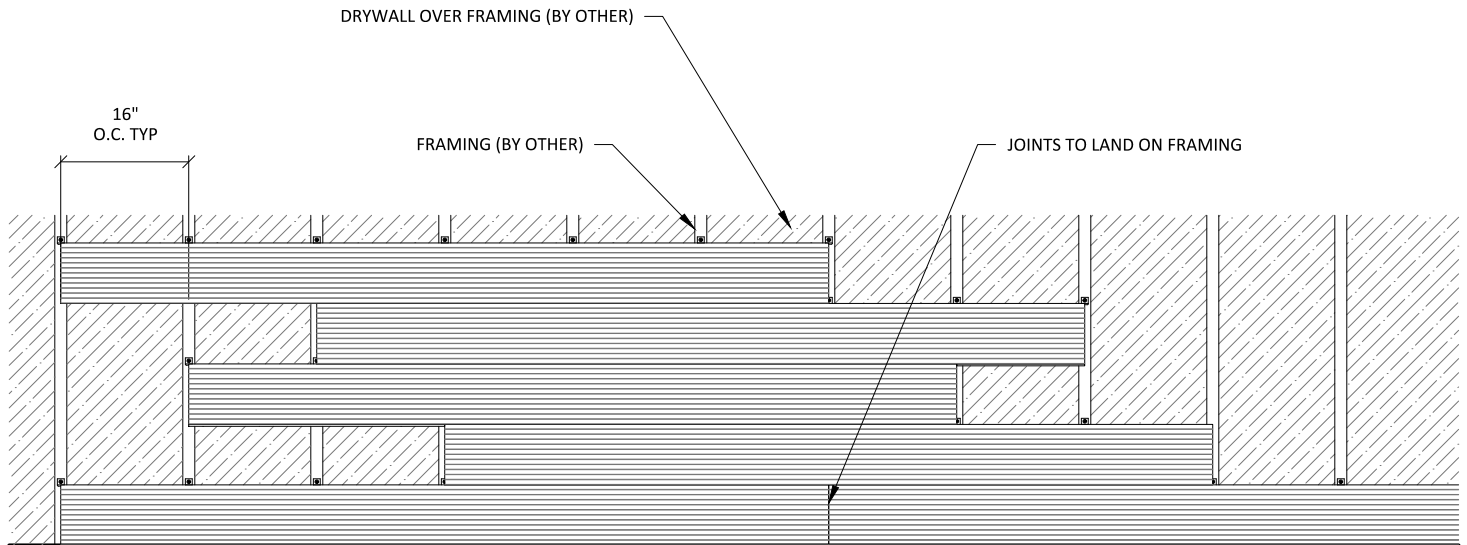

1

TYPICAL HORIZONTAL STAGGERED WALL PATTERN - 16 INCH SPACING


1/2" = 1'-0"

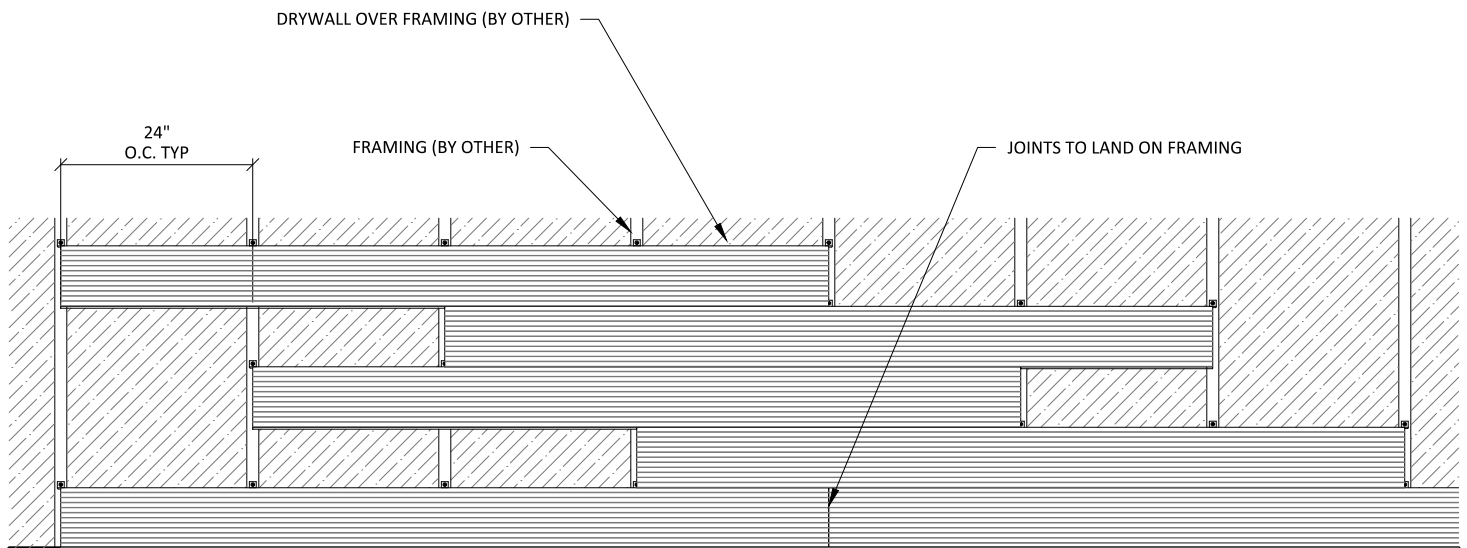


2

TYPICAL HORIZONTAL STAGGERED WALL PATTERN - 24 INCH SPACING


1/2" = 1'-0"

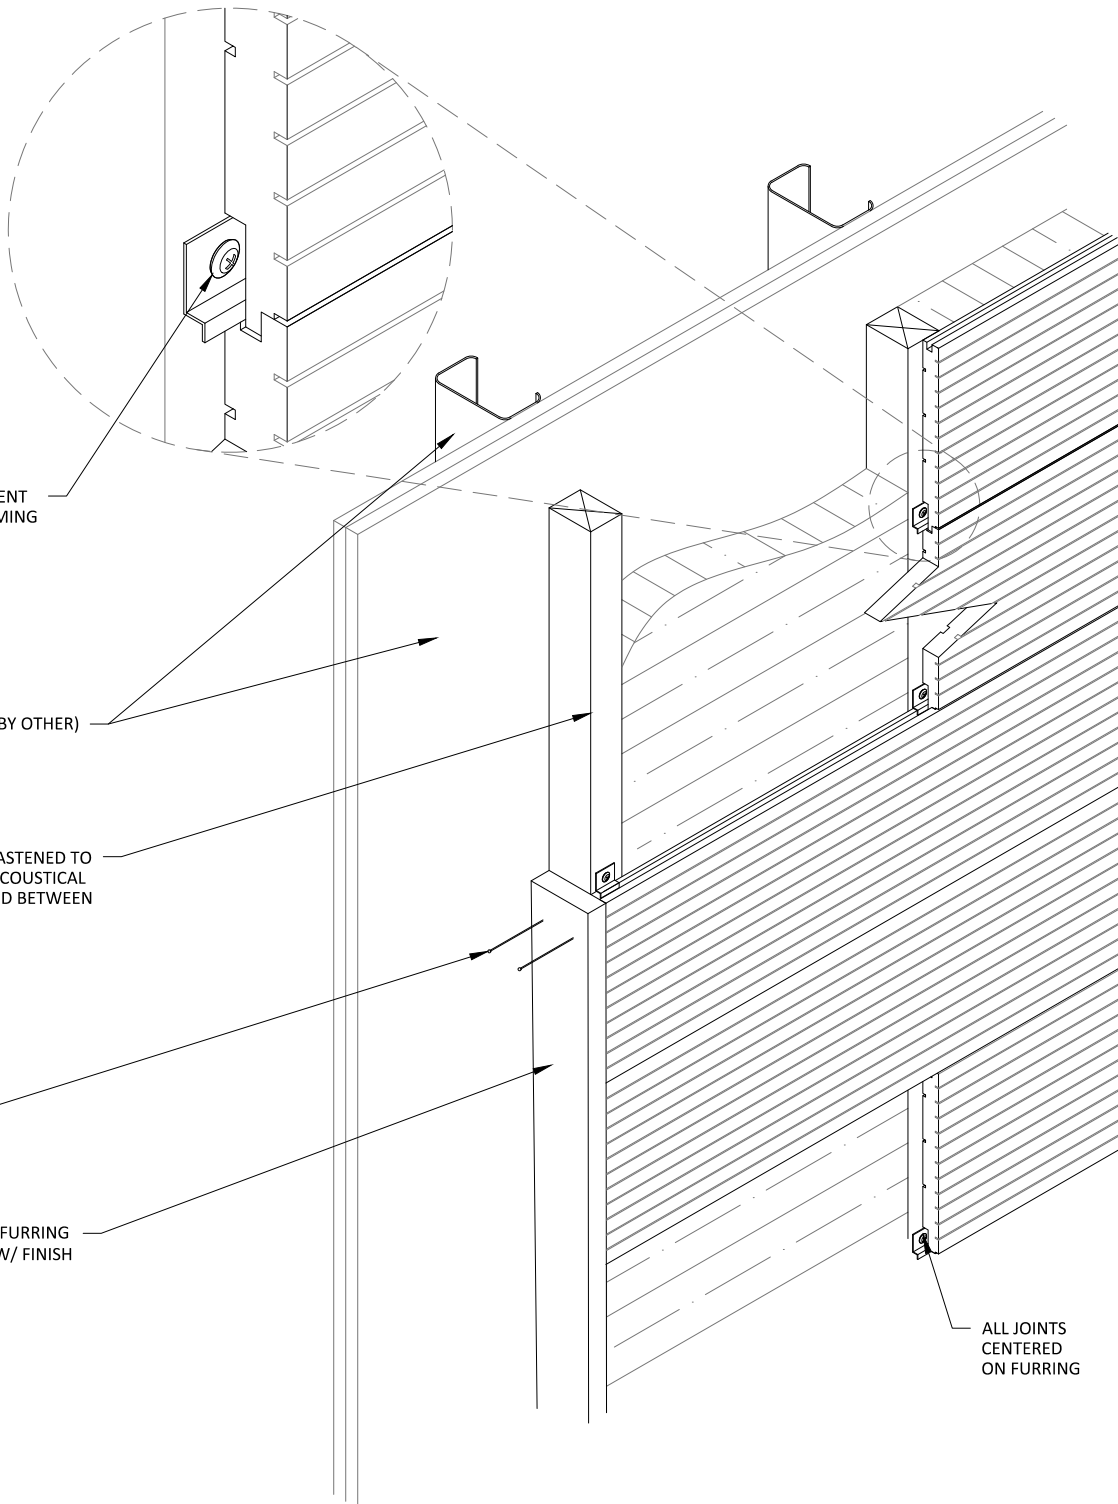

1 HORIZONTAL WALL SYSTEM ISOMETRIC
1 1/2" = 1'-0"

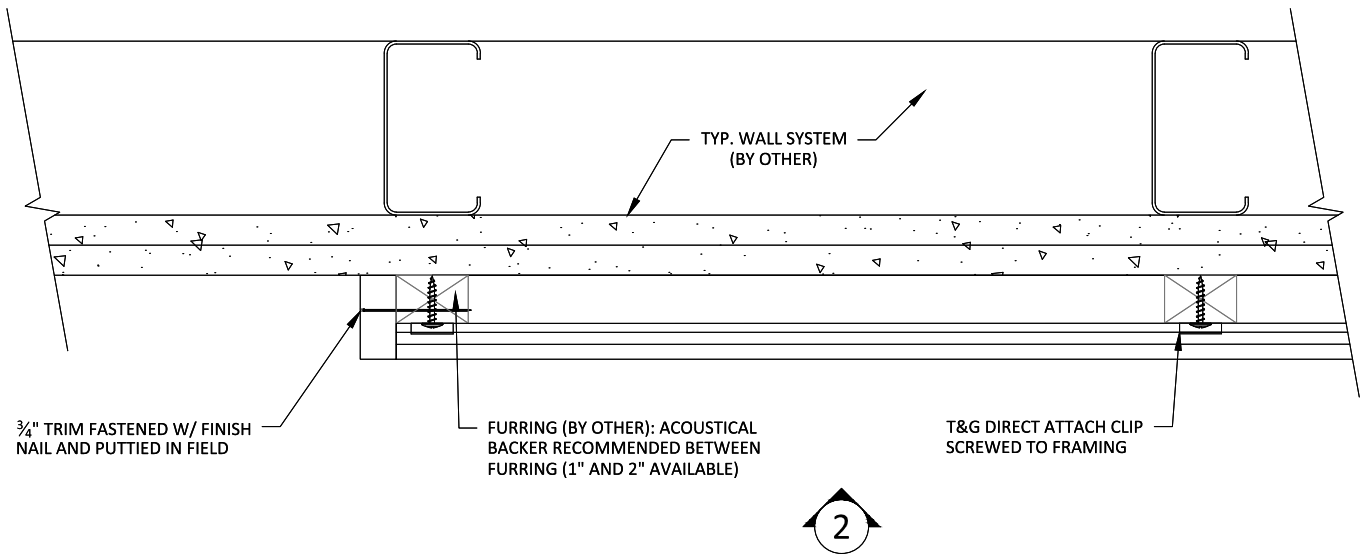

1 HORIZONTAL WALL PLAN @ TRIM
3" = 1'-0"

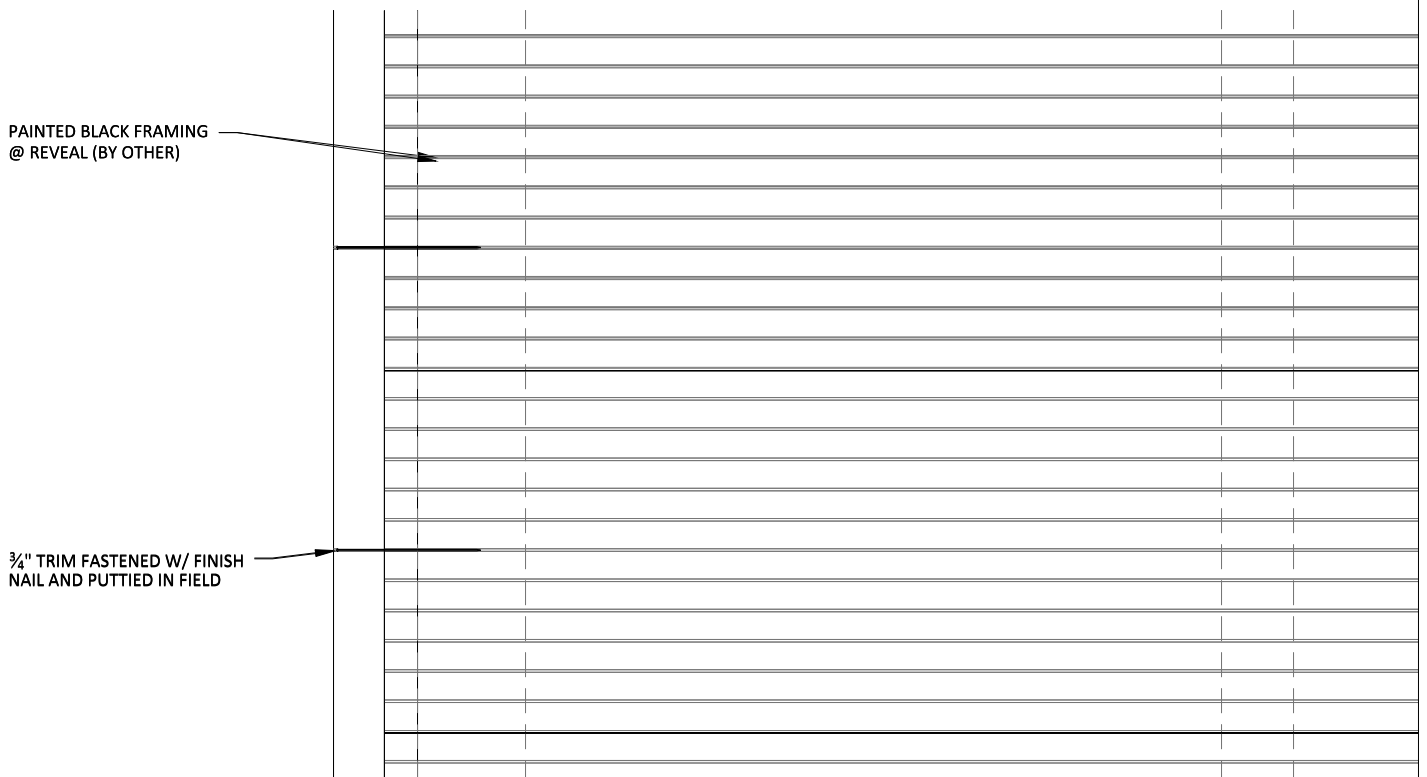


2 HORIZONTAL WALL ELEVATION @ TRIM
3" = 1'-0"

T&G DIRECT ATTACH CLIP
SCREWED TO FRAMING

FURRING (BY OTHER): ACOUSTICAL
BACKER RECOMMENDED BETWEEN
FURRING (1" AND 2" AVAILABLE)

TYP. WALL SYSTEM (BY OTHER)


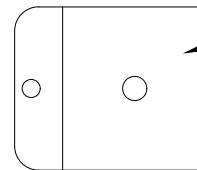


T&G DIRECT ATTACH CLIP

1 LINEAR VERTICAL WALL SECTION
3" = 1'-0"

2 DIRECT ATTACHMENT CLIP
1' = 1'-0"

NOTE: START PATTERN O.C. WITH REVEAL OR PLANK - WHICHEVER LEAVES THE LARGEST POSSIBLE BOARD WIDTH @ PERIMETER

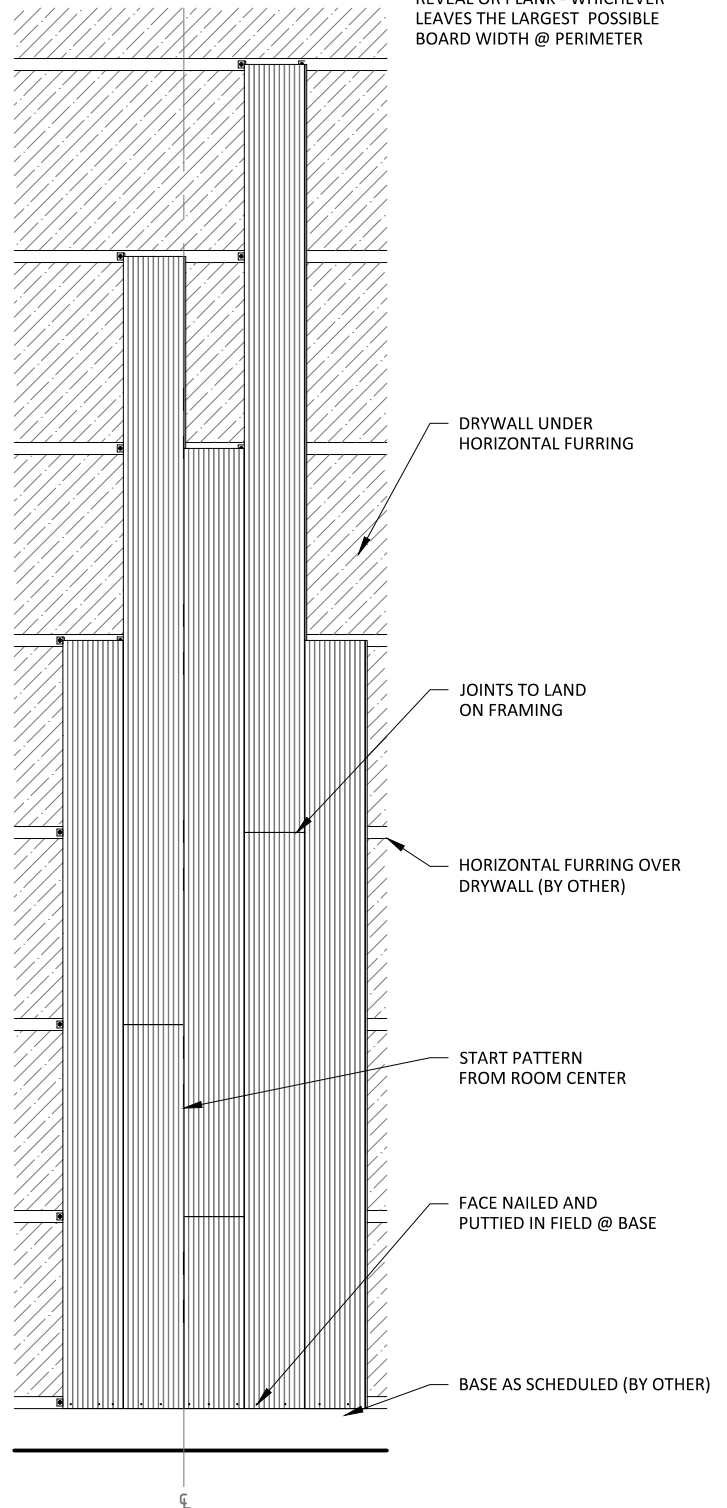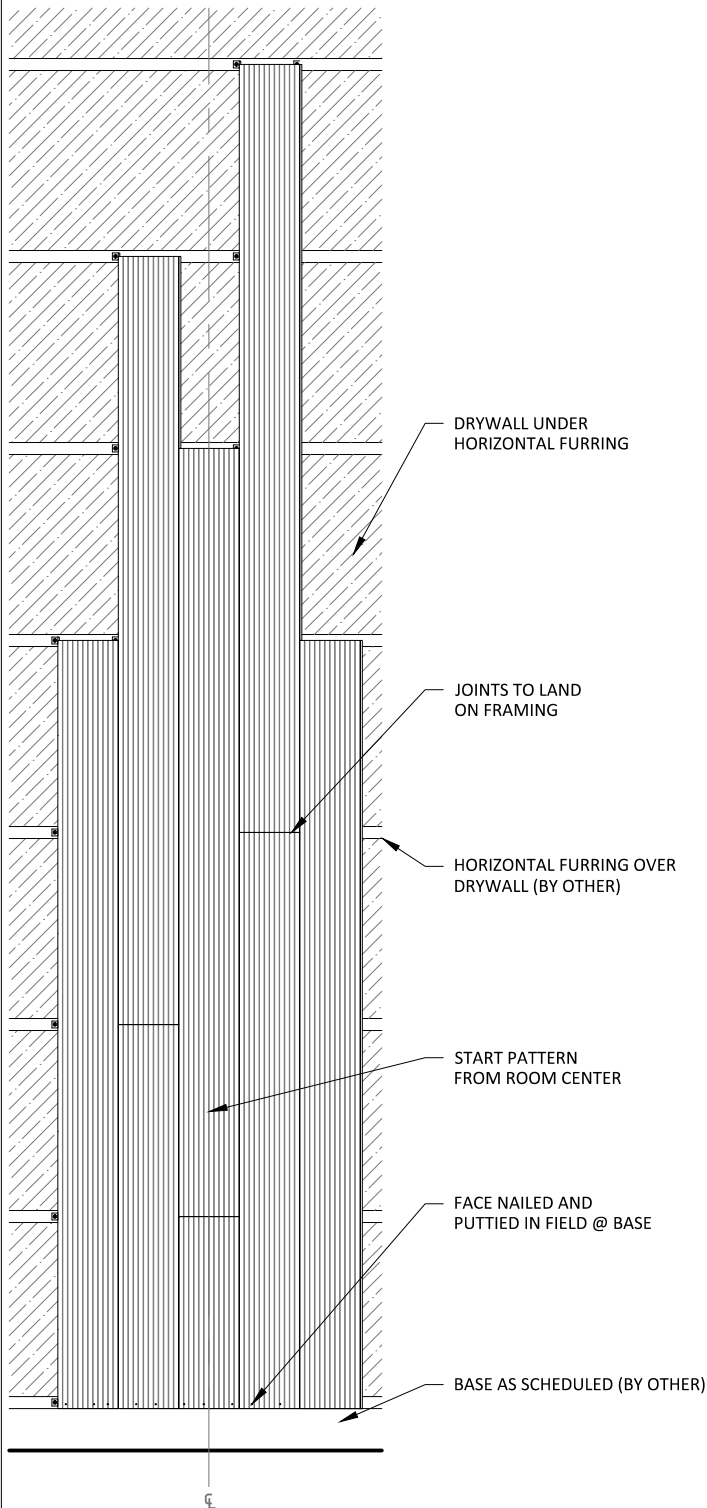

1 VERTICAL WALL PATTERN 1
1/2" = 1'-0"

1 VERTICAL WALL PATTERN 1
1/2" = 1'-0"

T&G DIRECT ATTACHMENT CLIP
SCREWED TO FRAMING IN FIELD

TYP. WALL SYSTEM (BY OTHER)

HORIZONTAL FURRING OVER DRYWALL
(BY OTHER): ACOUSTICAL BACKER
RECOMMENDED BETWEEN FURRING

16 GA. FINISH
NAIL (BY OTHER)


TRIM TO COINCIDE W/ FURRING
THICKNESS FASTENED W/ FINISH
NAIL (OPTIONAL)

ALL JOINTS
CENTERED
ON FRAMING


1

VERTICAL WALL SYSTEM ISOMETRIC


1 1/2" = 1'-0"

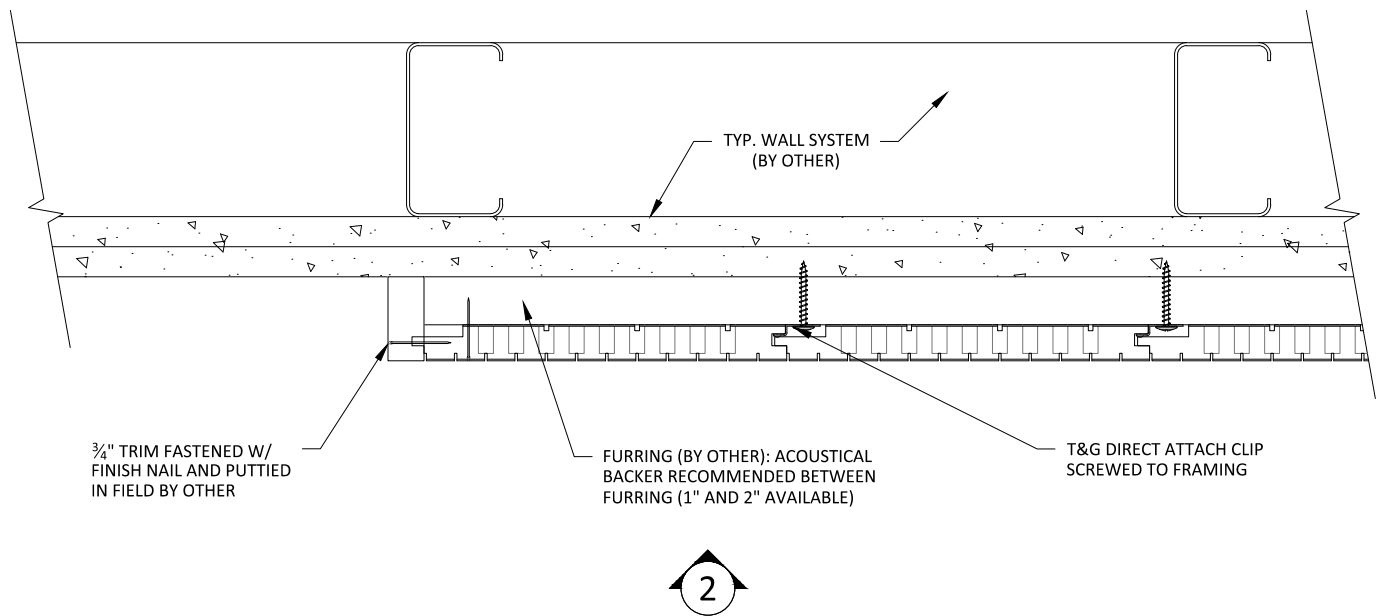


1 VERTICAL WALL PLAN @ TRIM
3" = 1'-0"

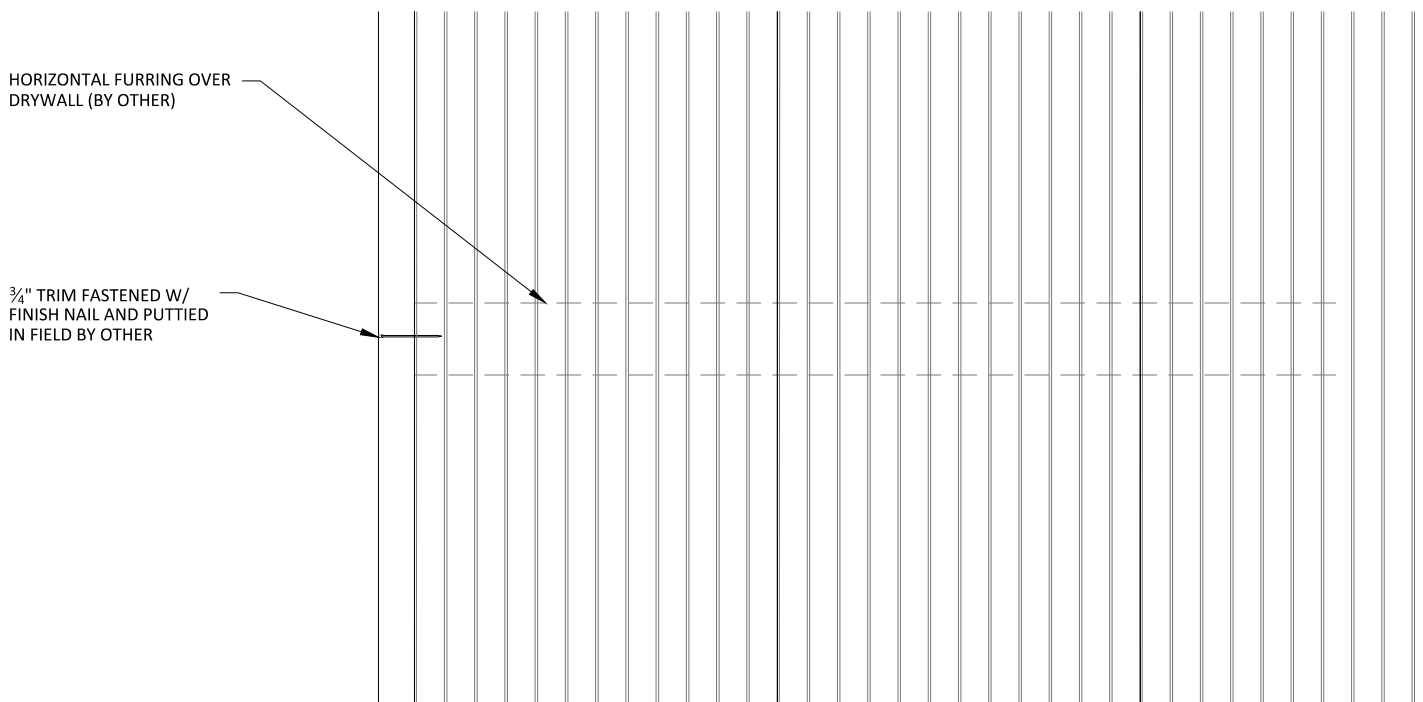


2 VERTICAL WALL ELEVATION @ TRIM
3" = 1'-0"

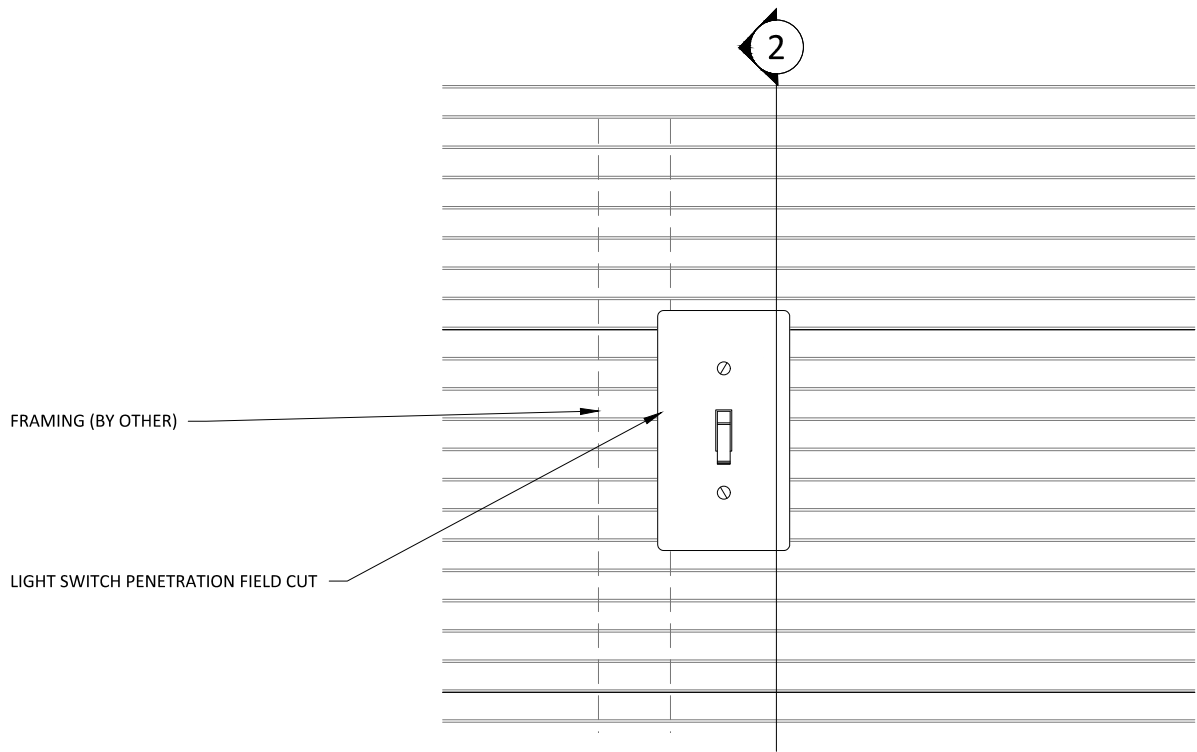


1 LIGHT SWITCH DETAIL - ELEVATION
3" = 1'-0"

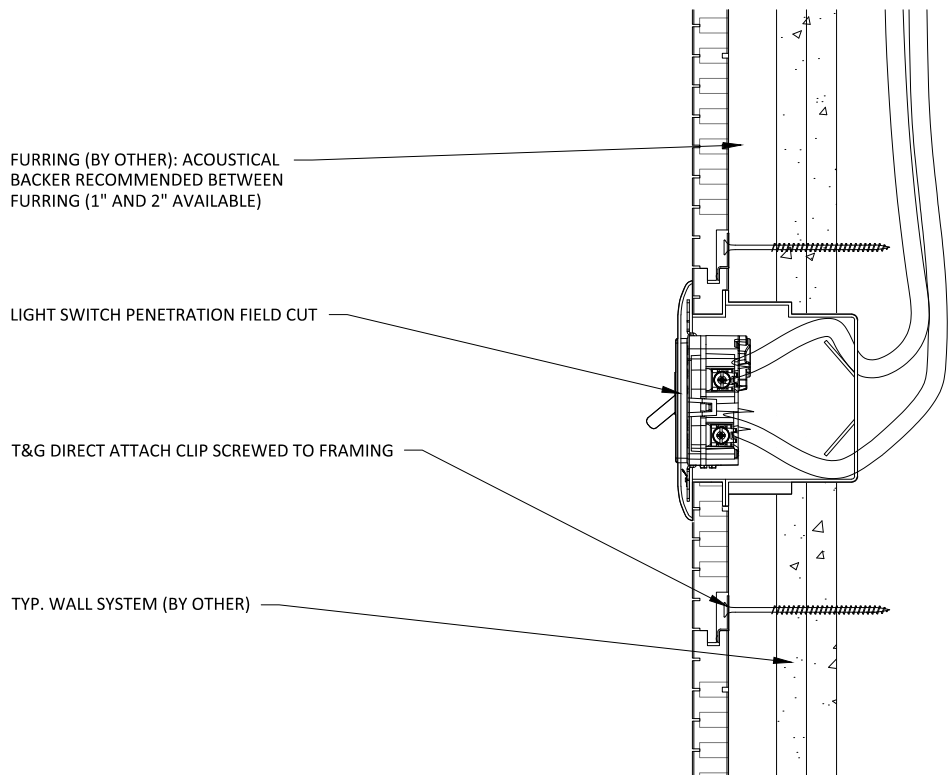


2 LIGHT SWITCH DETAIL - SECTION
3" = 1'-0"

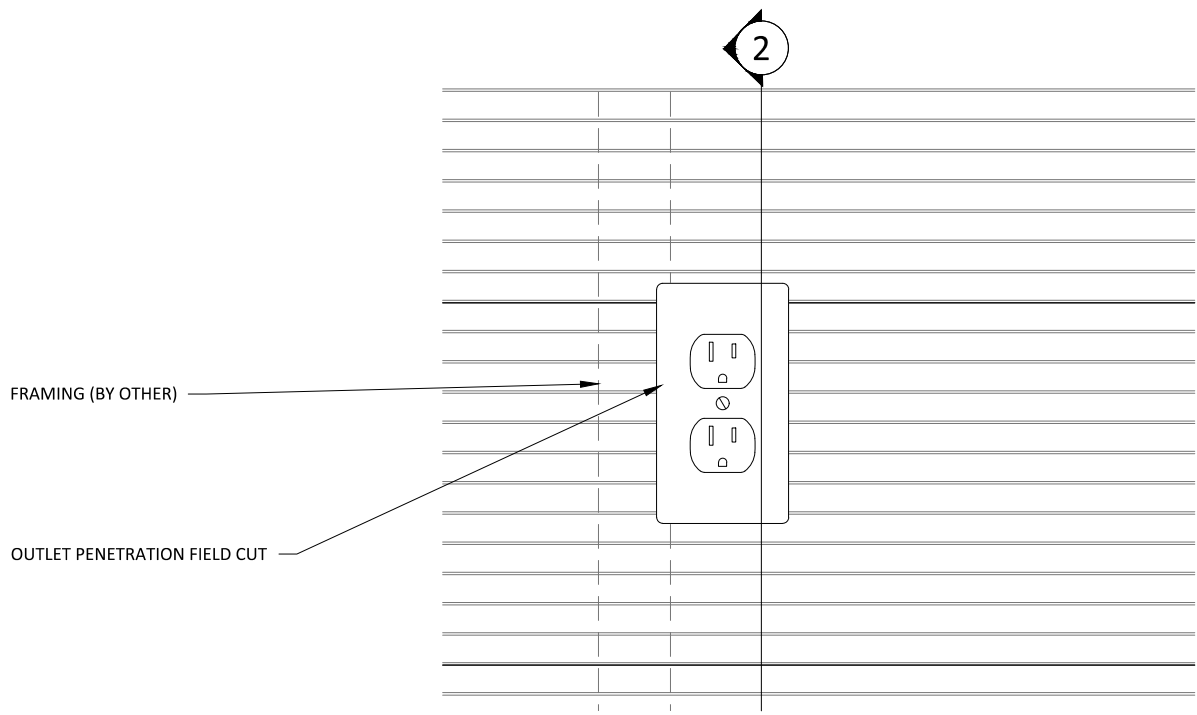

1 OUTLET DETAIL - ELEVATION
3" = 1'-0"

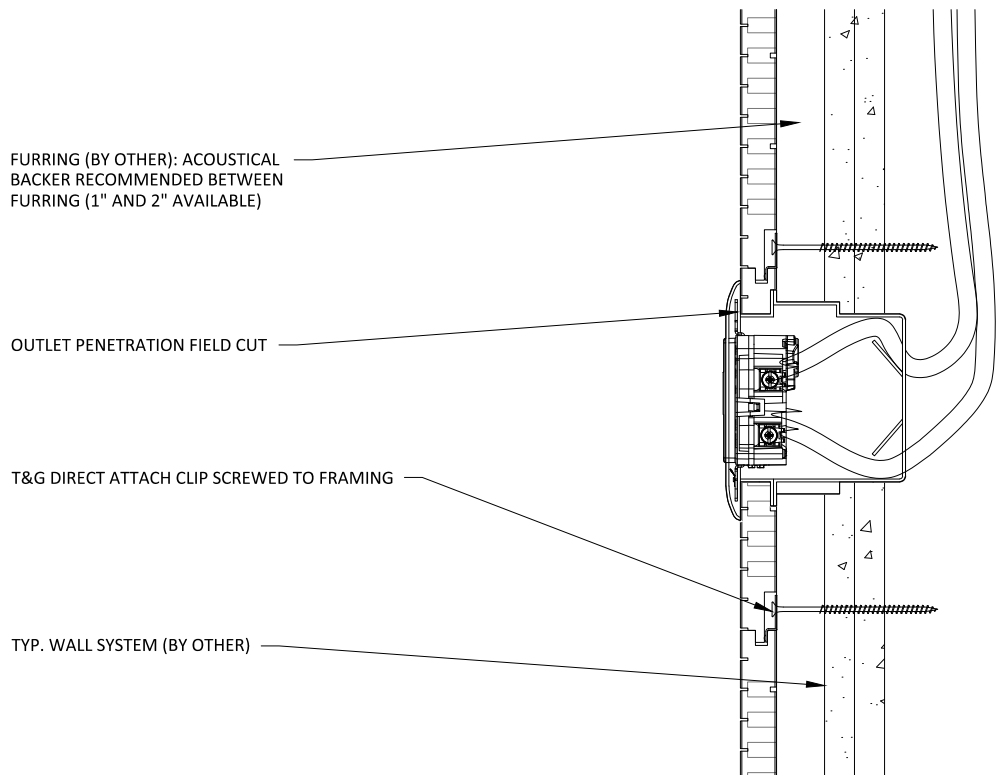


2 OUTLET DETAIL - SECTION
3" = 1'-0"

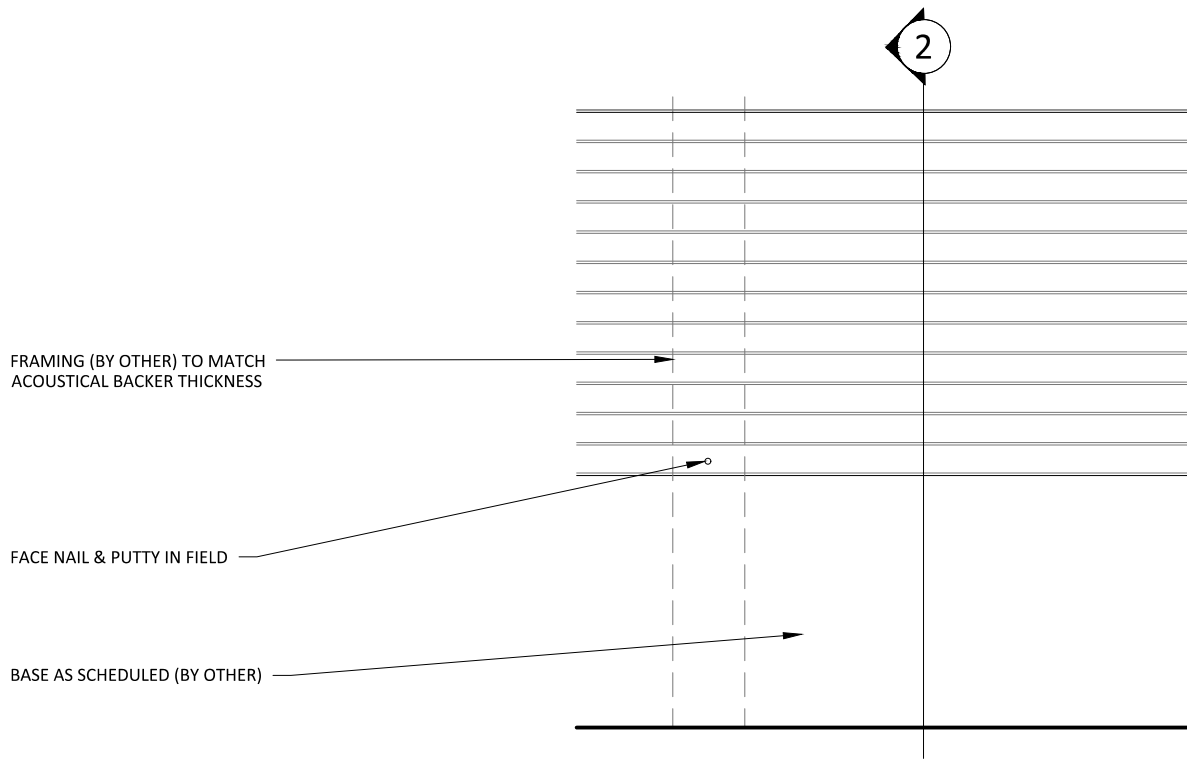

1 BASEBOARD DETAIL - ELEVATION

3" = 1'-0"

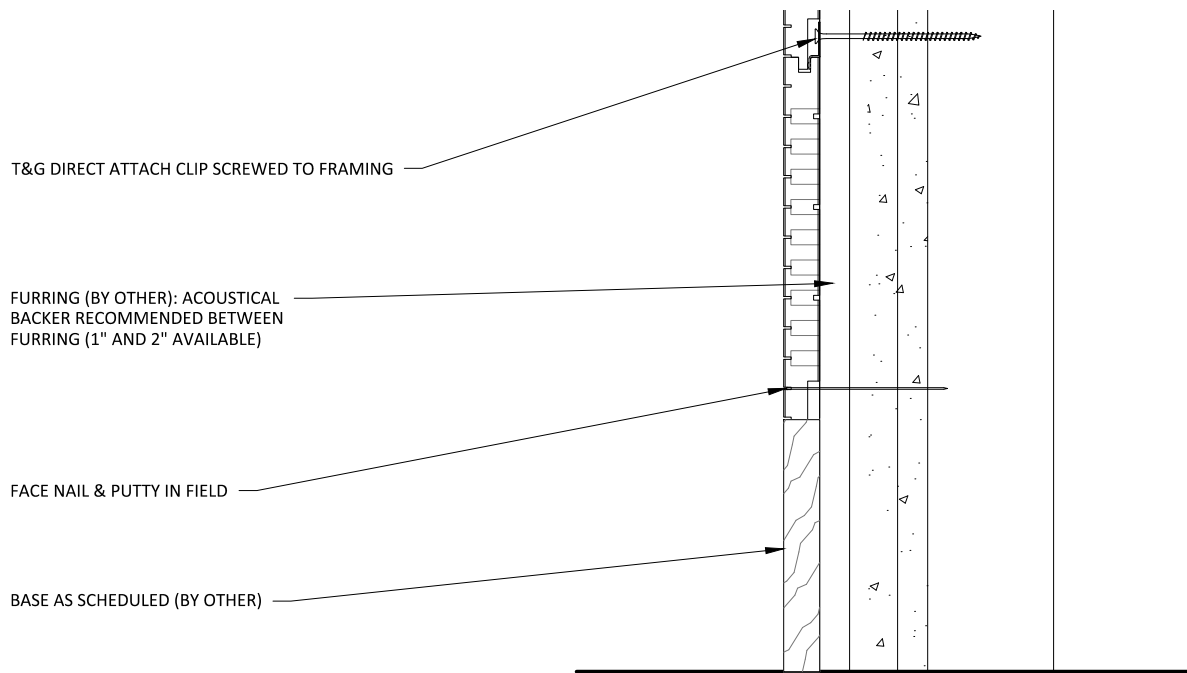

2 BASEBOARD DETAIL - SECTION

3" = 1'-0"

FURRING (BY OTHER): ACOUSTICAL
BACKER RECOMMENDED BETWEEN
FURRING (1" AND 2" AVAILABLE)

FIELD CUT

FACE NAIL IN FIELD

T&G DIRECT ATTACH CLIP SCREWED TO FRAMING

TYPICAL WALL ASSEMBLY (BY OTHER)

1

VERTICAL PLANK INSIDE CORNER PLAN

3" = 1'-0"

FURRING (BY OTHER): ACOUSTICAL
BACKER RECOMMENDED BETWEEN
FURRING (1" AND 2" AVAILABLE)

TYPICAL WALL ASSEMBLY
(BY OTHER)

T&G DIRECT ATTACH CLIP
SCREWED TO FURRING

FACE NAIL IN FIELD

OUTSIDE CORNER MOULDING


FIELD CUT

3

2

VERTICAL PLANK OUTSIDE CORNER PLAN


3" = 1'-0"

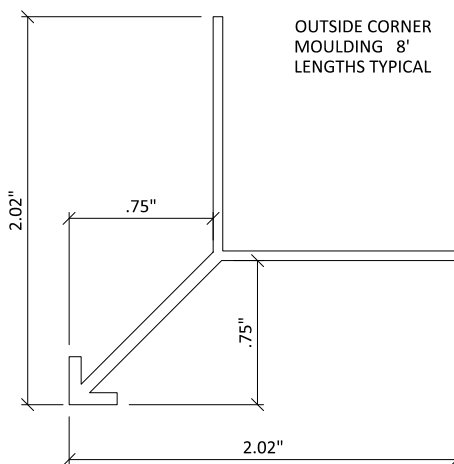

3


SECTION (WDOCT)

1' = 1'-0"

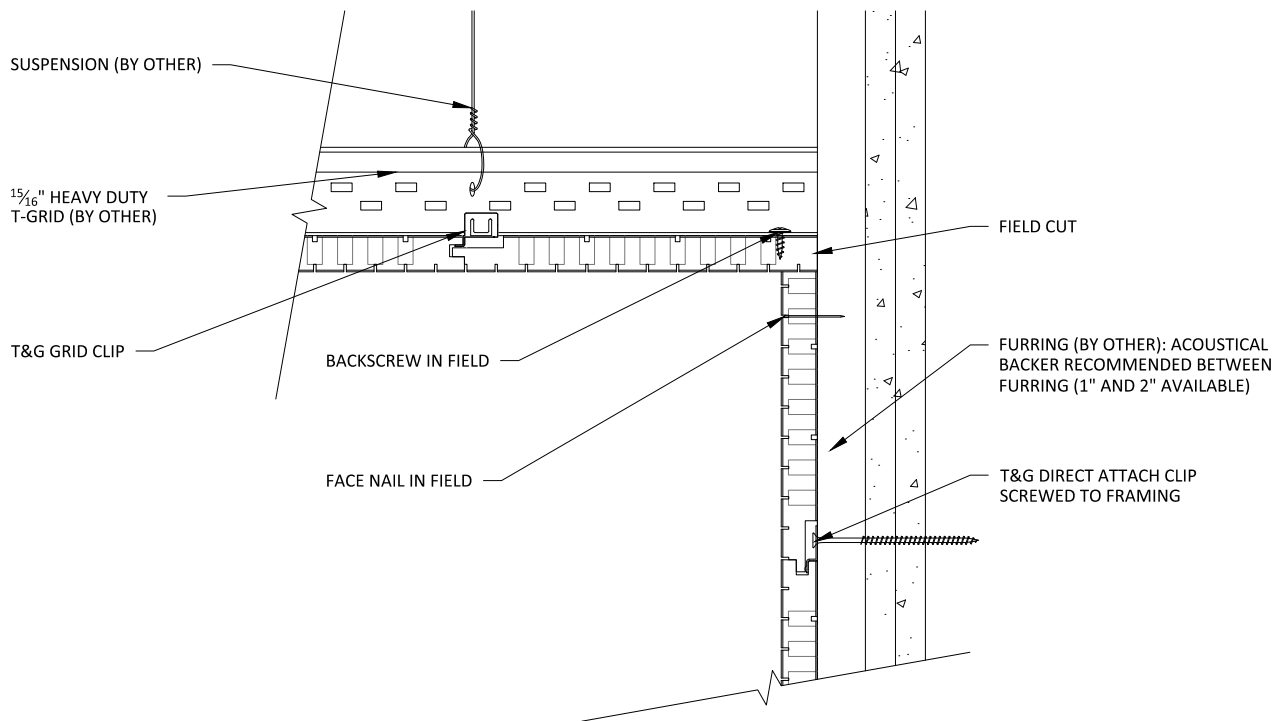


1 WALL-TO-CEILING TRANSITION

3" = 1'-0"

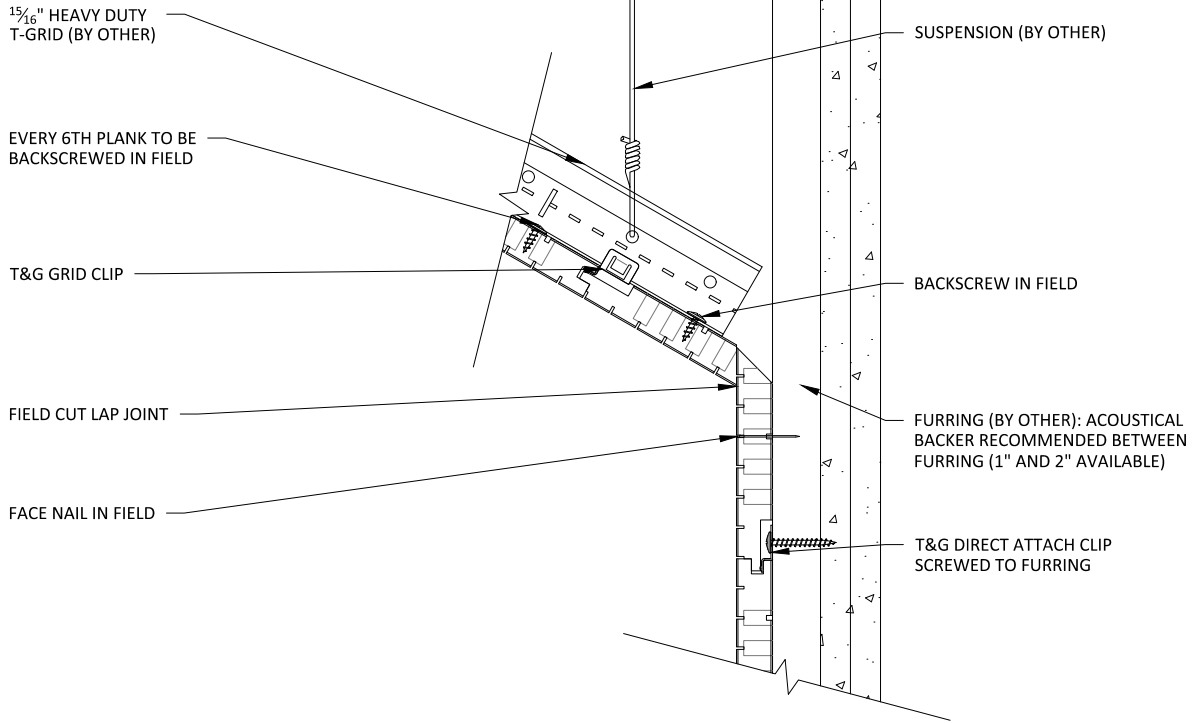


1 HORIZONTAL WALL-TO-VAULTED CEILING

3" = 1'-0"

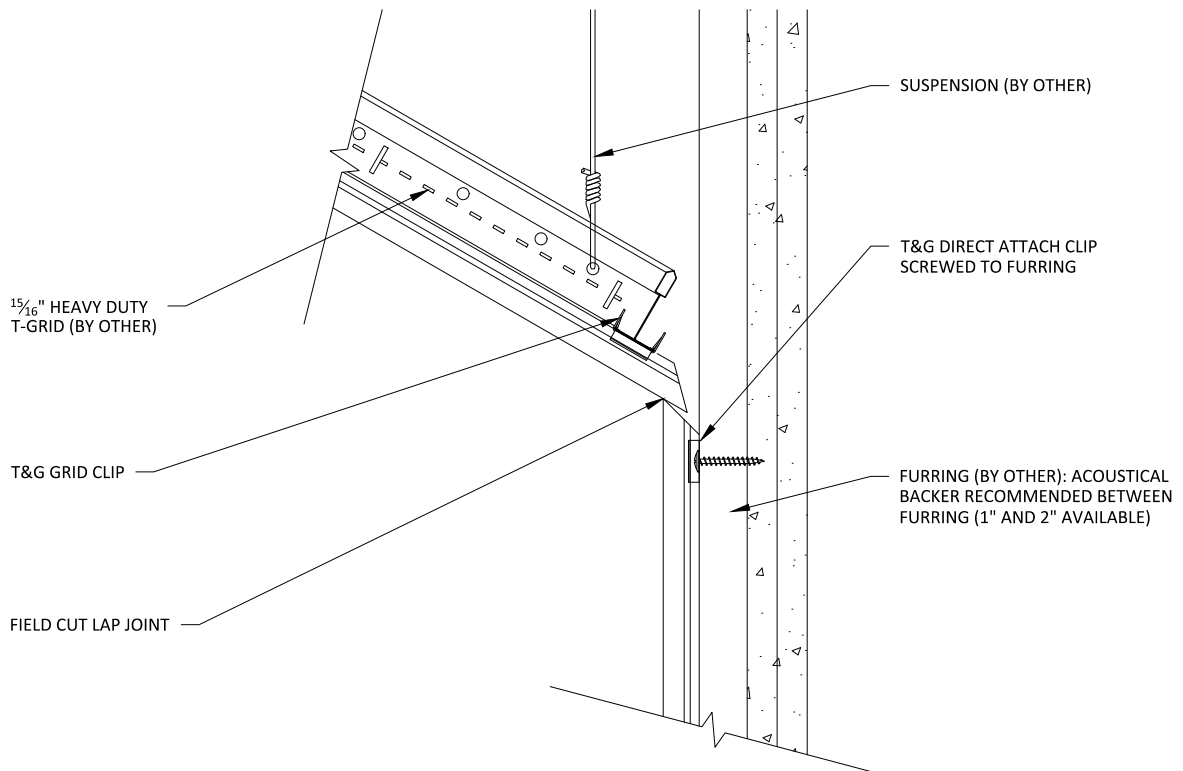


2 VERTICAL WALL-TO-VAULTED CEILING


3" = 1'-0"

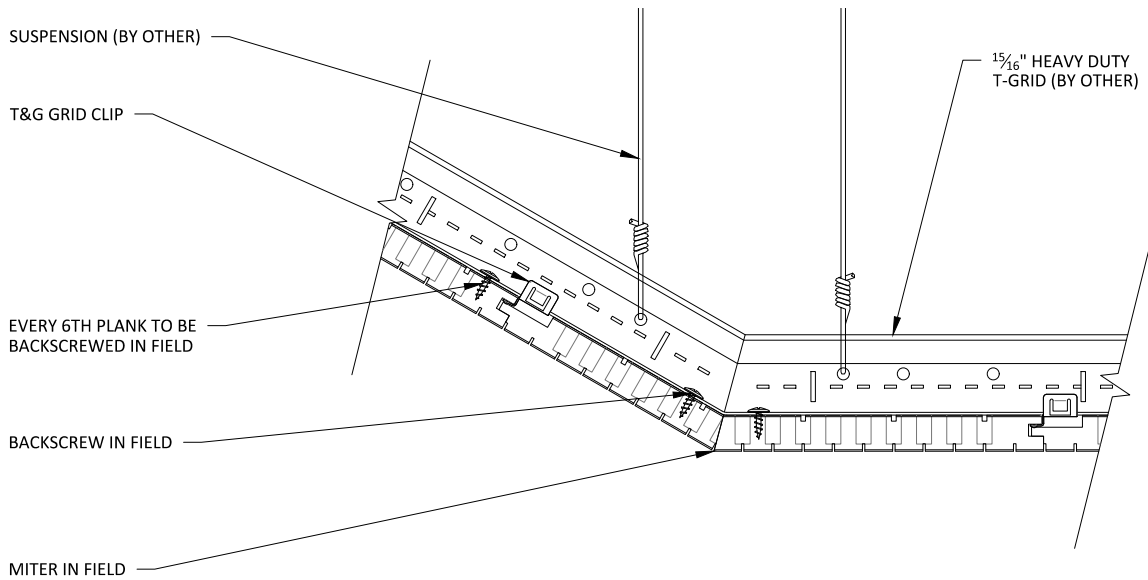

1 HORIZONTAL VAULTED CEILING RETURN
3" = 1'-0"

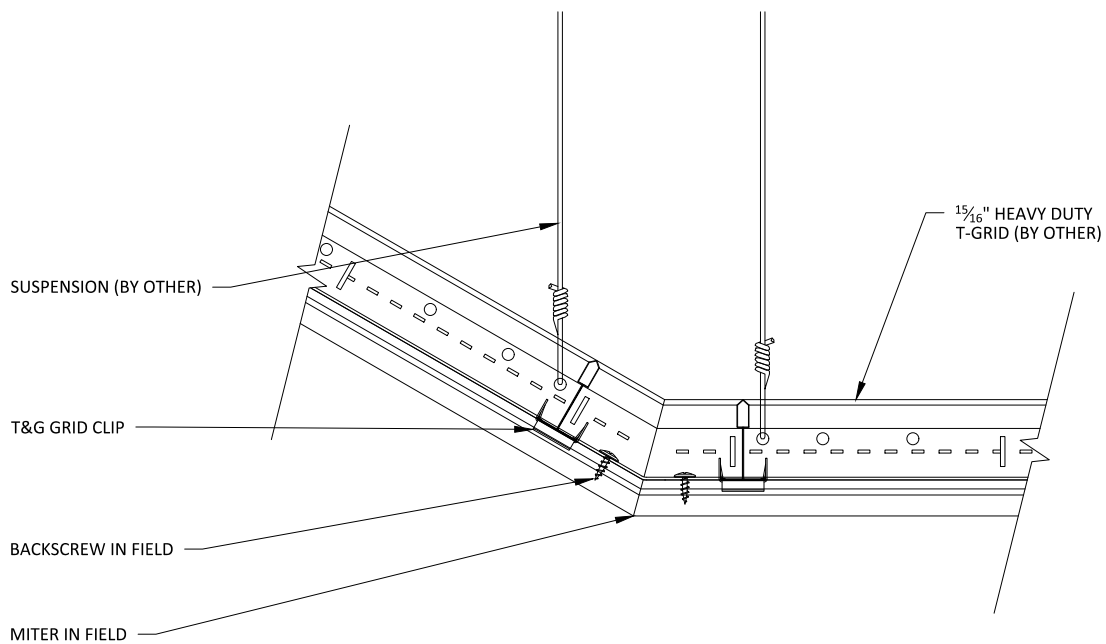


2 VERTICAL VAULTED CEILING RETURN
3" = 1'-0"

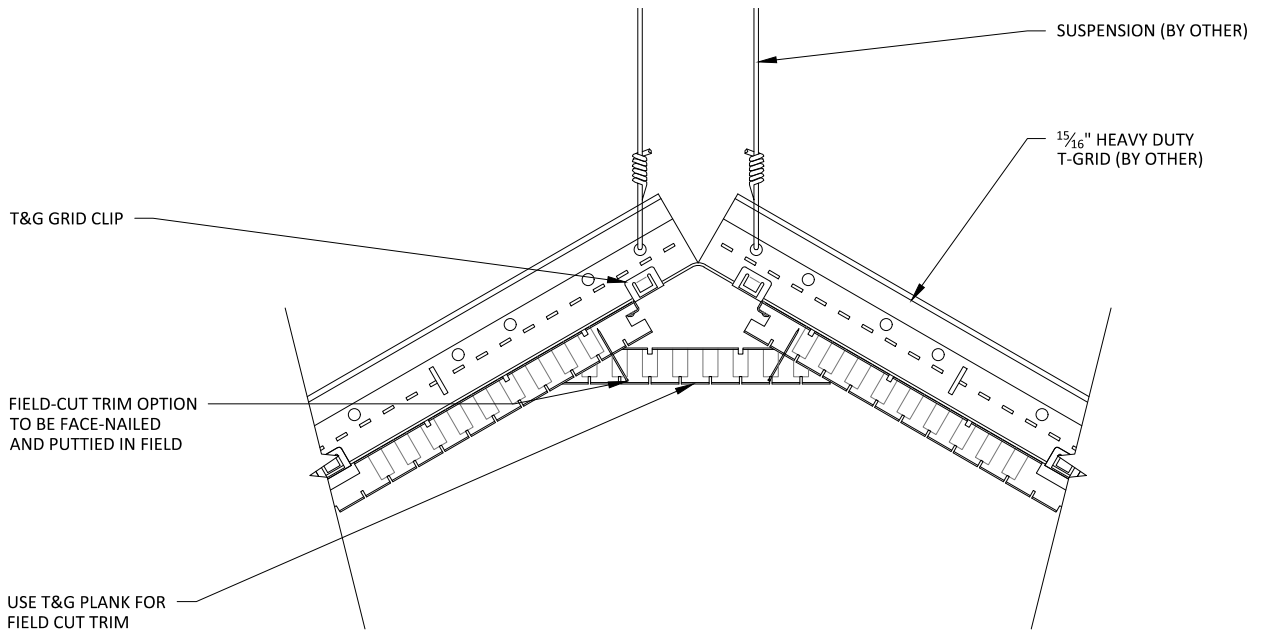


1 HORIZONTAL VAULTED CEILING PEAK

3" = 1'-0"

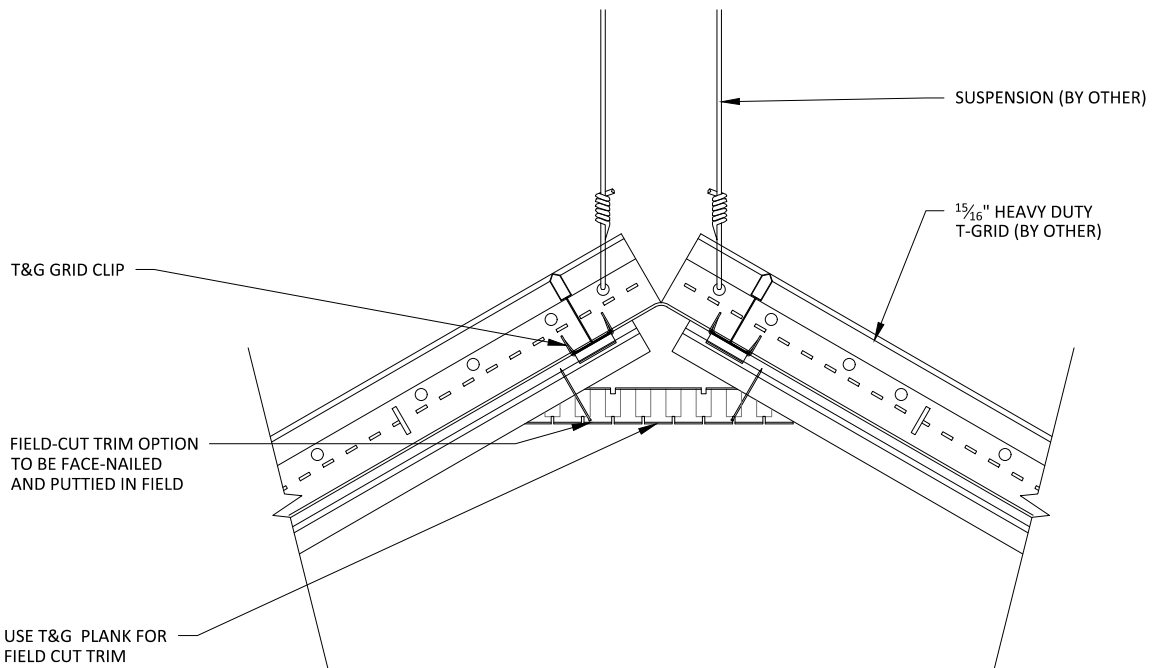


2 VERTICAL VAULTED CEILING PEAK

3" = 1'-0"

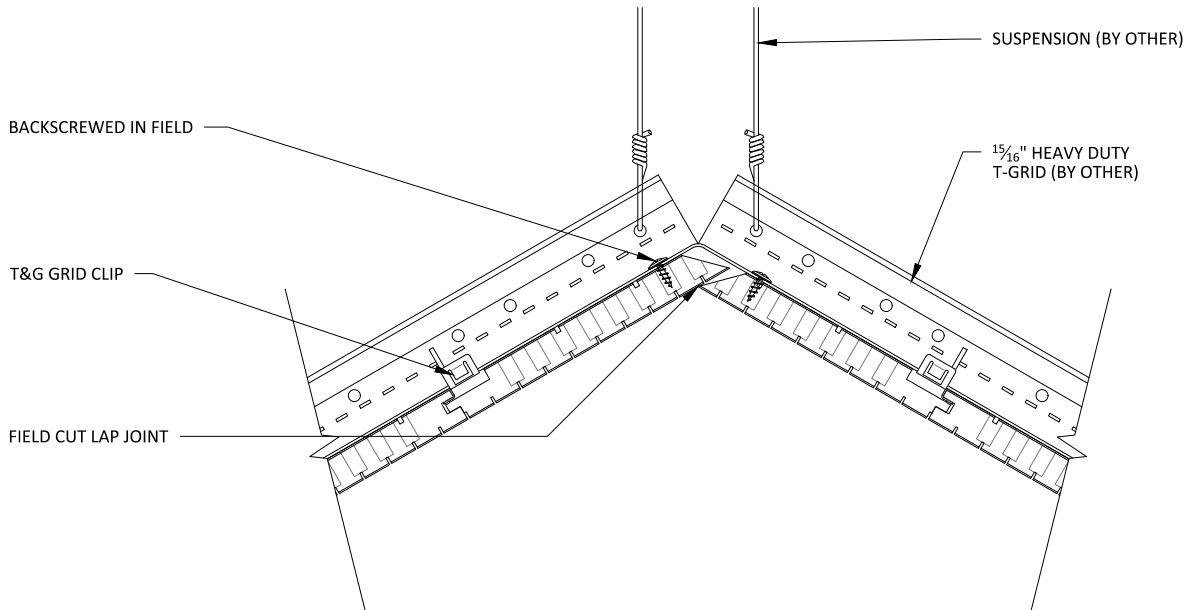

1 HORIZONTAL VAULTED CEILING PEAK - LAP JOINT
3" = 1'-0"

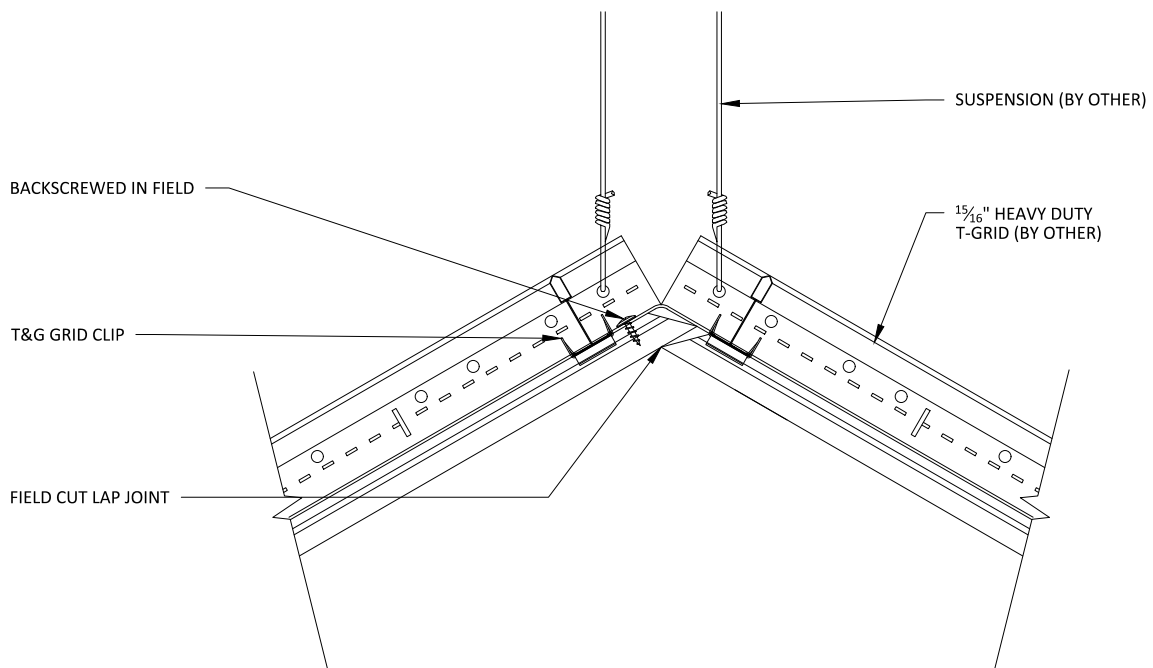

2 VERTICAL VAULTED CEILING PEAK - LAP JOINT
3" = 1'-0"