

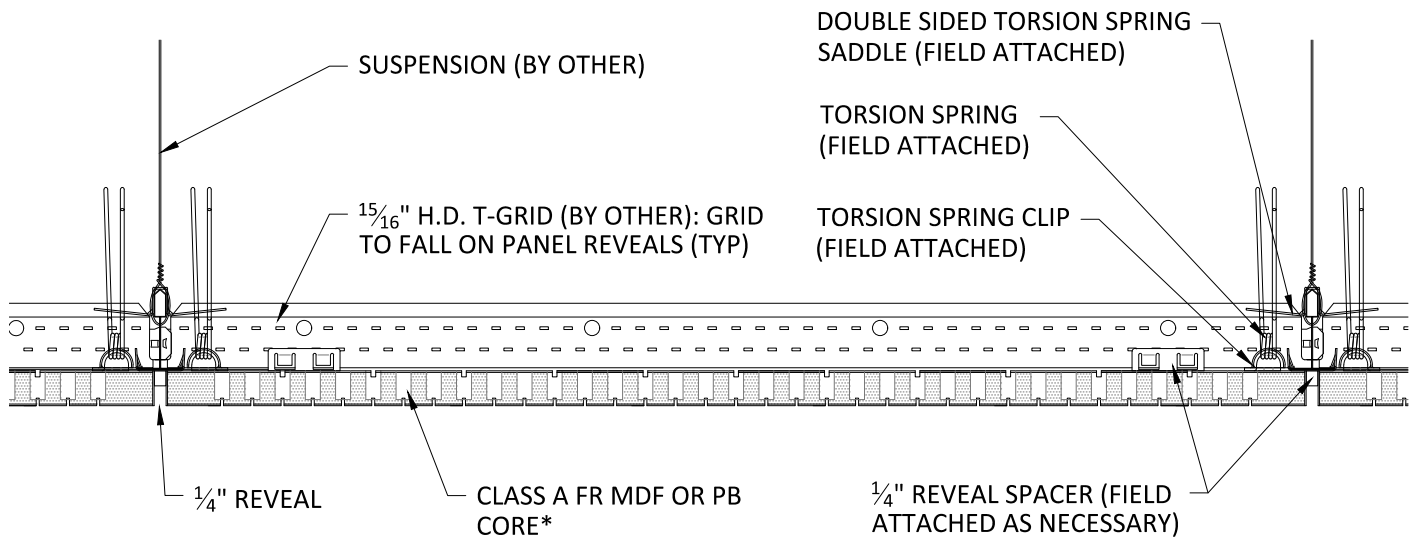


* PANELS MAY BE PERFORATED (AS SPECIFIED) IN WHICH CASE, ACOUSTICAL BACKER IS RECOMMENDED (1" OR 2" OPTIONS)

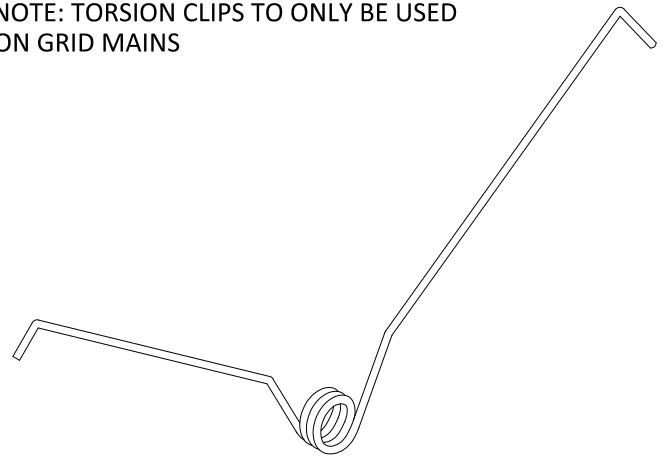


1 TYPICAL SECTION
3" = 1'-0"

NOTE: TORSION CLIPS TO ONLY BE USED
ON GRID MAINS

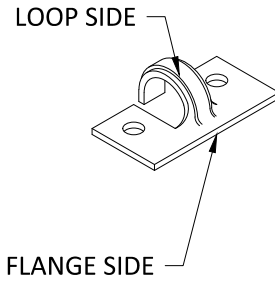


1 TORSION SPRING CLIP
6" = 1'-0"


2 TORSION SPRING
6" = 1'-0"

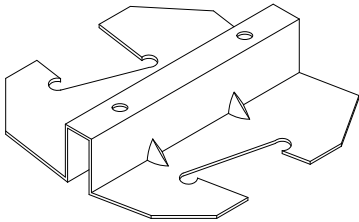


ISOMETRIC

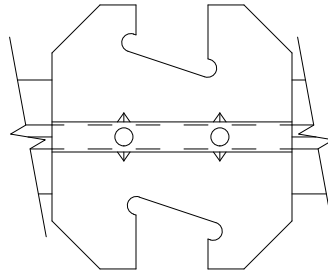

TOP VIEW ON GRID

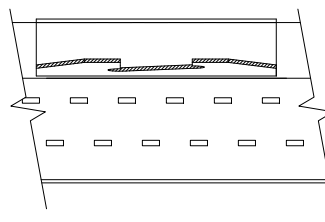


SIDE VIEW ON
GRID

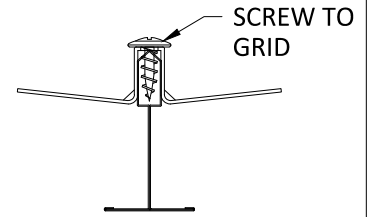


PROFILE VIEW ON
GRID


3 DOUBLE-SIDED SADDLE
6" = 1'-0"

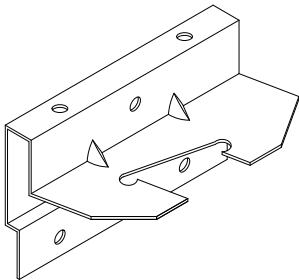


ISOMETRIC

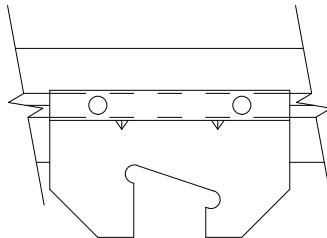

TOP VIEW ON GRID

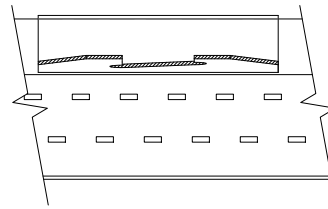


SIDE VIEW ON
GRID

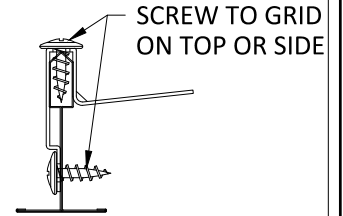


PROFILE VIEW ON
GRID


4 SINGLE-SIDED SADDLE
6" = 1'-0"

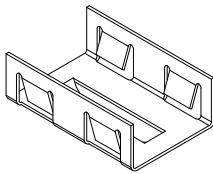


ISOMETRIC

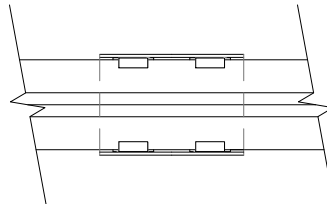

TOP VIEW ON GRID

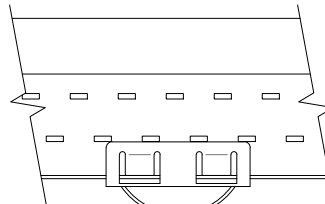


SIDE VIEW ON
GRID

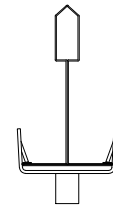

PROFILE VIEW ON
GRID


5 SPACER CLIP
6" = 1'-0"

NOTE: TORSION SPRING SADDLES TO
BE ATTACHED TO T-GRID MAINS ONLY

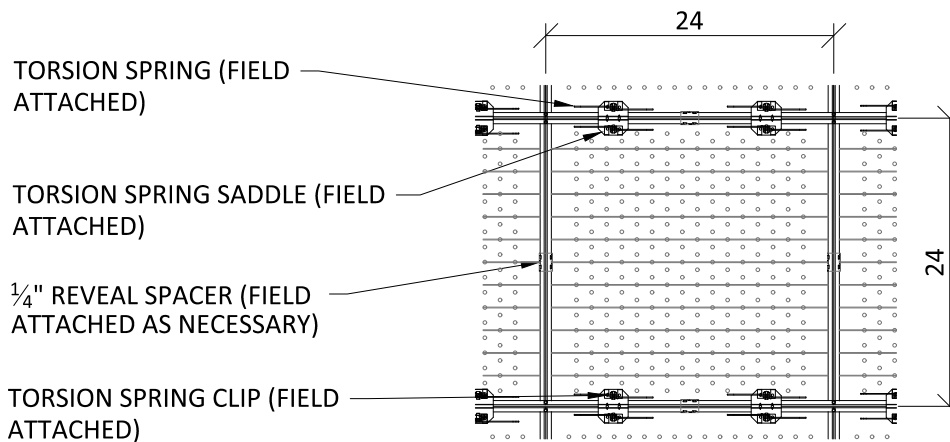

1 TYPICAL 2X2 PANEL PLAN
3/4" = 1'-0"

NOTE: TORSION SPRING SADDLES TO
BE ATTACHED TO T-GRID MAINS ONLY

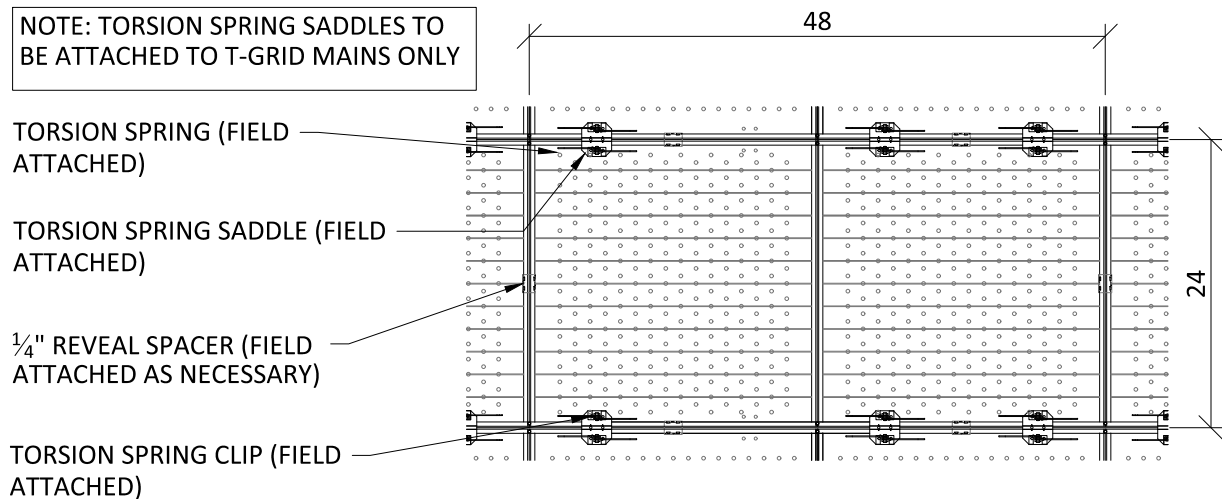

2 TYPICAL 2X4 PANEL PLAN
3/4" = 1'-0"


NOTE: TORSION SPRING SADDLES TO
BE ATTACHED TO T-GRID MAINS ONLY

TORSION SPRING (FIELD
ATTACHED)

TORSION SPRING SADDLE
(FIELD ATTACHED)


1/4" REVEAL SPACER (FIELD
ATTACHED AS NECESSARY)

TORSION SPRING CLIP (FIELD
ATTACHED)

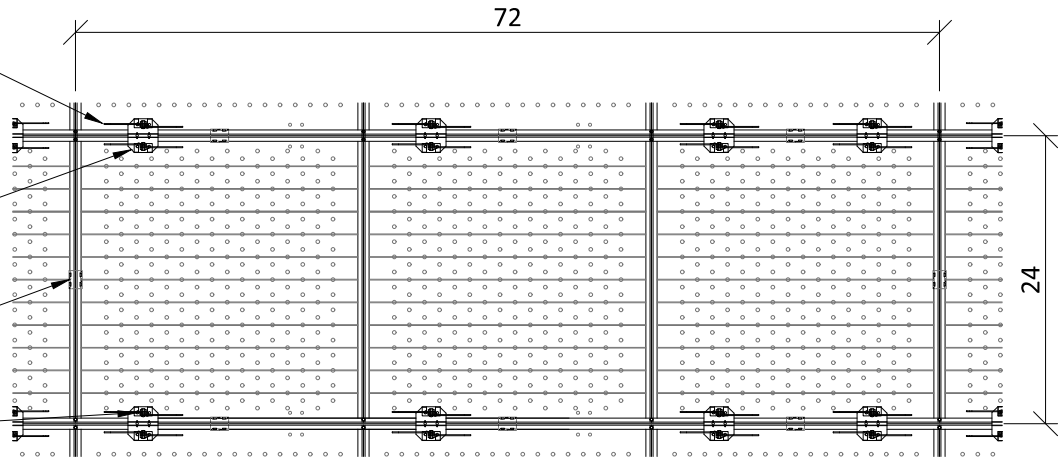

1 TYPICAL 2X6 PANEL PLAN
3/4" = 1'-0"

NOTE: TORSION SPRING SADDLES TO
BE ATTACHED TO T-GRID MAINS ONLY

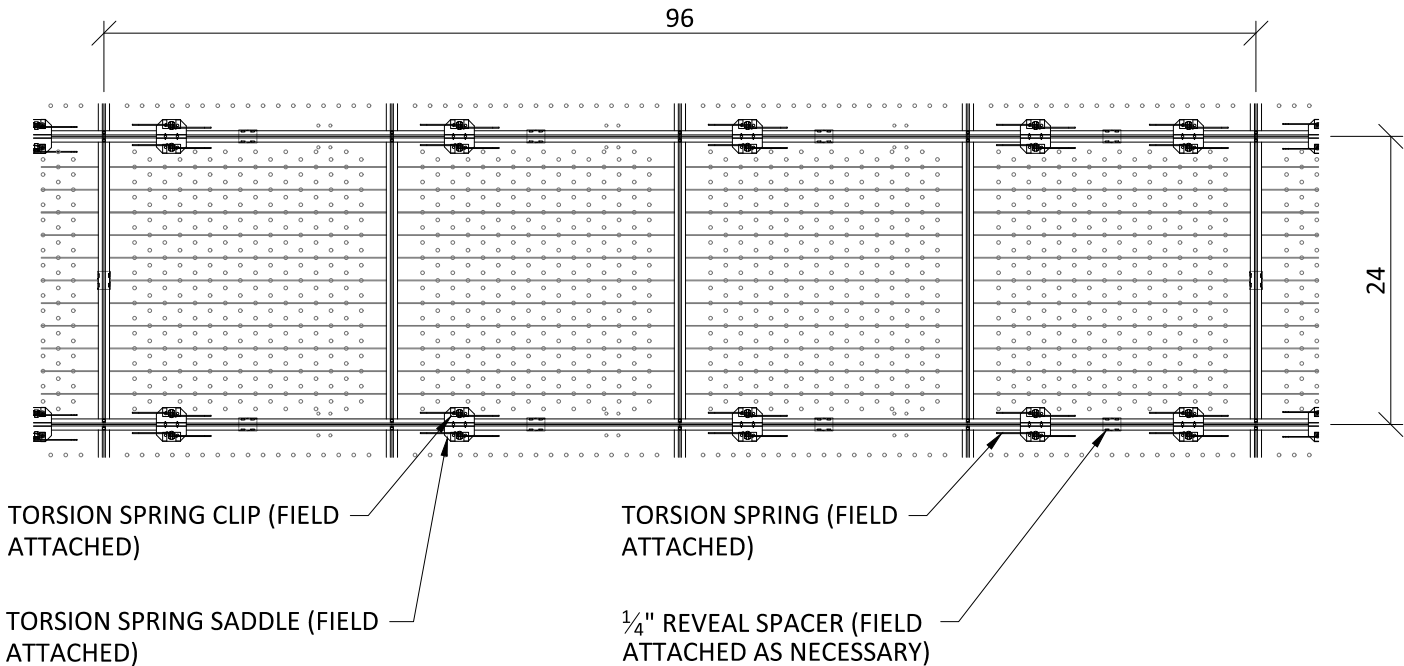


TORSION SPRING CLIP (FIELD
ATTACHED)

TORSION SPRING SADDLE (FIELD
ATTACHED)

TORSION SPRING (FIELD
ATTACHED)


1/4" REVEAL SPACER (FIELD
ATTACHED AS NECESSARY)

2 TYPICAL 2X8 PANEL PLAN
3/4" = 1'-0"

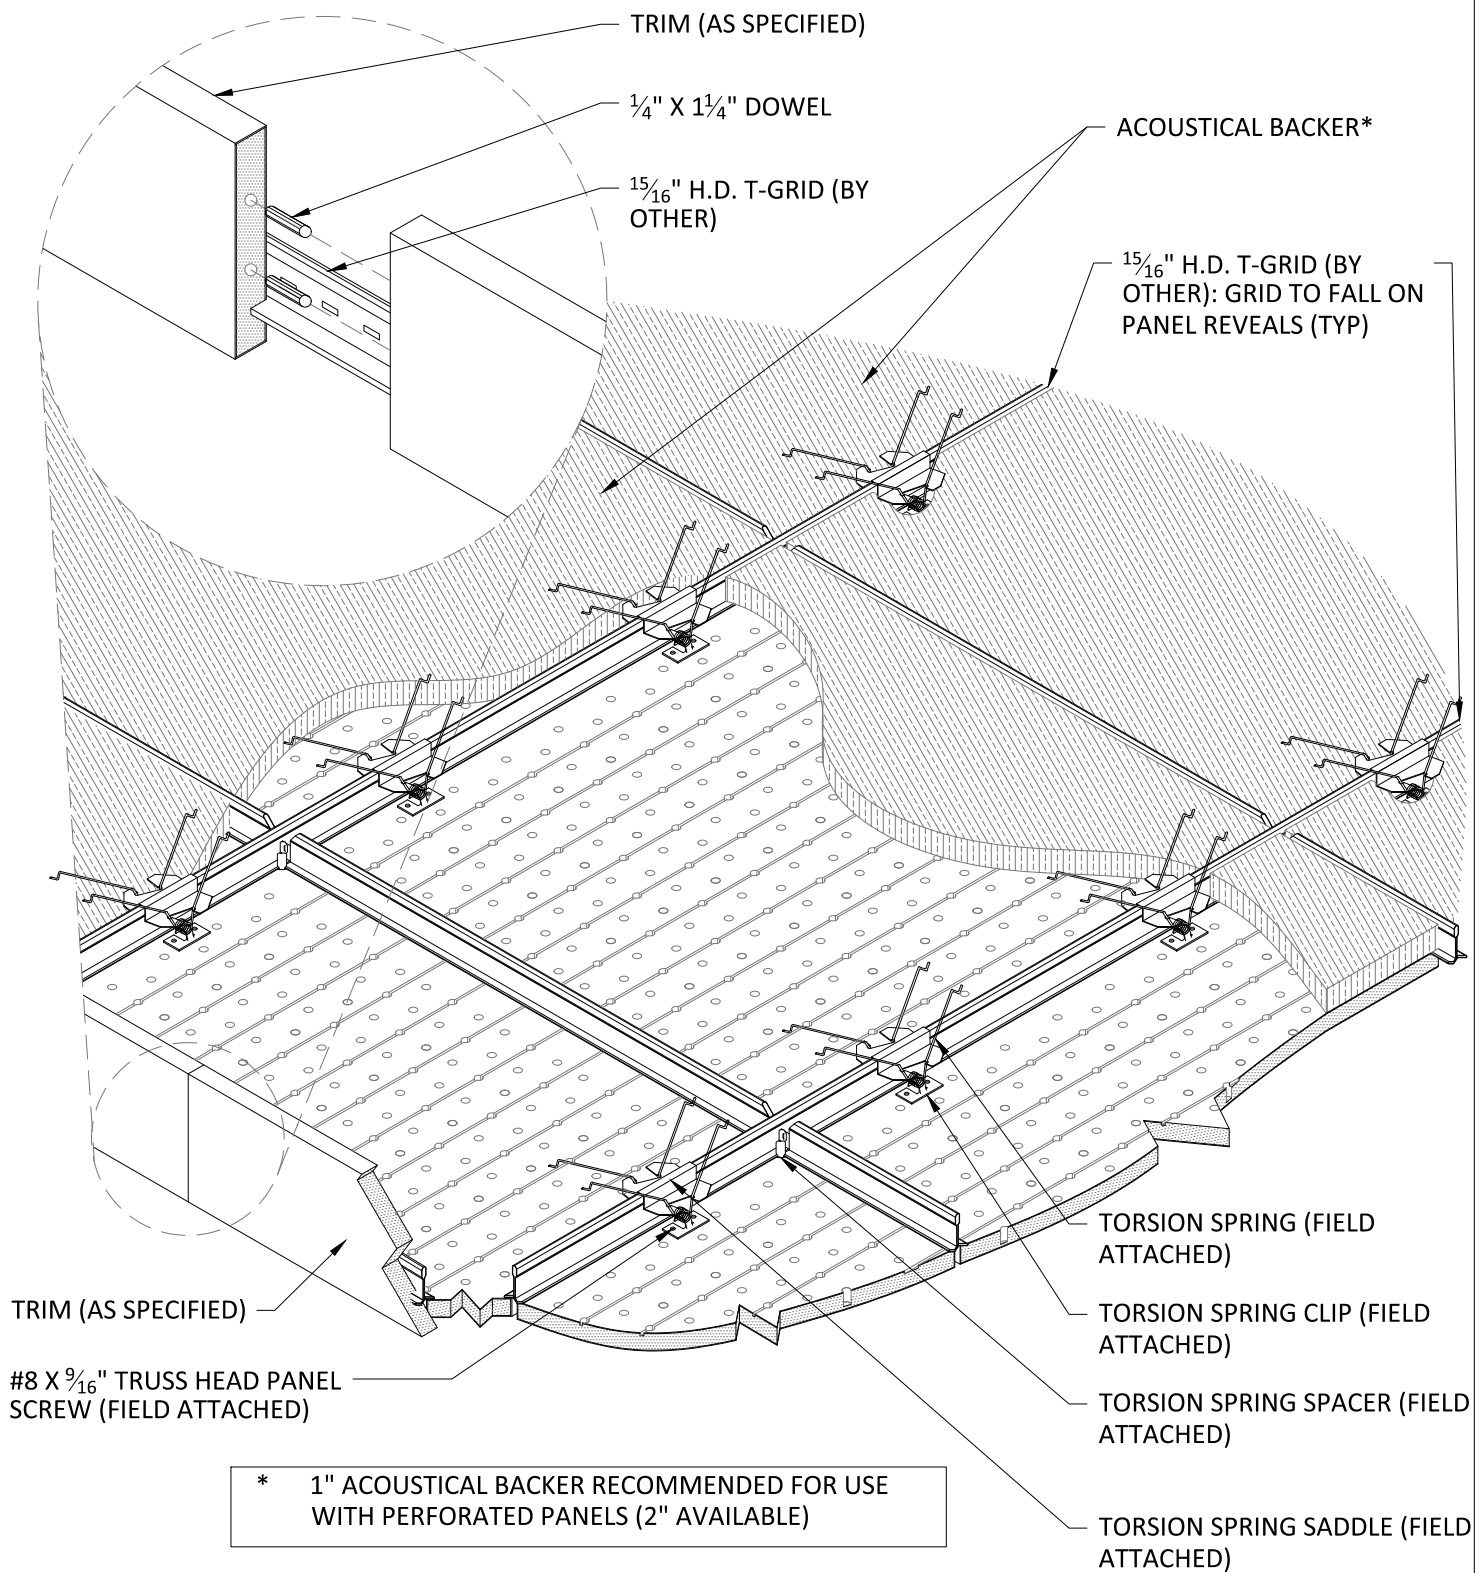

1 TYPICAL 2X2 PANEL ISOMETRIC


1 1/2" = 1'-0"

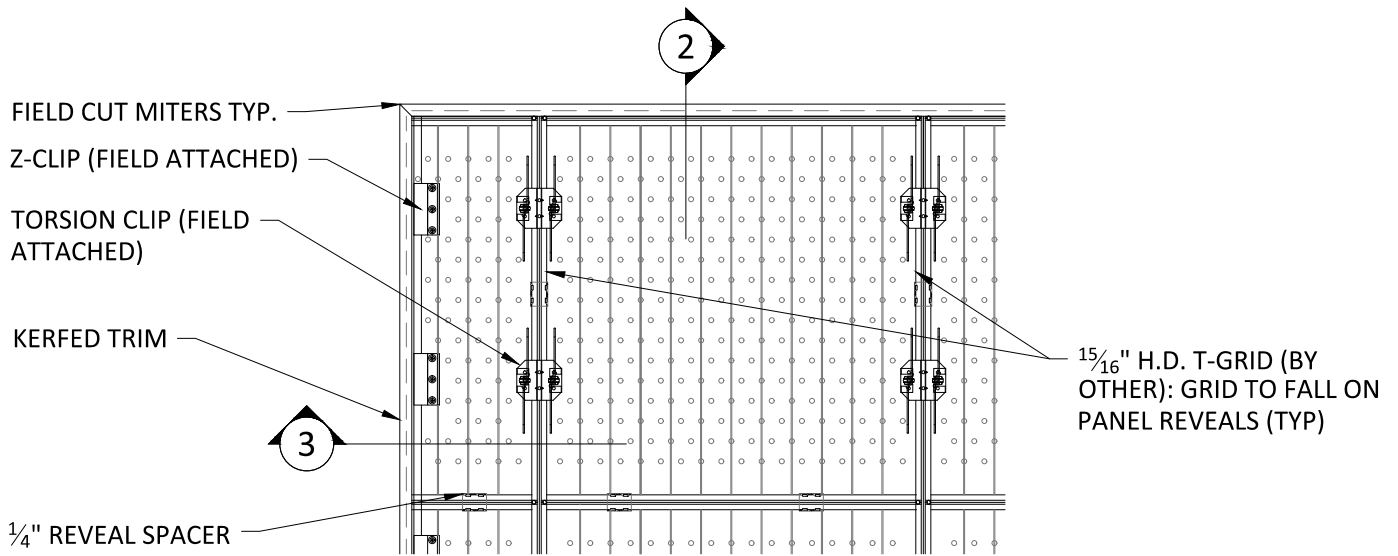


1 TRIM @ MITERED CORNER - PLAN
1" = 1'-0"

** ALL FIELD CUTS TO ALLOW FOR 1/4" MIN REVEAL FOR EXPANSION & CONTRACTION

* 1" ACOUSTICAL BACKER RECOMMENDED FOR USE WITH PERFORATED PANELS (2" AVAILABLE)

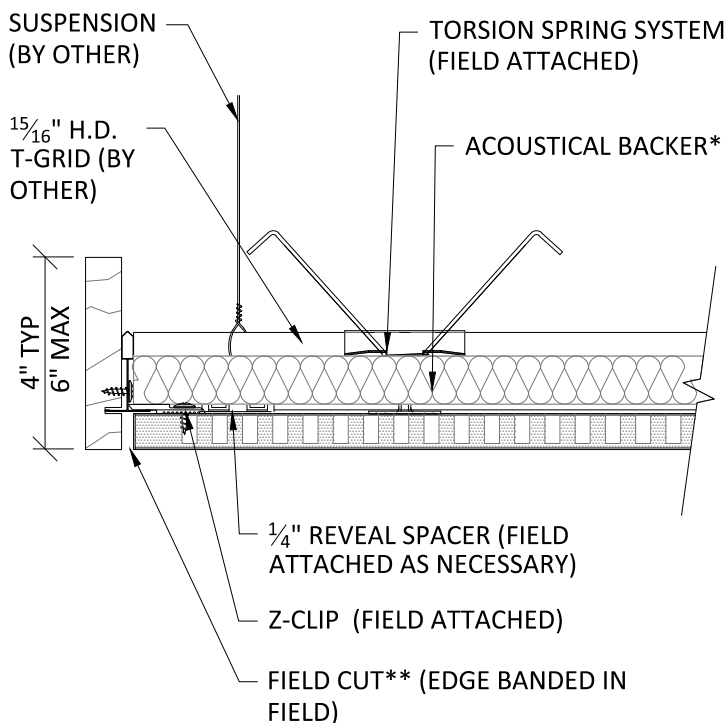


2 TRIM DETAIL 1
3" = 1'-0"

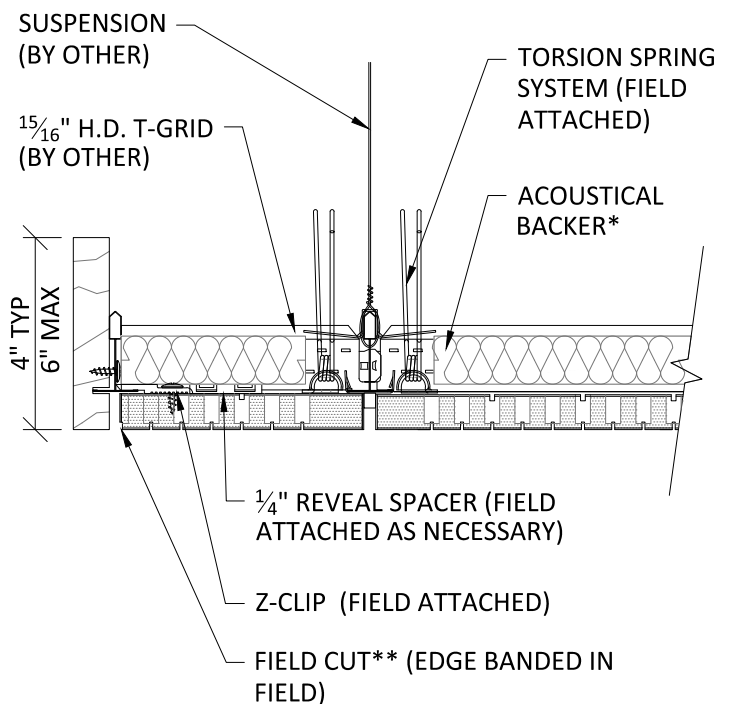


3 TRIM DETAIL 2
3" = 1'-0"

** ALL FIELD CUTS TO ALLOW FOR 1/4" MIN REVEAL FOR EXPANSION & CONTRACTION

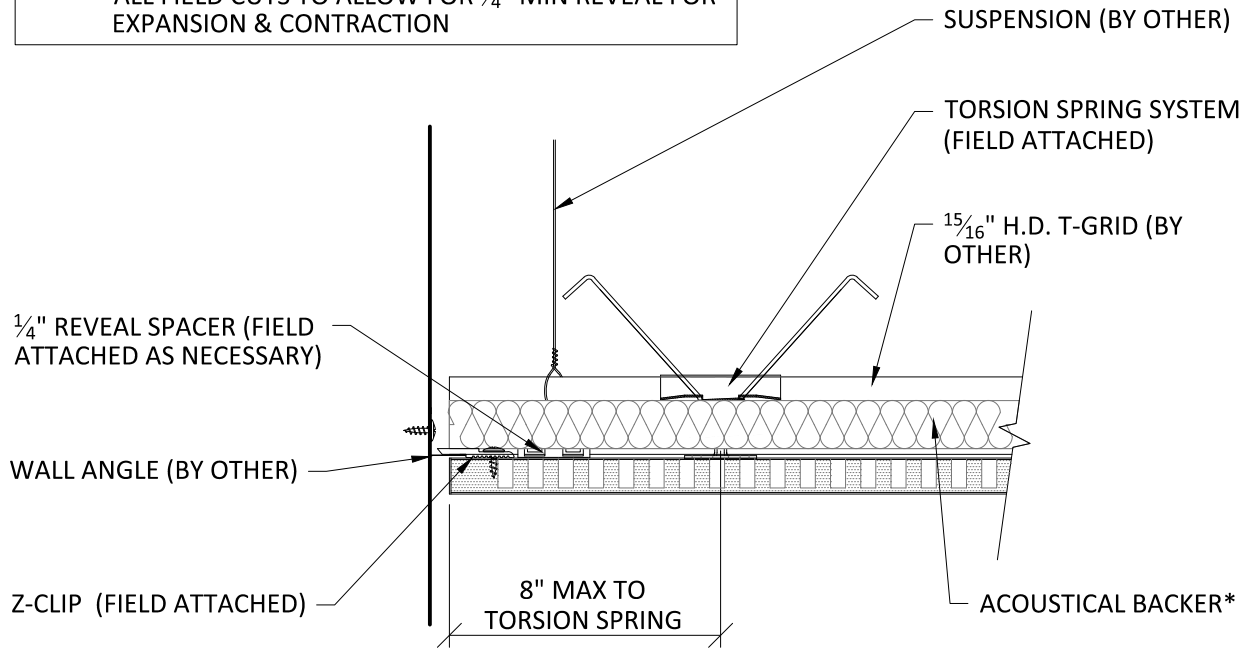

1 PERIMETER CONDITION AT WALL 3" = 1'-0"

* 1" ACOUSTICAL BACKER RECOMMENDED FOR USE WITH PERFORATED PANELS (2" AVAILABLE)

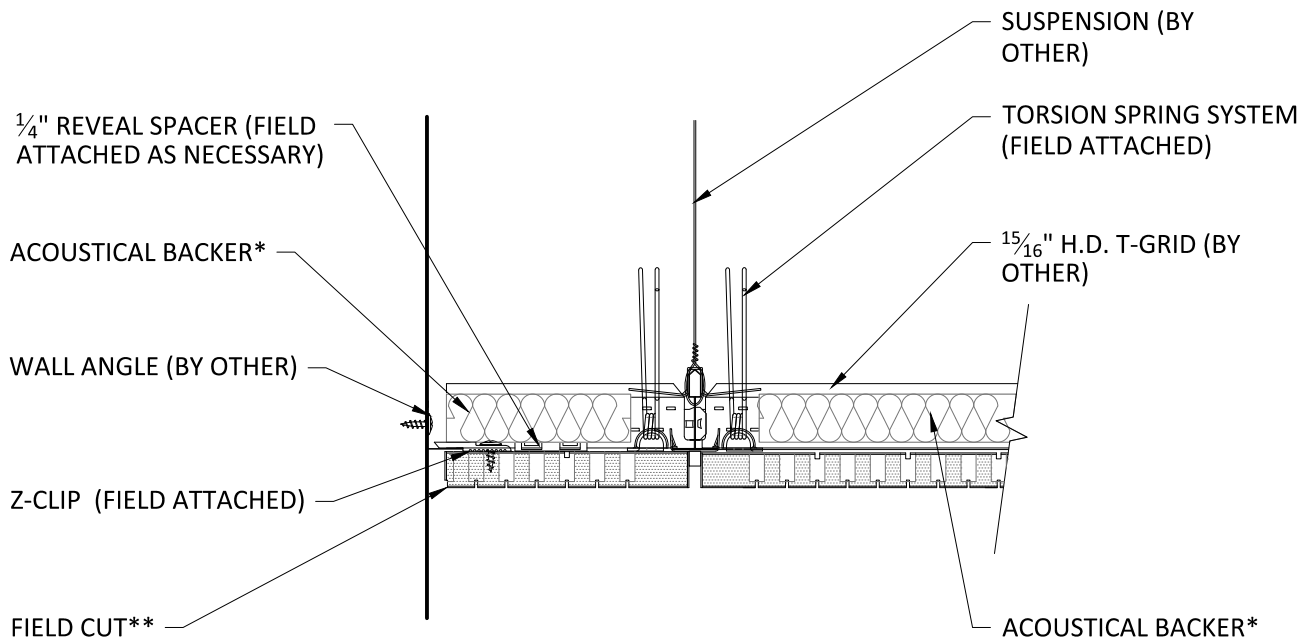


2 PERIMETER CONDITION AT WALL 3" = 1'-0"

1 $\frac{5}{16}$ " H.D. T-GRID (BY OTHER): GRID TO FALL ON PANEL REVEALS (TYP)

INDEPENDENTLY SUPPORTED
CUSTOMER FIXTURE (BY OTHER):
FIELD CUT PENETRATION

1/4" REVEAL SPACER (FIELD
ATTACHED AS NECESSARY)

TORSION SPRING SYSTEM (FIELD
ATTACHED TO T-GRID MAINS ONLY:
24" OC MAX)

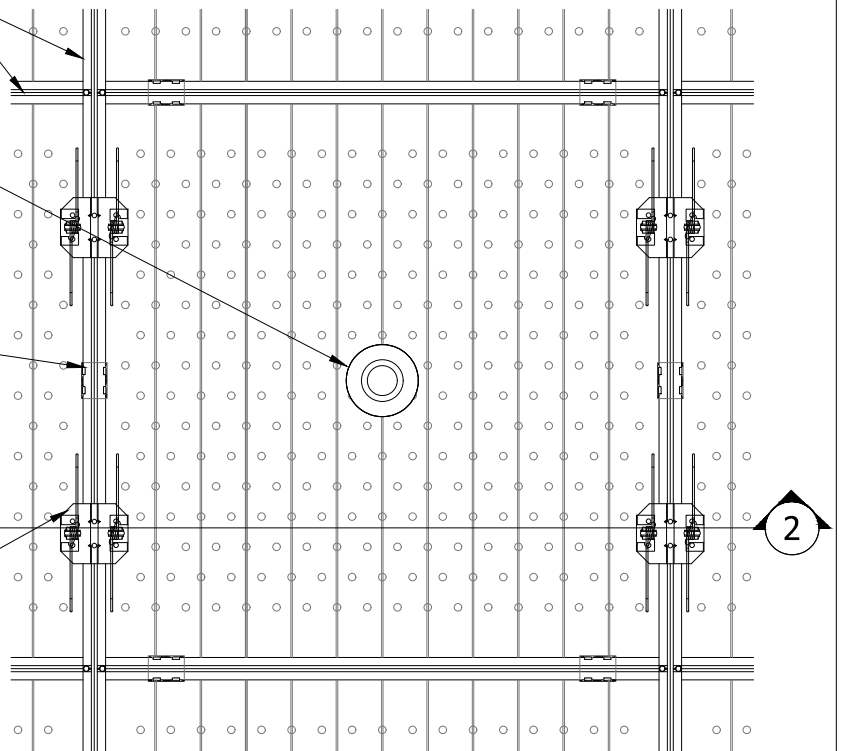

2

1

SPRINKLER PLAN


1 1/2" = 1'-0"

1 $\frac{5}{16}$ " H.D. T-GRID (BY OTHER): GRID TO
FALL ON PANEL REVEALS (TYP)

INDEPENDENTLY SUPPORTED
CUSTOMER FIXTURE (BY OTHER):
FIELD CUT PENETRATION

TORSION SPRING SYSTEM (FIELD
ATTACHED TO T-GRID MAINS ONLY:
24" OC MAX)

1/4" REVEAL SPACER (FIELD
ATTACHED AS NECESSARY)

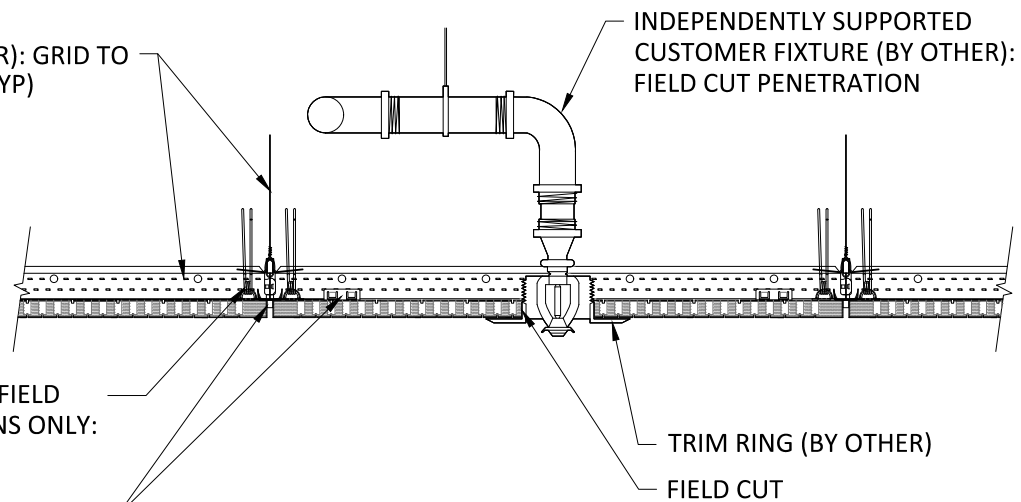

TRIM RING (BY OTHER)

FIELD CUT

2

SPRINKLER SECTION

1 1/2" = 1'-0"

AUDITION PANEL (TORSION SPRING SYSTEM) - SPRINKLER HEAD DETAIL

SCALE: AS NOTED

LAST REVISED: 3/23/2022

SHEET NUMBER

8


DRAWN BY: BH

15/16" H.D. T-GRID (BY OTHER): GRID TO FALL ON PANEL REVEALS (TYP)

INDEPENDENTLY SUPPORTED
CUSTOMER FIXTURE (BY OTHER):
FIELD CUT PENETRATION

1/4" REVEAL SPACER (FIELD
ATTACHED AS NECESSARY)

TORSION SPRING SYSTEM (FIELD
ATTACHED TO T-GRID MAINS ONLY:
24" OC MAX)

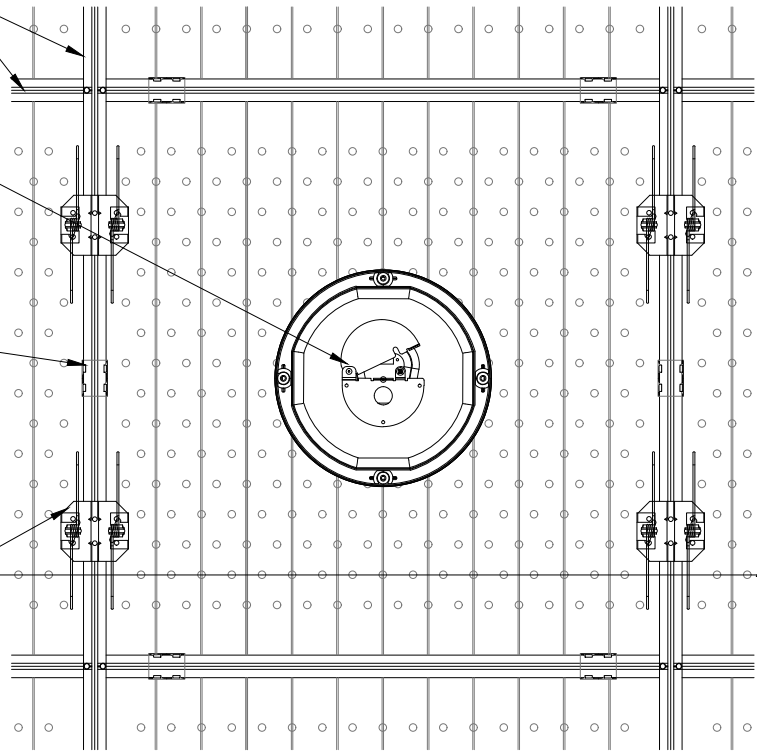

1 CAN LIGHT PLAN


1 1/2" = 1'-0"

15/16" H.D. T-GRID (BY OTHER): GRID TO
FALL ON PANEL REVEALS (TYP)

INDEPENDENTLY SUPPORTED
CUSTOMER FIXTURE (BY OTHER):
FIELD CUT PENETRATION

TORSION SPRING SYSTEM (FIELD
ATTACHED TO T-GRID MAINS ONLY:
24" OC MAX)

1/4" REVEAL SPACER (FIELD
ATTACHED AS NECESSARY)

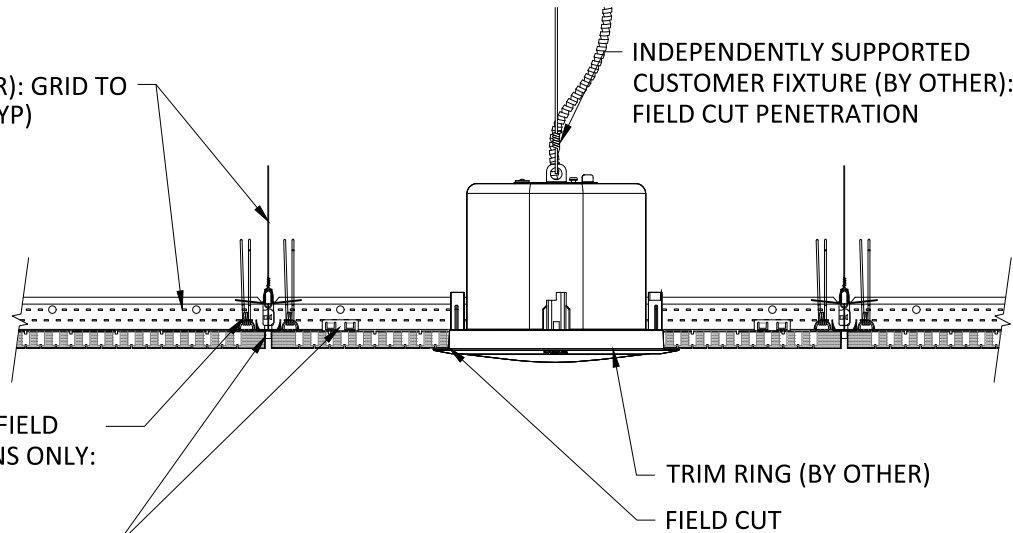

2 CAN LIGHT SECTION

1 1/2" = 1'-0"

AUDITION PANEL (TORSION SPRING SYSTEM) - CAN LIGHT DETAIL

SCALE: AS NOTED

LAST REVISED: 3/23/2022

SHEET NUMBER

9


DRAWN BY: BH

15/16" H.D. T-GRID (BY OTHER): GRID TO FALL ON PANEL REVEALS (TYP)

INDEPENDENTLY SUPPORTED
CUSTOMER FIXTURE (BY OTHER):
FIELD CUT PENETRATION

1/4" REVEAL SPACER (FIELD
ATTACHED AS NECESSARY)

TORSION SPRING SYSTEM (FIELD
ATTACHED TO T-GRID MAINS ONLY:
24" OC MAX)

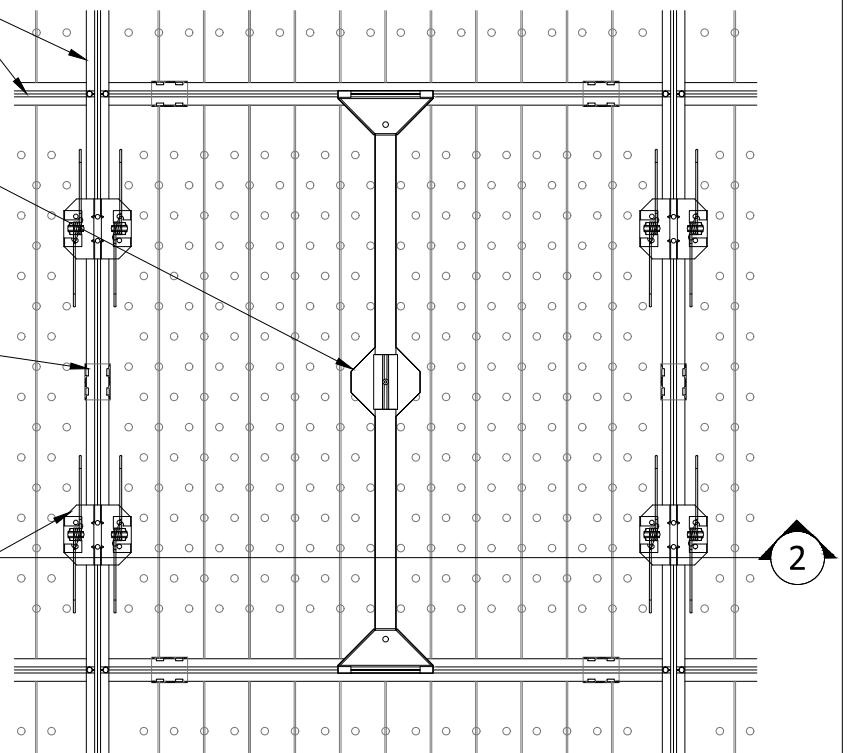

2

1

PENDANT LIGHT PLAN


1 1/2" = 1'-0"

15/16" H.D. T-GRID (BY OTHER): GRID TO
FALL ON PANEL REVEALS (TYP)

INDEPENDENTLY SUPPORTED
CUSTOMER FIXTURE (BY OTHER):
FIELD CUT PENETRATION

TORSION SPRING SYSTEM (FIELD
ATTACHED TO T-GRID MAINS ONLY:
24" OC MAX)

1/4" REVEAL SPACER (FIELD
ATTACHED AS NECESSARY)

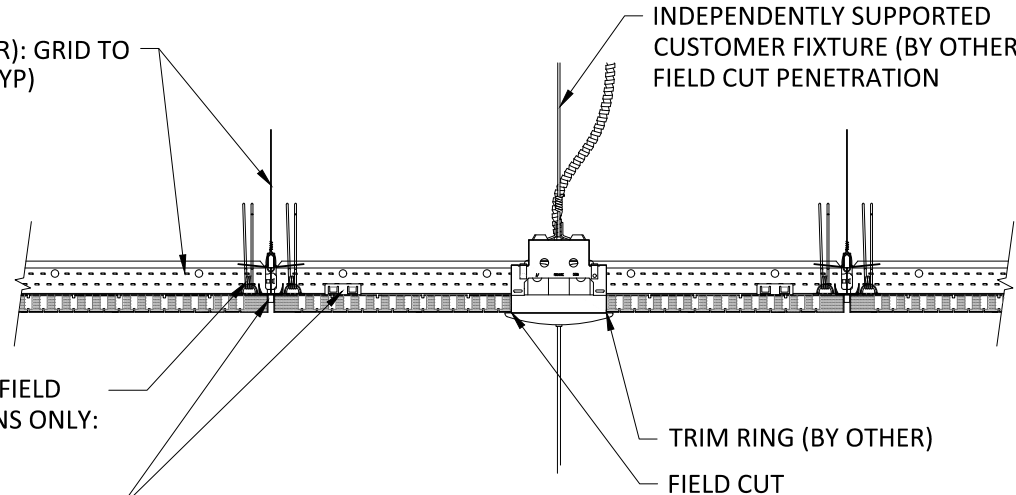

TRIM RING (BY OTHER)

FIELD CUT

2

PENDANT LIGHT SECTION

1 1/2" = 1'-0"

AUDITION PANEL (TORSION SPRING SYSTEM) - PENDANT LIGHT DETAIL

SCALE: AS NOTED

LAST REVISED: 3/23/2022

SHEET NUMBER

10


DRAWN BY: BH

15/16" H.D. T-GRID (BY OTHER): GRID TO FALL ON PANEL REVEALS (TYP)

INDEPENDENTLY SUPPORTED
CUSTOMER FIXTURE (BY OTHER):
FIELD CUT PENETRATION

1/4" REVEAL SPACER (FIELD
ATTACHED AS NECESSARY)

TORSION SPRING SYSTEM (FIELD
ATTACHED TO T-GRID MAINS ONLY:
24" OC MAX)

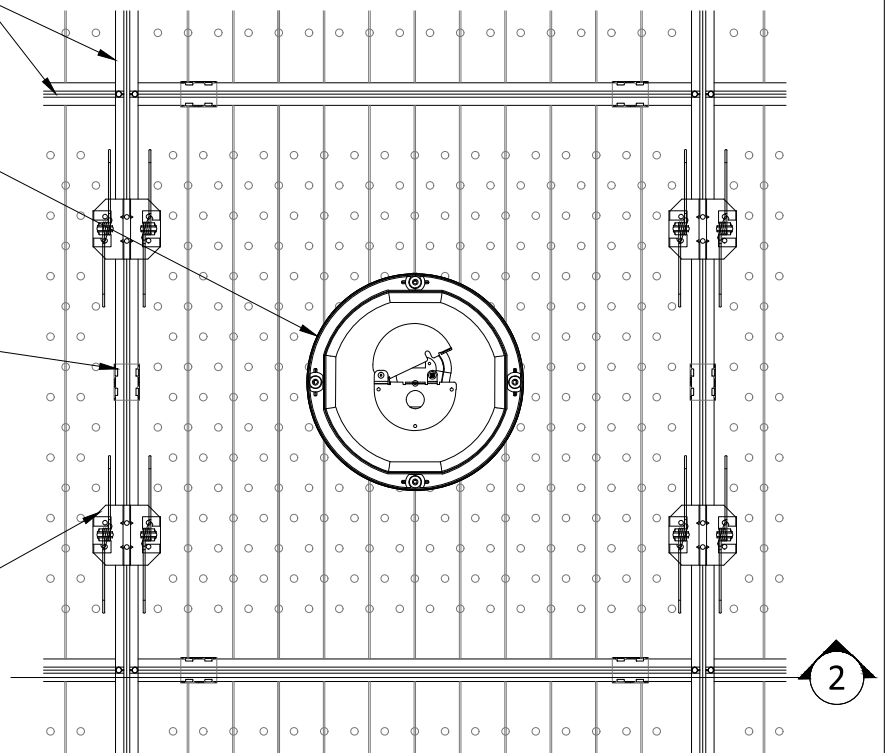

1

RECESSED SPEAKER PLAN


1 1/2" = 1'-0"

15/16" H.D. T-GRID (BY OTHER): GRID TO
FALL ON PANEL REVEALS (TYP)

INDEPENDENTLY SUPPORTED
CUSTOMER FIXTURE (BY OTHER):
FIELD CUT PENETRATION

TORSION SPRING SYSTEM (FIELD
ATTACHED TO T-GRID MAINS ONLY:
24" OC MAX)

1/4" REVEAL SPACER (FIELD
ATTACHED AS NECESSARY)

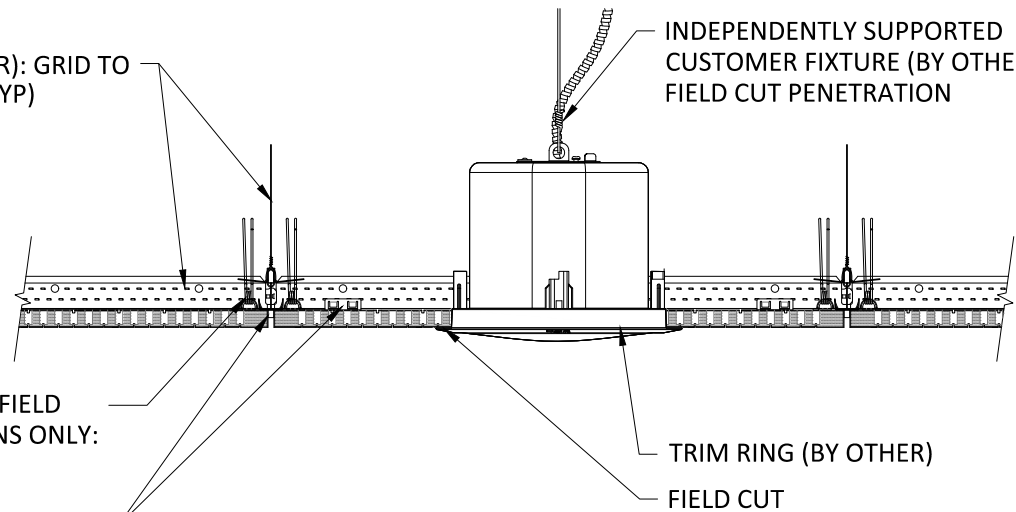

2

RECESSED SPEAKER SECTION

1 1/2" = 1'-0"

AUDITION PANEL (TORSION SPRING SYSTEM) - SPEAKER DETAIL

SCALE: AS NOTED

LAST REVISED: 3/23/2022

SHEET NUMBER

11


DRAWN BY: BH

15/16" H.D. T-GRID (BY OTHER): GRID TO FALL ON PANEL REVEALS (TYP)

INDEPENDENTLY SUPPORTED
CUSTOMER FIXTURE (BY OTHER):
FIELD CUT PENETRATION

1/4" REVEAL SPACER (FIELD
ATTACHED AS NECESSARY)

TORSION SPRING SYSTEM (FIELD
ATTACHED TO T-GRID MAINS ONLY:
24" OC MAX)

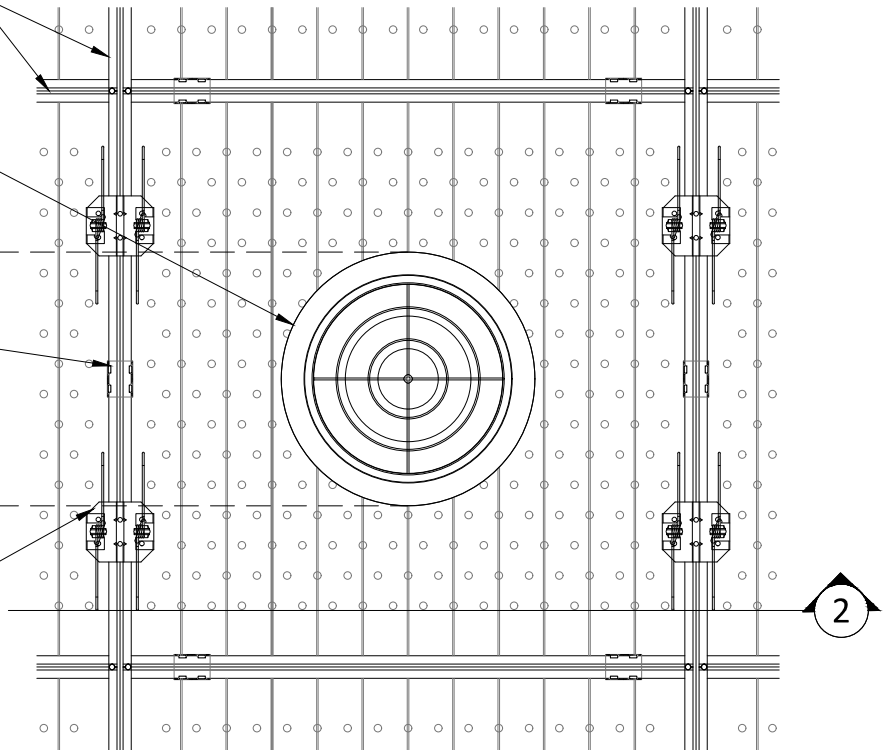


1 DIFFUSER PLAN
1 1/2" = 1'-0"

15/16" H.D. T-GRID (BY OTHER): GRID TO
FALL ON PANEL REVEALS (TYP)

INDEPENDENTLY SUPPORTED
CUSTOMER FIXTURE (BY OTHER):
FIELD CUT PENETRATION

TORSION SPRING SYSTEM (FIELD
ATTACHED TO T-GRID MAINS ONLY:
24" OC MAX)

1/4" REVEAL SPACER (FIELD
ATTACHED AS NECESSARY)

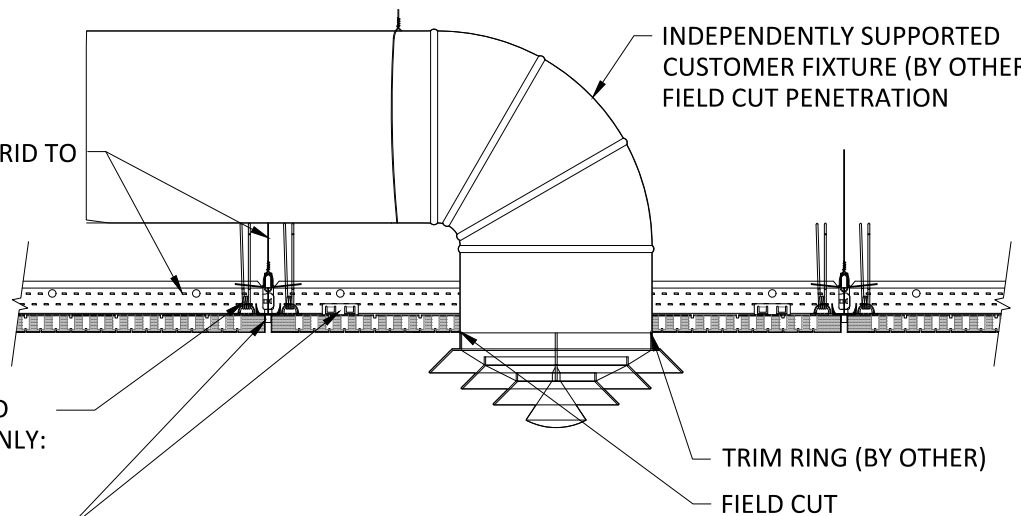

2 DIFFUSER SECTION
1 1/2" = 1'-0"