


1 GRILLE-BACKERED SECTION DETAIL


3" = 1'-0"

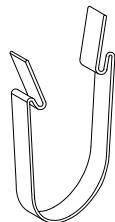

ISOMETRIC



ELEVATION

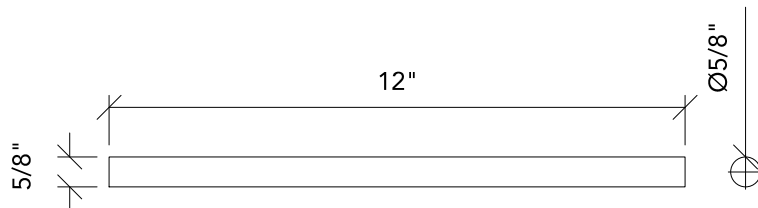


2 BACKER CLIP (FOR 15/16" H.D. T-GRID)


1' = 1'-0"

3 BACKER & DOWEL DETAILS


3" = 1'-0"

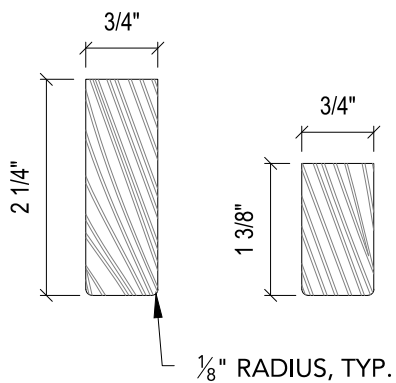

SOLID WOOD RAIL

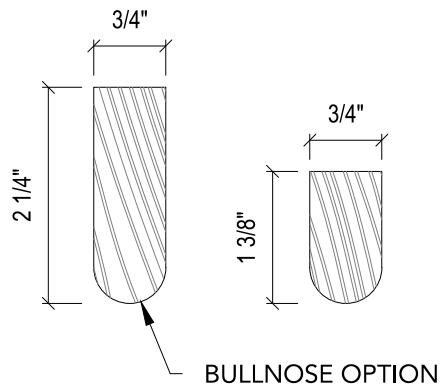

SOLID WOOD RAIL

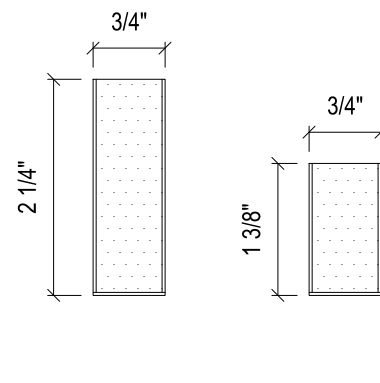


VENEERED RAIL

CUSTOM PROFILES
AVAILABLE UPON REQUEST

1 TYPICAL RAIL PROFILES


6" = 1'-0"

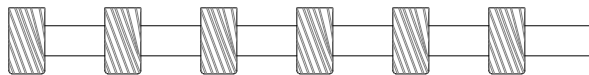


SOLID WOOD
6 RAIL/FT.
2" SPACING O.C.



VENEERED
6 RAIL/FT.
2" SPACING O.C.

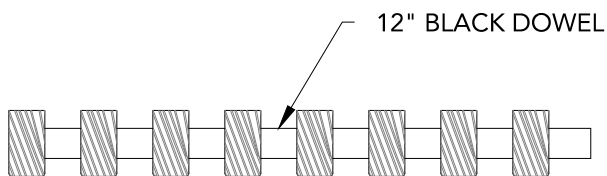

SOLID WOOD
8 RAIL/FT.
1 1/2" SPACING O.C.

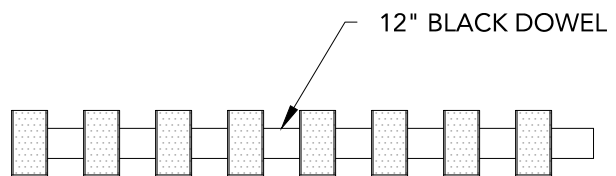

VENEERED
8 RAIL/FT.
1 1/2" SPACING O.C.

2 TYPICAL 12 INCH MODULES

3" = 1'-0"

GRILLE-DOWELLED SYSTEM - TYPICAL PROFILE OPTIONS


SHEET NUMBER

2

SCALE: AS NOTED

LAST REVISED: 4/27/2018

DRAWN BY: BMH

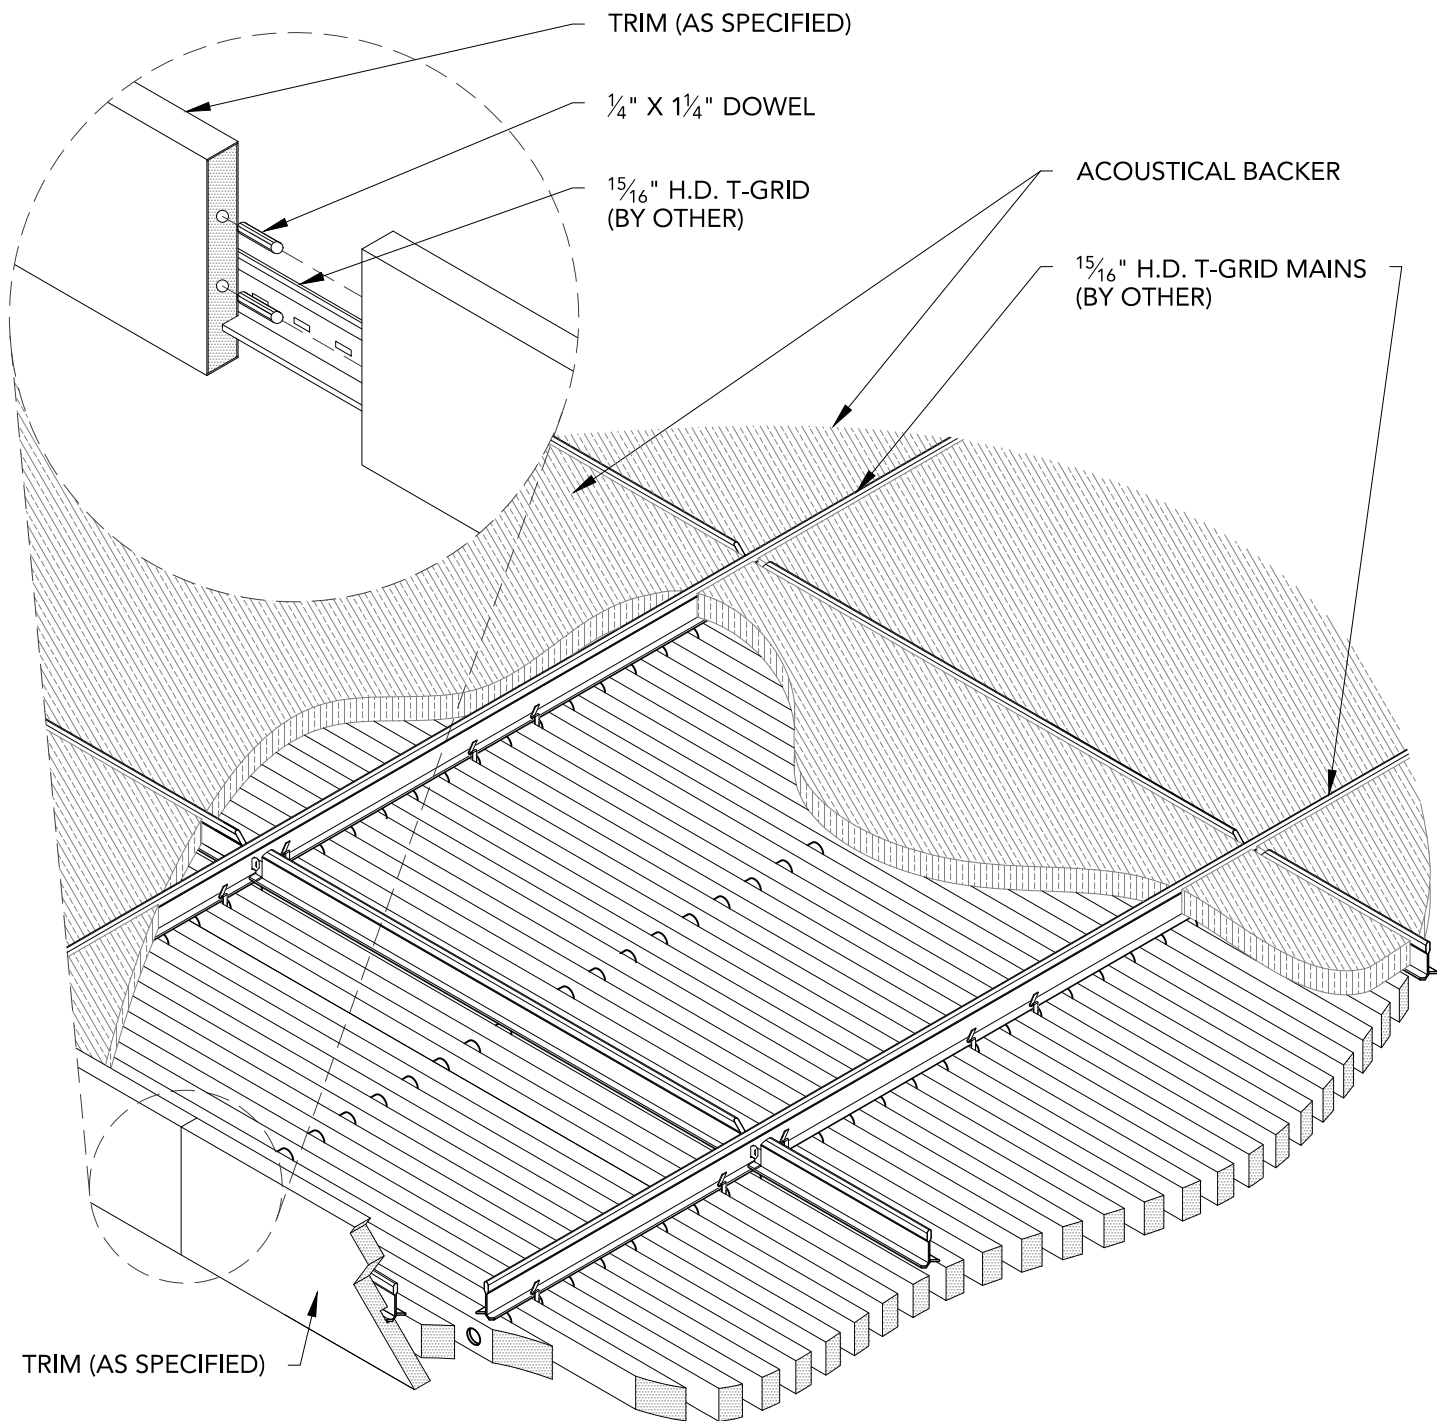

1 CEILING ISOMETRIC - TYP.
1 1/2" = 1'-0"

FIELD CUT
MITERS TYP.

KERFED TRIM

BLACK DOWEL

DOWEL CLIP

$\frac{15}{16}$ " H.D. T-GRID
MAINS (BY OTHER)

2



3

1

CLOUD VERTICAL TRIM PLAN

1 1/2" = 1'-0"

** ALL FIELD CUTS TO ALLOW FOR $\frac{1}{4}$ " MIN
REVEAL FOR EXPANSION & CONTRACTION

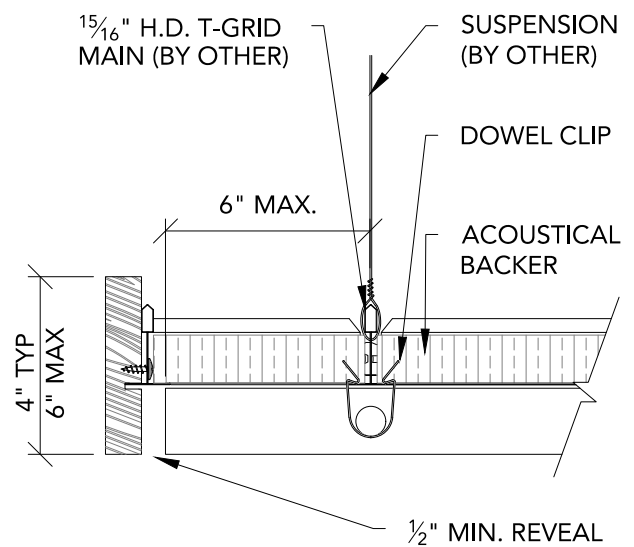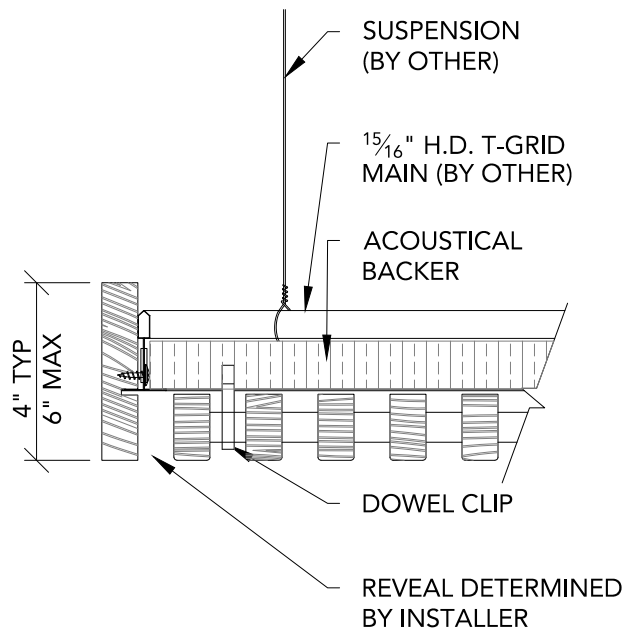

2

TRIM @ EDGE - FRONT SECTION


3" = 1'-0"

3


TRIM @ EDGE - SIDE SECTION

3" = 1'-0"


** ALL FIELD CUTS TO ALLOW FOR $\frac{1}{4}$ " MIN
REVEAL FOR EXPANSION & CONTRACTION

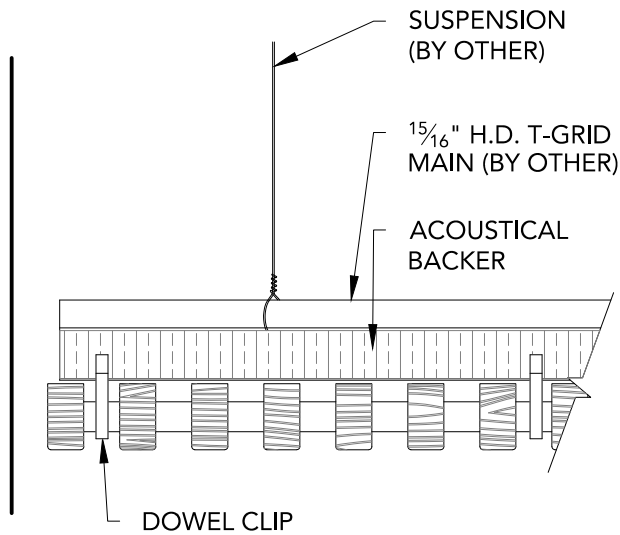


1 FLOATING @ WALL - FRONT SECTION
3" = 1'-0"

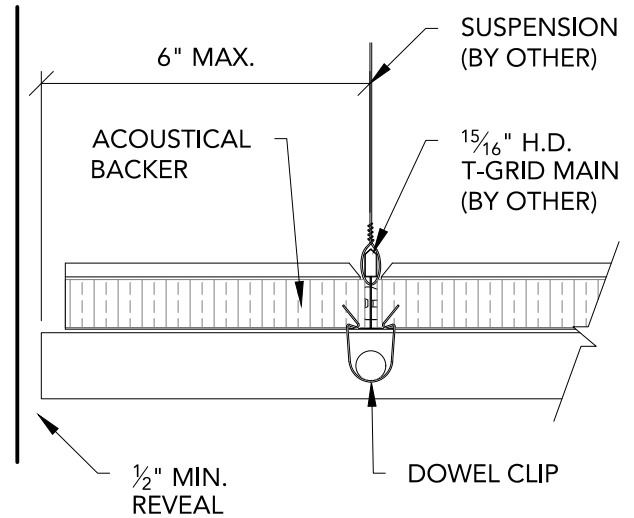

2 FLOATING @ WALL - SIDE SECTION
3" = 1'-0"

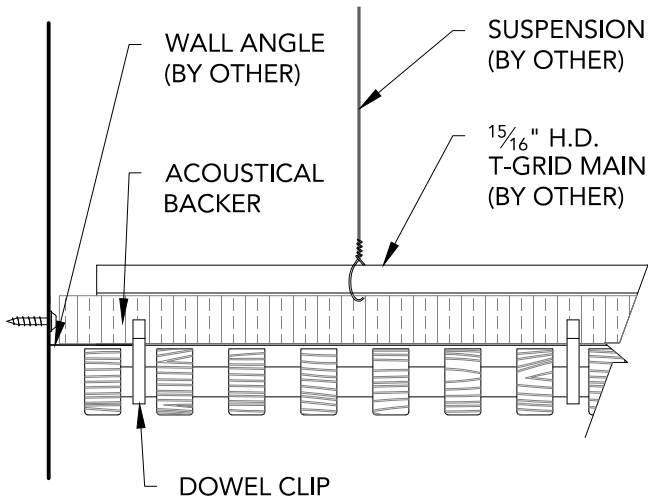

3 WALL ANGLE - FRONT SECTION
3" = 1'-0"

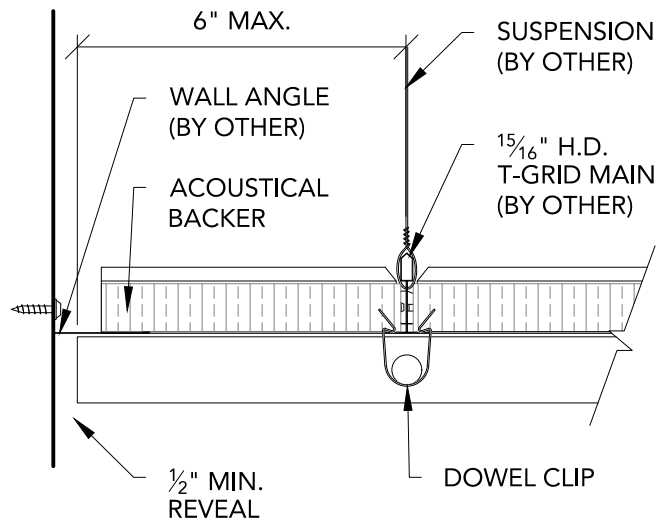


4 WALL ANGLE - SIDE SECTION
3" = 1'-0"

15/16" H.D. T-GRID
MAINS (BY OTHER)

INDEPENDENTLY
SUPPORTED SPRINKLER
(FIELD CUT PENETRATION)

BLACK DOWEL

DOWEL CLIP

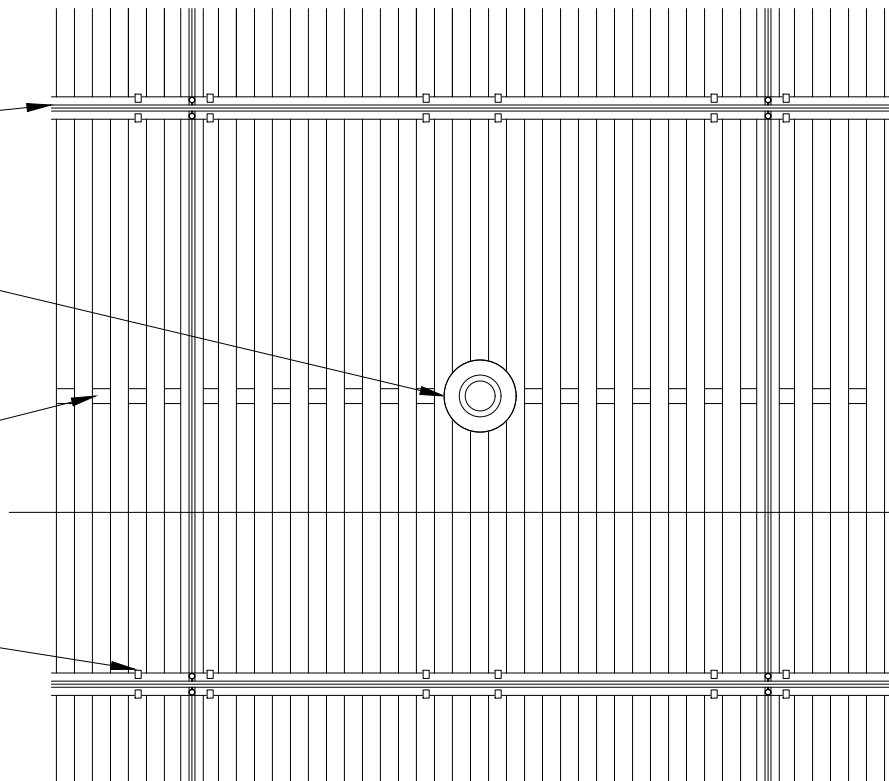

2

1

SPRINKLER HEAD DETAIL - PLAN VIEW

1 1/2" = 1'-0"

SUSPENSION (BY OTHER)


15/16" H.D. T-GRID (BY OTHER)

DOWEL CLIP

FIELD CUT
PENETRATION

INDEPENDENTLY
SUPPORTED SPRINKLER
(BY OTHER)

TRIM RING (BY OTHER)

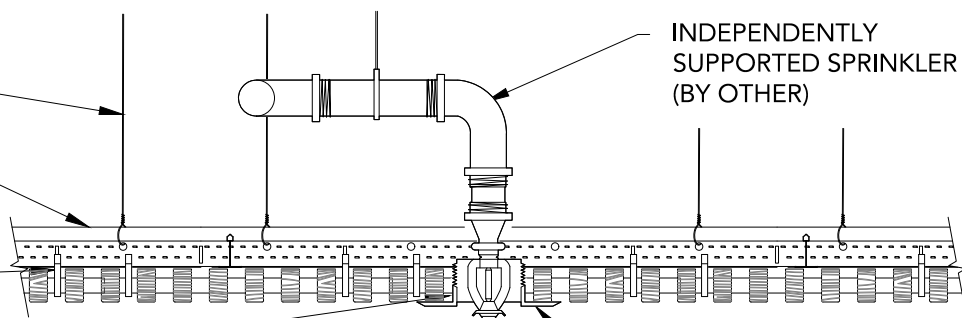

2

SPRINKLER HEAD DETAIL - SECTION VIEW

1 1/2" = 1'-0"

GRILLE-DOWELLED (CEILING SYSTEM) - SPRINKLER HEAD DETAILS

SHEET NUMBER

6

SCALE: AS NOTED

LAST REVISED: 4/27/2018


DRAWN BY: BMH

15¹/₁₆" H.D. T-GRID
MAINS (BY OTHER)

INDEPENDENTLY
SUPPORTED CAN LIGHT
(FIELD CUT PENETRATION)

BLACK DOWEL

DOWEL CLIP

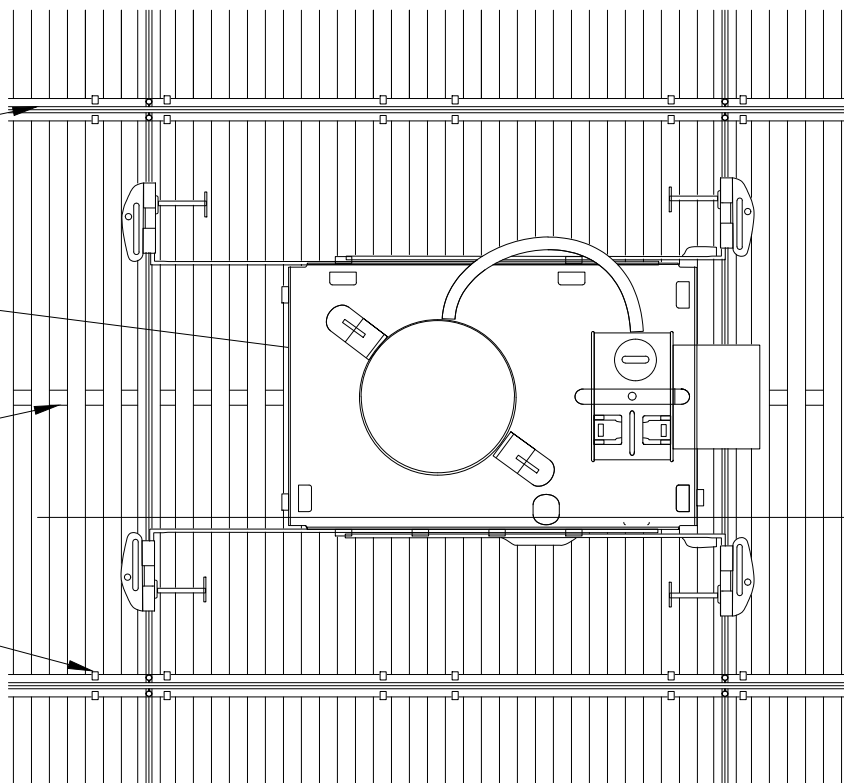

2

1 CAN LIGHT DETAIL - PLAN VIEW


1 1/2" = 1'-0"

SUSPENSION (BY OTHER)

15¹/₁₆" H.D. T-GRID (BY OTHER)

DOWEL CLIP

FIELD CUT
PENETRATION

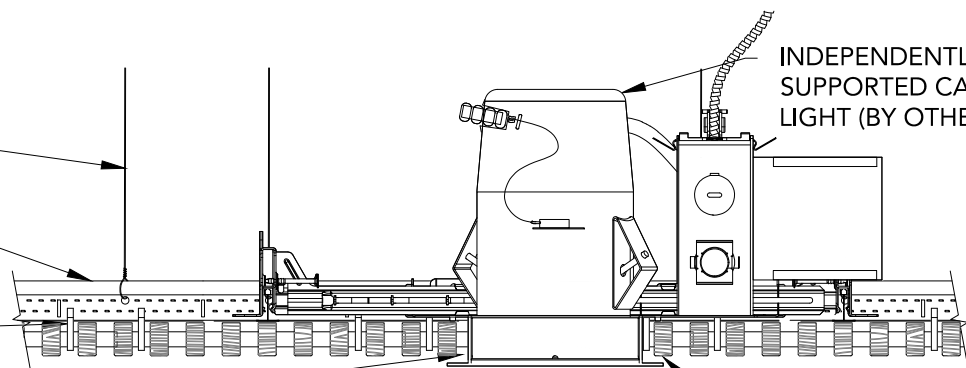

INDEPENDENTLY
SUPPORTED CAN LIGHT (BY OTHER)

TRIM RING
(BY OTHER)

2 CAN LIGHT DETAIL - SECTION VIEW

1 1/2" = 1'-0"

GRILLE-DOWELLED (CEILING SYSTEM) - CAN LIGHT DETAILS


SHEET NUMBER

7


SCALE: AS NOTED

LAST REVISED: 4/27/2018

DRAWN BY: BMH

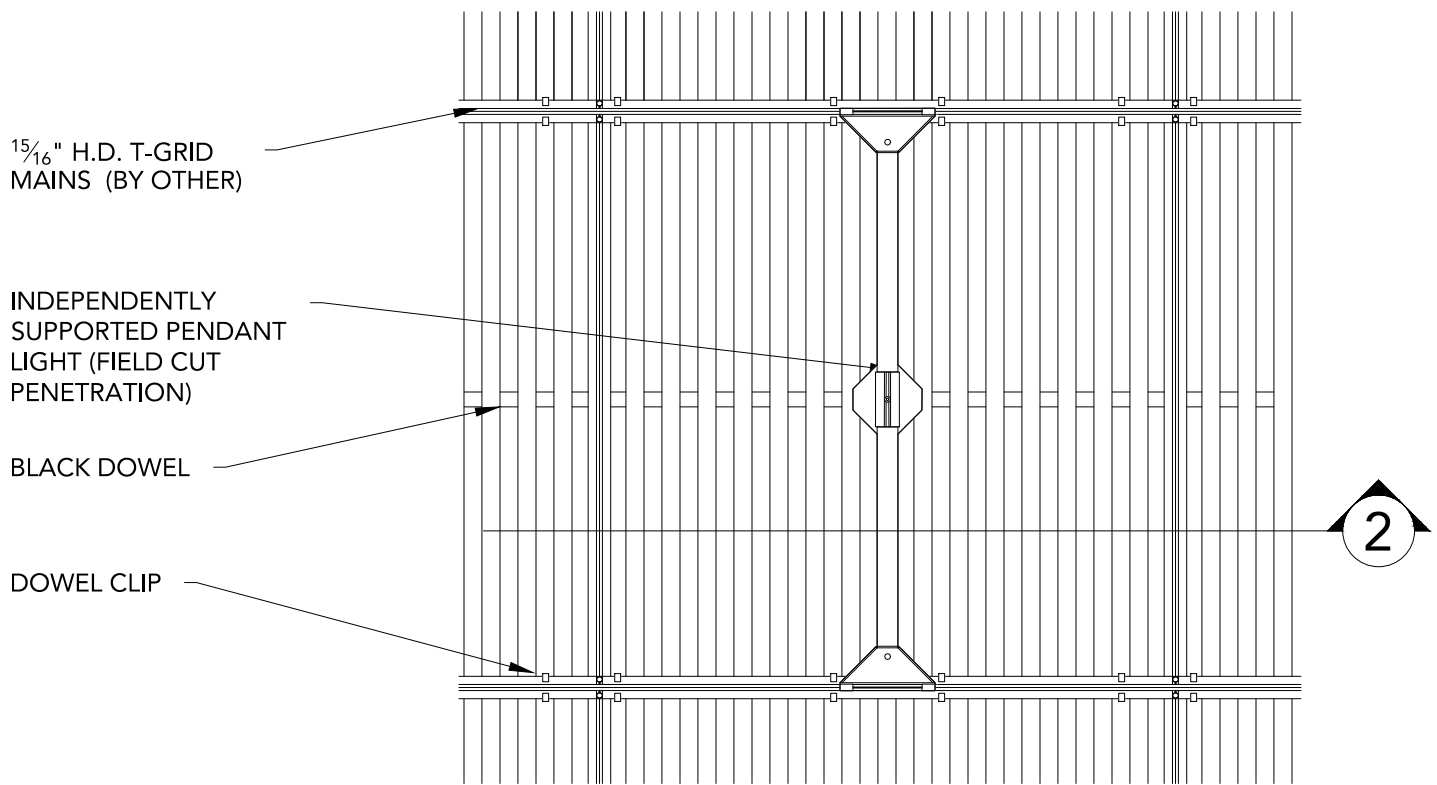

1 PENDANT LIGHT DETAIL - PLAN VIEW
1 1/2" = 1'-0"

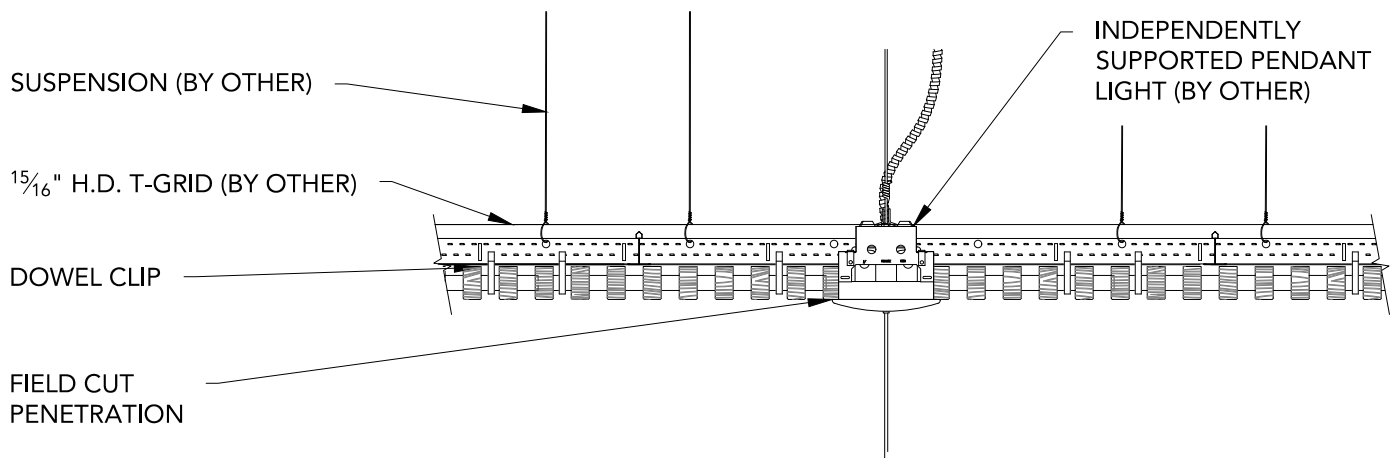

2 PENDANT LIGHT DETAIL - SECTION VIEW
1 1/2" = 1'-0"

15/16" H.D. T-GRID
MAINS (BY OTHER)

INDEPENDENTLY
SUPPORTED SPEAKER
(FIELD CUT PENETRATION)

BLACK DOWEL

DOWEL CLIP

2

1

RECESSED SPEAKER DETAIL - PLAN VIEW

1 1/2" = 1'-0"

SUSPENSION (BY OTHER)

15/16" H.D. T-GRID (BY OTHER)

DOWEL CLIP

FIELD CUT
PENETRATION

INDEPENDENTLY
SUPPORTED
SPEAKER (BY OTHER)

TRIM RING
(BY OTHER)

2

RECESSED SPEAKER DETAIL - SECTION VIEW

1 1/2" = 1'-0"

GRILLE-DOWELLED (CEILING SYSTEM) - RECESSED SPEAKER DETAILS

SHEET NUMBER

9

SCALE: AS NOTED


LAST REVISED: 4/27/2018

DRAWN BY: BMH

15/16" H.D. T-GRID
MAINS (BY OTHER)

INDEPENDENTLY
SUPPORTED DIFFUSER
(FIELD CUT PENETRATION)

DOWEL CLIP

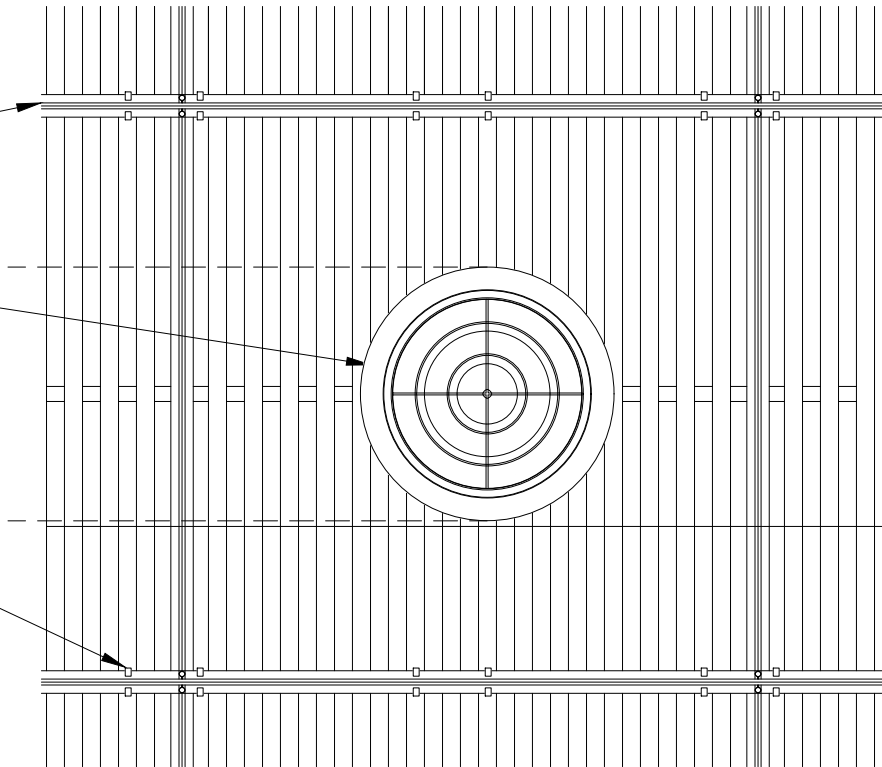

2

1

DIFFUSER DETAIL - PLAN VIEW


1 1/2" = 1'-0"

SUSPENSION (BY OTHER)

15/16" H.D. T-GRID (BY OTHER)

DOWEL CLIP

FIELD CUT
PENETRATION

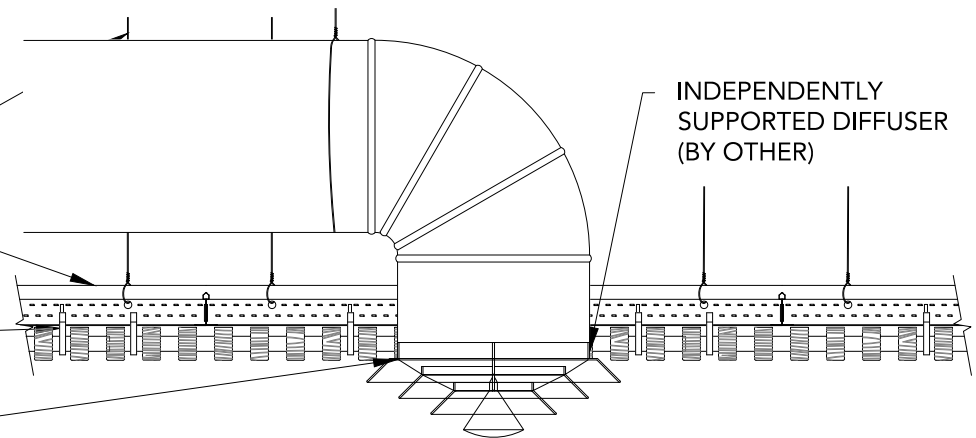

INDEPENDENTLY
SUPPORTED DIFFUSER
(BY OTHER)

2

DIFFUSER DETAIL - SECTION VIEW

1 1/2" = 1'-0"

GRILLE-DOWELLED (CEILING SYSTEM) - DIFFUSER DETAILS

SHEET NUMBER

10

SCALE: AS NOTED

LAST REVISED: 4/27/2018

DRAWN BY: BMH

INDEPENDENTLY SUPPORTED
LINEAR LIGHT: FIELD CUT
PENETRATION

$1\frac{5}{16}$ " H.D. T-GRID
MAINS (BY OTHER)

BLACK DOWEL

DOWEL CLIP

2

1

LINEAR LIGHT DETAIL - PLAN VIEW

1" = 1'-0"

SUSPENSION
(BY OTHER)

$1\frac{5}{16}$ " H.D.
T-GRID (BY
OTHER)

DOWEL CLIP

FIELD CUT PENETRATION

INDEPENDENTLY SUPPORTED
LINEAR LIGHT: FIELD CUT
PENETRATION

2

LINEAR LIGHT DETAIL - SECTION VIEW

1 1/2" = 1'-0"

ACOUSTICAL BACKER

TYP. WALL
ASSEMBLY (BY
OTHER)

FURRING (BY OTHER)
TO MATCH
ACOUSTICAL BACKER
THICKNESS: PAINTED
BLACK IN FIELD

BLACK DOWEL

2" SCREW (BY
OTHER) TYP.

1/2" REVEAL FOR
EXPANSION &
CONTRACTION

16 GA. FINISH NAIL
(BY OTHER)

TRIM (OPTIONAL) TO
COINCIDE W/
FURRING THICKNESS;
FACE NAILED &
PUTTIED IN FIELD

NOTE: 24" MAXIMUM SCREW/SUPPORT SPACING

1

HORIZONTAL WALL ISOMETRIC - TYP.

1 1/2" = 1'-0"

TYP. WALL
ASSEMBLY (BY
OTHER)

1" ACOUSTICAL BACKER IN
BETWEEN FURRING (2" AVAILABLE)

$\frac{3}{4}$ " TRIM FASTENED W/
FINISH NAIL AND PUTTIED
IN FIELD BY OTHER

$\frac{1}{2}$ " MIN. REVEAL

FURRING (BY OTHER) TO MATCH
ACOUSTICAL BACKER THICKNESS:
PAINTED BLACK IN FIELD

2

1

HORIZONTAL WALL PLAN @ TRIM

3" = 1'-0"

BLACK DOWEL
ATTACHED TO
FURRING

$\frac{1}{2}$ " MIN. REVEAL

$\frac{3}{4}$ " TRIM FASTENED W/
FINISH NAIL AND PUTTIED
IN FIELD BY OTHER

GRILLE RAIL

2

HORIZONTAL WALL ELEVATION @ TRIM

3" = 1'-0"

BLACK DOWEL ATTACHED TO FURRING

GRILLE RAIL

FURRING (BY OTHER) TO
MATCH ACOUSTICAL
BACKER THICKNESS:
PAINTED BLACK IN FIELD

BASE AS SCHEDULED (BY OTHER)

2

1

HORIZONTAL WALL ELEVATION @ BASEBOARD

3" = 1'-0"

TYP. WALL ASSEMBLY (BY OTHER)

FURRING (BY OTHER) TO MATCH
ACOUSTICAL BACKER
THICKNESS: PAINTED BLACK IN
FIELD

1" ACOUSTICAL BACKER IN BETWEEN
FURRING (2" AVAILABLE)

BASE AS SCHEDULED (BY OTHER)

2

HORIZONTAL WALL SECTION @ BASEBOARD


3" = 1'-0"

FURRING (BY OTHER) TO MATCH
ACOUSTICAL BACKER
THICKNESS: PAINTED BLACK IN
FIELD

OUTLET PENETRATION FIELD CUT

GRILLE RAIL

BLACK DOWEL ATTACHED TO FURRING

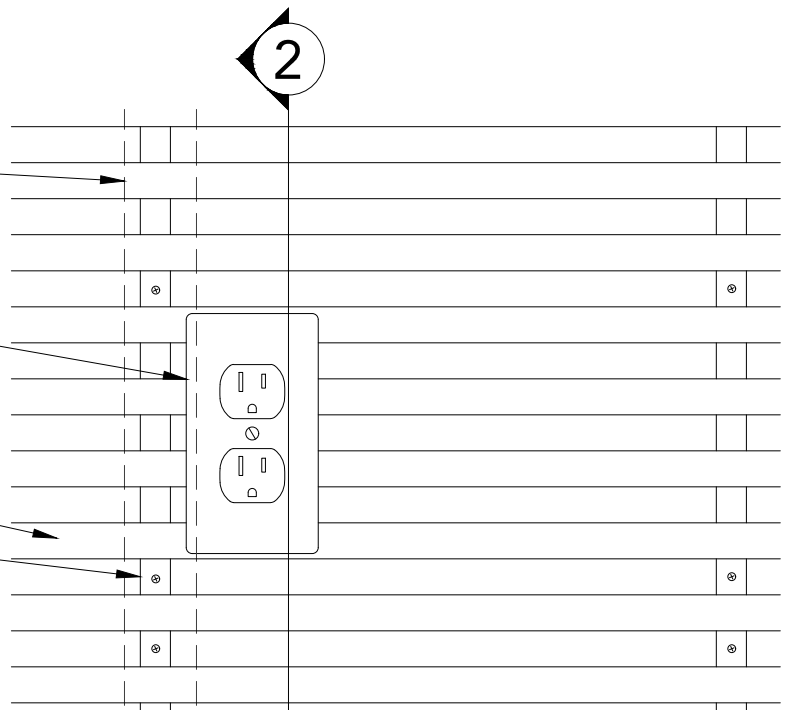

1 HORIZONTAL WALL ELEVATION @ OUTLET

3" = 1'-0"


GRILLE RAIL

1" ACOUSTICAL BACKER (2" AVAILABLE)

LIGHT SWITCH PENETRATION FIELD CUT

TYP. WALL SYSTEM (BY OTHER)

BLACK DOWEL ATTACHED TO FURRING

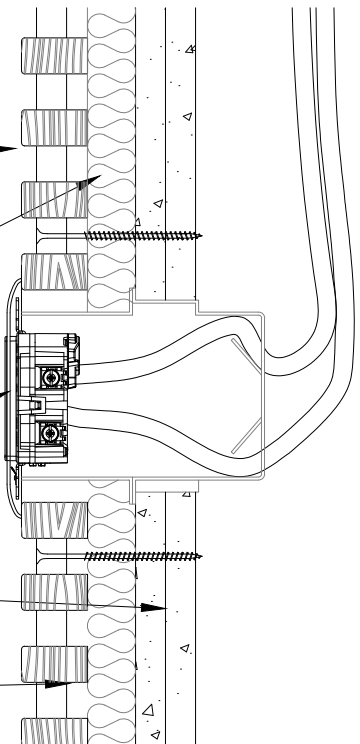

2 HORIZONTAL WALL SECTION @ OUTLET

3" = 1'-0"

GRILLE-DOWELLED (HORIZONTAL WALL SYSTEM) - OUTLET DETAILS

SCALE: AS NOTED

LAST REVISED: 4/27/2018

SHEET NUMBER

15


DRAWN BY: BMH

FURRING (BY OTHER) TO MATCH
ACOUSTICAL BACKER THICKNESS:
PAINTED BLACK IN FIELD

LIGHT SWITCH PENETRATION FIELD CUT

GRILLE RAIL

BLACK DOWEL ATTACHED TO FURRING

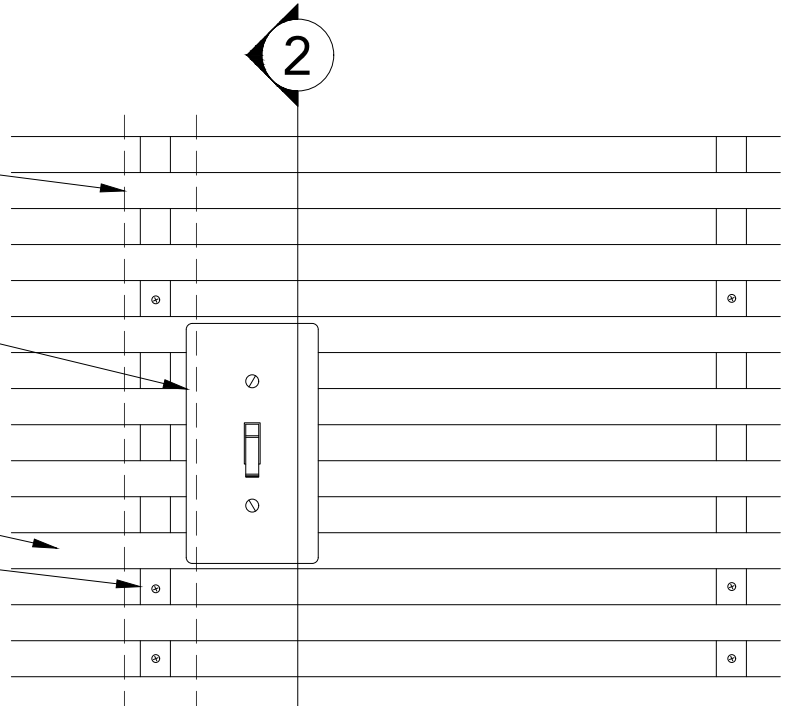

1 HORIZONTAL WALL ELEVATION @ LIGHT SWITCH

3" = 1'-0"


GRILLE RAIL

1" ACOUSTICAL BACKER
(2" AVAILABLE)

LIGHT SWITCH PENETRATION FIELD CUT

TYP. WALL SYSTEM (BY OTHER)

BLACK DOWEL ATTACHED TO FURRING

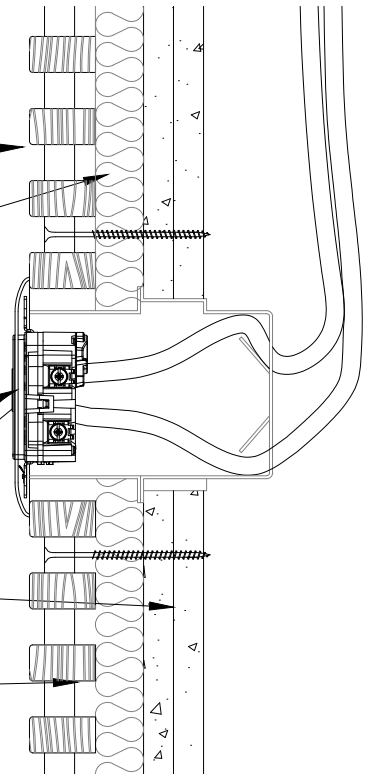

2 HORIZONTAL WALL SECTION @ LIGHT SWITCH

3" = 1'-0"

BLACK DOWEL

TYP. WALL
ASSEMBLY (BY
OTHER)


FURRING (BY OTHER)
TO MATCH
ACOUSTICAL BACKER
THICKNESS: PAINTED
BLACK IN FIELD

2" SCREW (BY
OTHER) TYP.

ACOUSTICAL BACKER

16 GA. FINISH NAIL
(BY OTHER)


TRIM (OPTIONAL) TO
COINCIDE W/
FURRING THICKNESS;
FACE NAILED &
PUTTIED IN FIELD

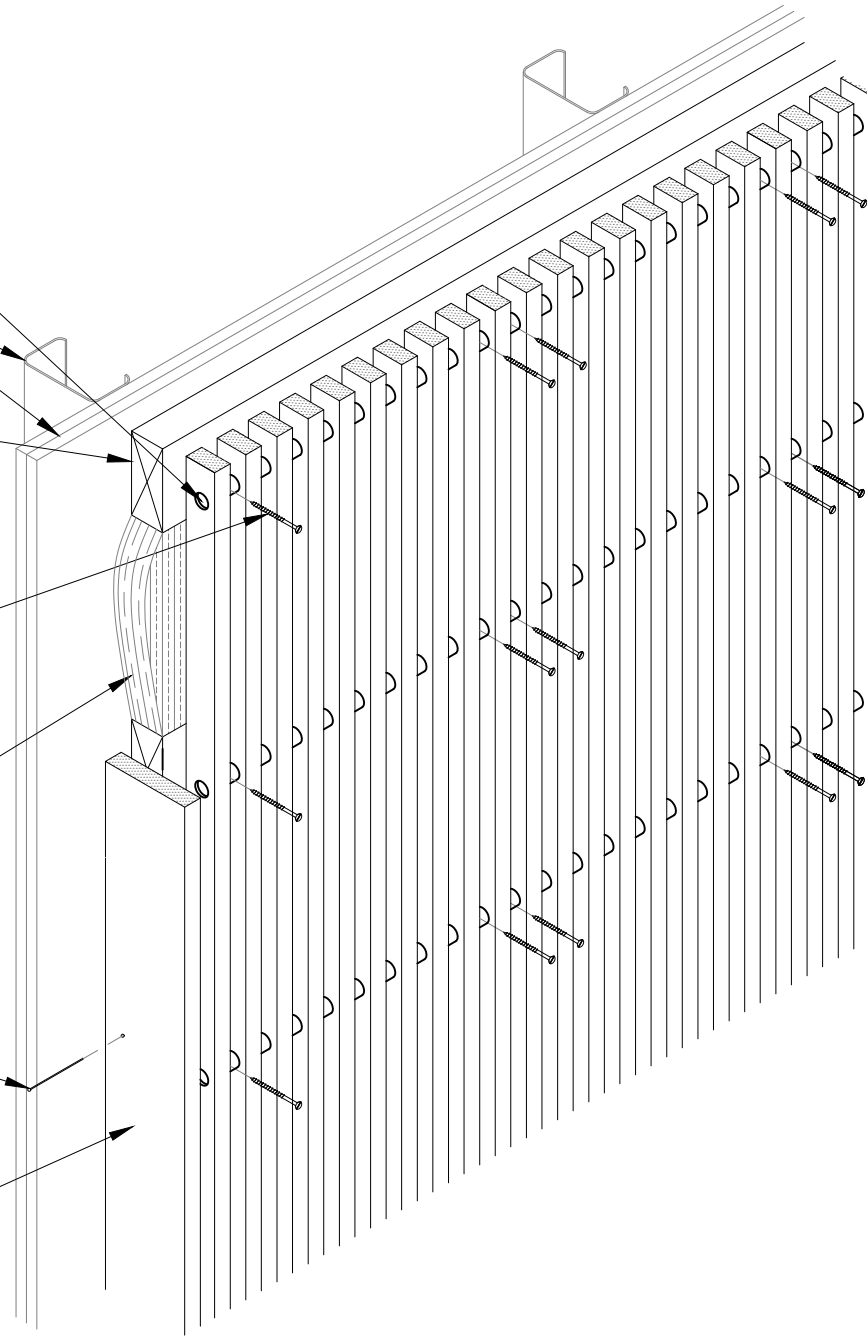

1


VERTICAL WALL ISOMETRIC - TYP.

1 1/2" = 1'-0"

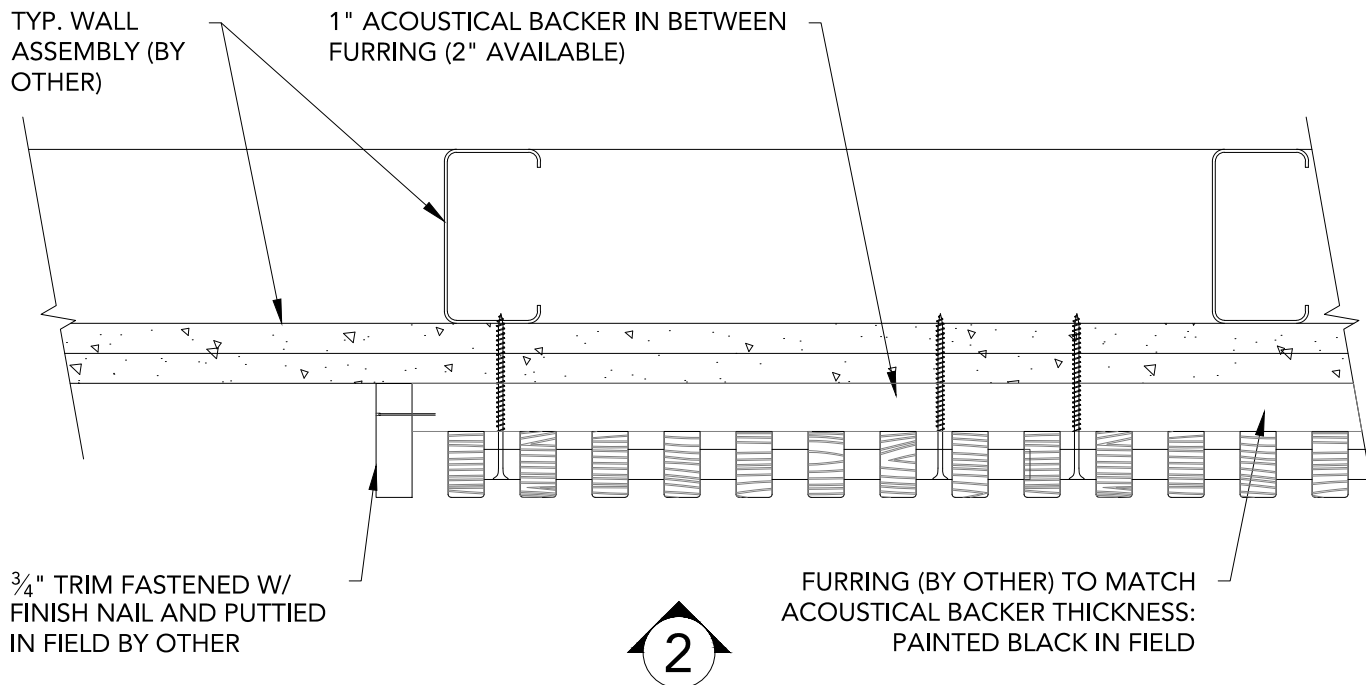

1 VERTICAL WALL PLAN @ TRIM

3" = 1'-0"

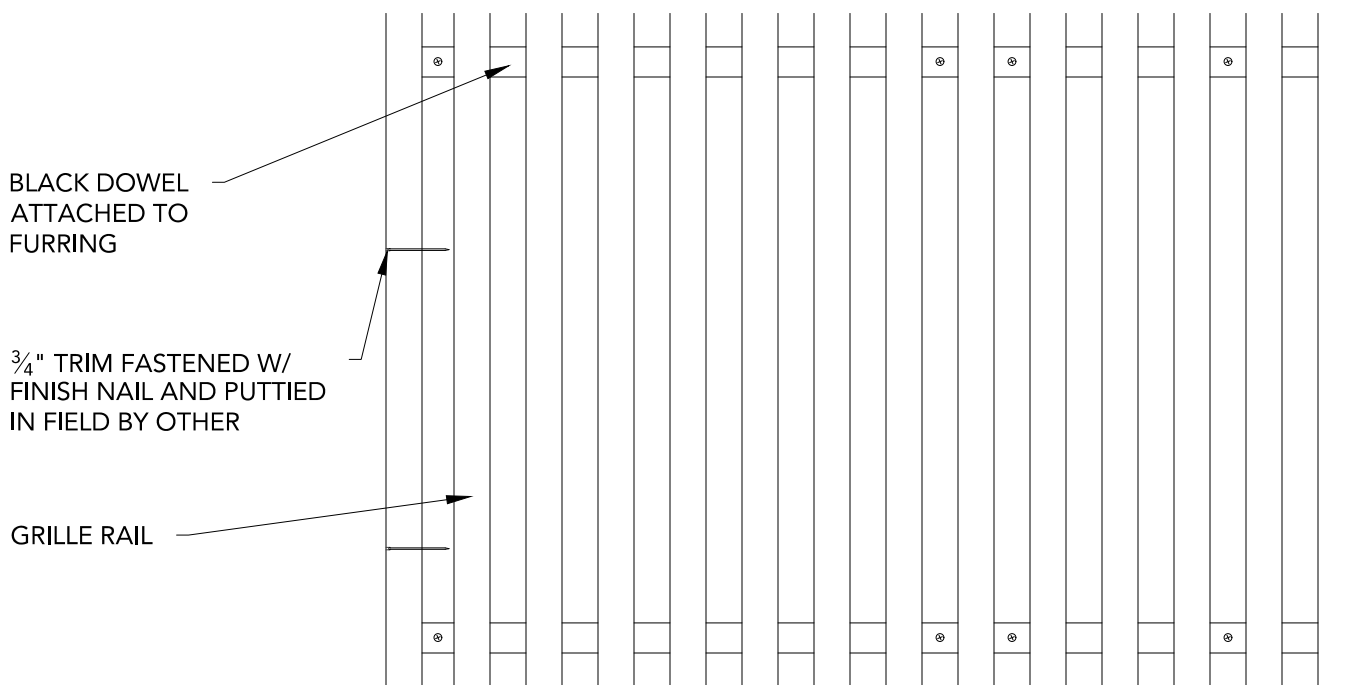

2 VERTICAL WALL ELEVATION @ TRIM

3" = 1'-0"

GRILLE RAIL

BLACK DOWEL ATTACHED TO FURRING

FURRING (BY OTHER) TO
MATCH ACOUSTICAL
BACKER THICKNESS:
PAINTED BLACK IN FIELD

$\frac{1}{2}$ " MIN. REVEAL

BASE AS SCHEDULED (BY OTHER)

2

1

VERTICAL WALL ELEVATION @ BASEBOARD

3" = 1'-0"

TYP. WALL ASSEMBLY (BY OTHER)

FURRING (BY OTHER) TO MATCH
ACOUSTICAL BACKER
THICKNESS: PAINTED BLACK IN
FIELD

BLACK DOWEL ATTACHED TO FURRING

1" ACOUSTICAL BACKER IN BETWEEN
FURRING (2" AVAILABLE)

BASE AS SCHEDULED (BY OTHER)

2

VERTICAL WALL SECTION @ BASEBOARD

3" = 1'-0"


FURRING (BY OTHER) TO MATCH
ACOUSTICAL BACKER
THICKNESS: PAINTED BLACK IN
FIELD

BLACK DOWEL ATTACHED TO FURRING

OUTLET PENETRATION FIELD CUT

GRILLE RAIL

2

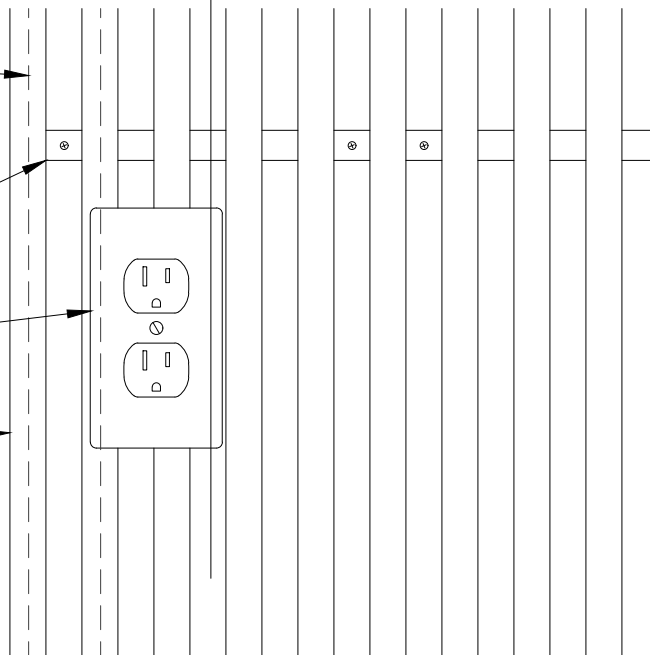

1 VERTICAL WALL ELEVATION @ OUTLET

3" = 1'-0"


TYP. WALL SYSTEM (BY OTHER)

GRILLE RAIL

BLACK DOWEL ATTACHED TO FURRING

LIGHT SWITCH PENETRATION FIELD CUT

1" ACOUSTICAL BACKER (2" AVAILABLE)

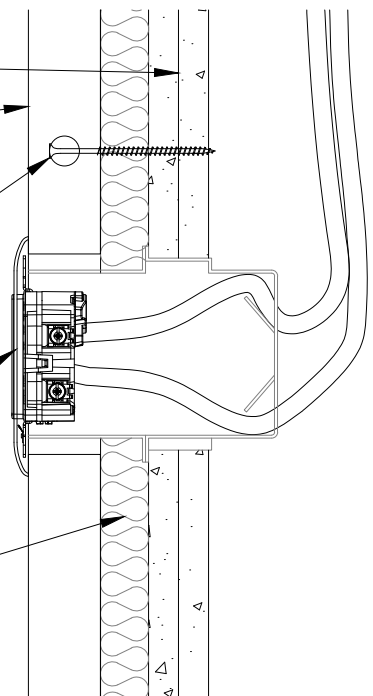

2 VERTICAL WALL SECTION @ OUTLET


3" = 1'-0"

FURRING (BY OTHER) TO MATCH
ACOUSTICAL BACKER THICKNESS:
PAINTED BLACK IN FIELD

BLACK DOWEL ATTACHED TO FURRING

LIGHT SWITCH PENETRATION FIELD CUT

GRILLE RAIL

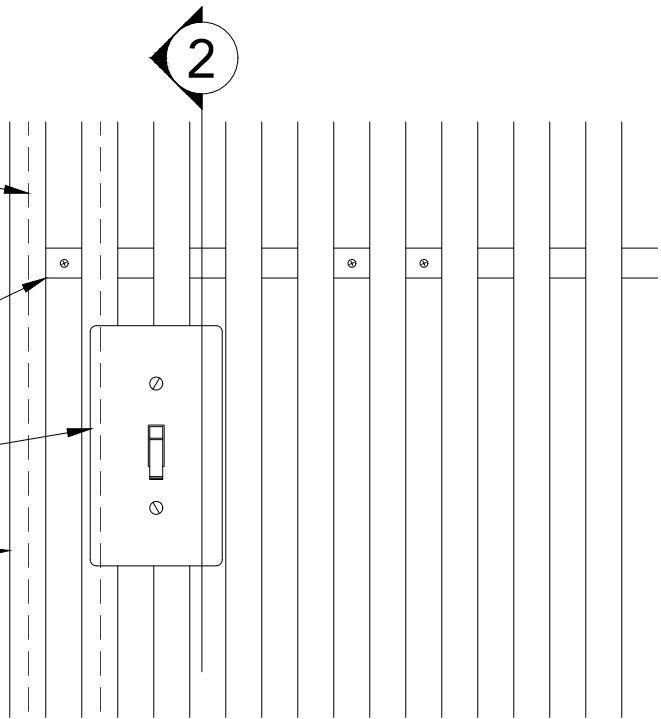

1 VERTICAL WALL ELEVATION @ LIGHT SWITCH

3" = 1'-0"


TYP. WALL SYSTEM (BY OTHER)

GRILLE RAIL

BLACK DOWEL ATTACHED TO FURRING


LIGHT SWITCH PENETRATION FIELD CUT

1" ACOUSTICAL BACKER (2" AVAILABLE)

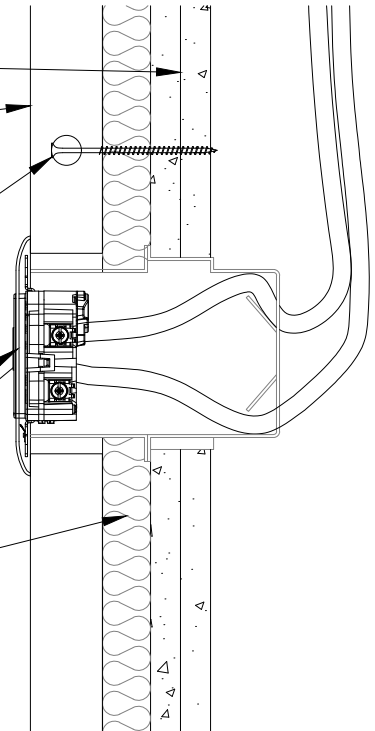


2 VERTICAL WALL SECTION @ LIGHT SWITCH

3" = 1'-0"

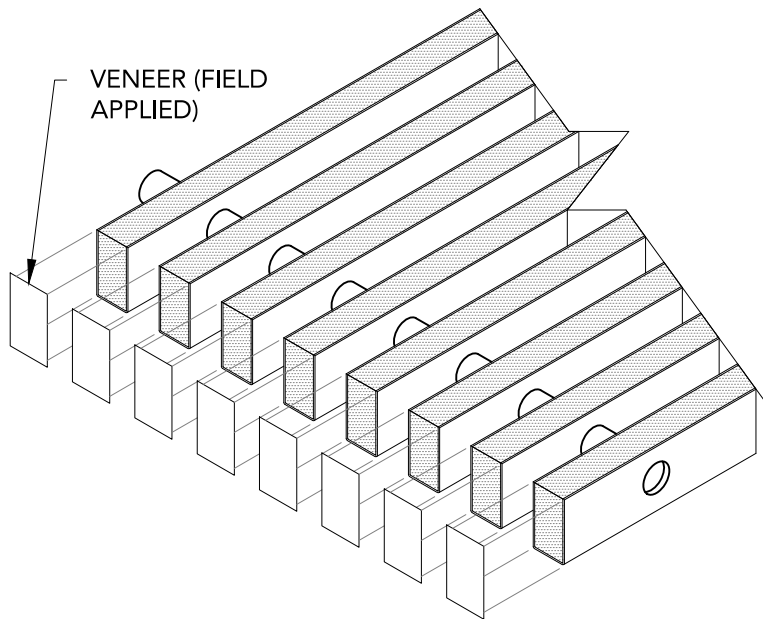


1 STEP 1
3" = 1'-0"

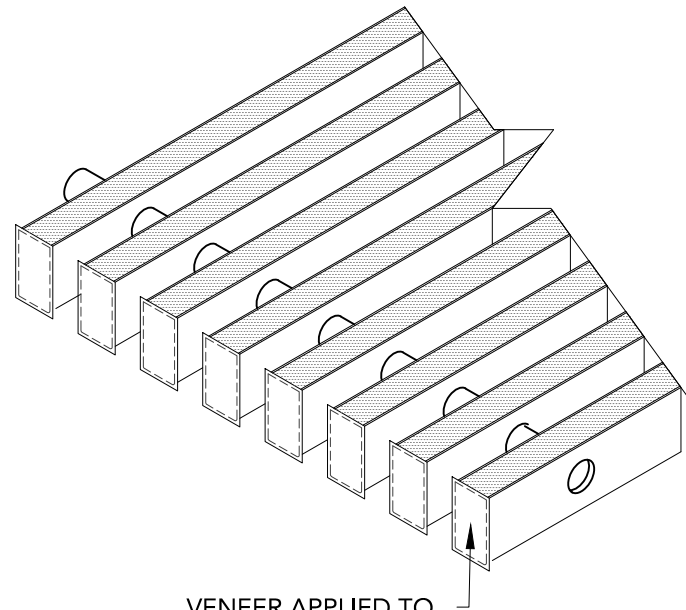

2 STEP 2
3" = 1'-0"

VENEER APPLIED TO
FIELD CUT END W/
HOT MELT & IRON

NOTE: FOR SOLID WOOD RAILS,
NO VENEER NEEDS TO BE
APPLIED - INSTEAD, REFINISH
THE CUT END IN FIELD

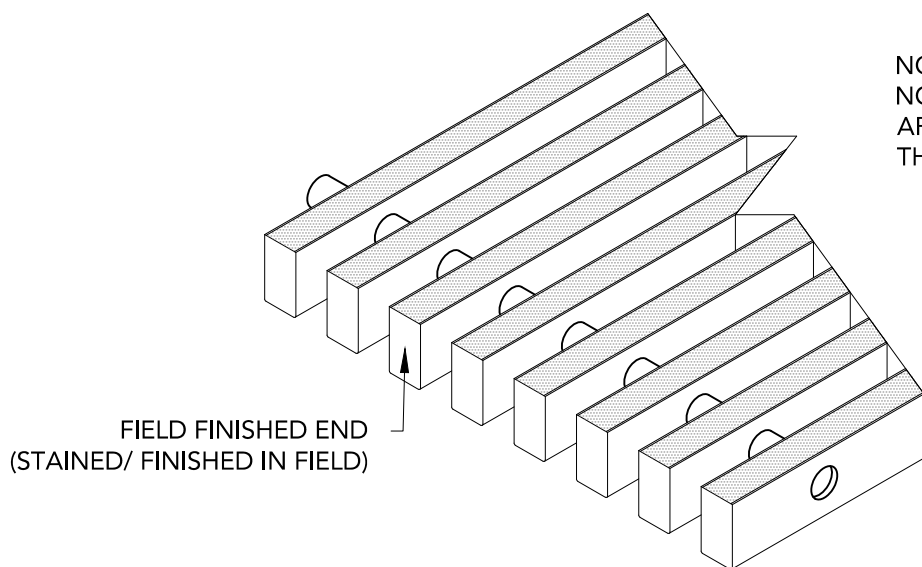

FIELD FINISHED END
(STAINED/ FINISHED IN FIELD)

3 STEP 3
3" = 1'-0"