



* ACOUSTICAL BACKER RECOMMENDED (1" OR 2" OPTIONS)

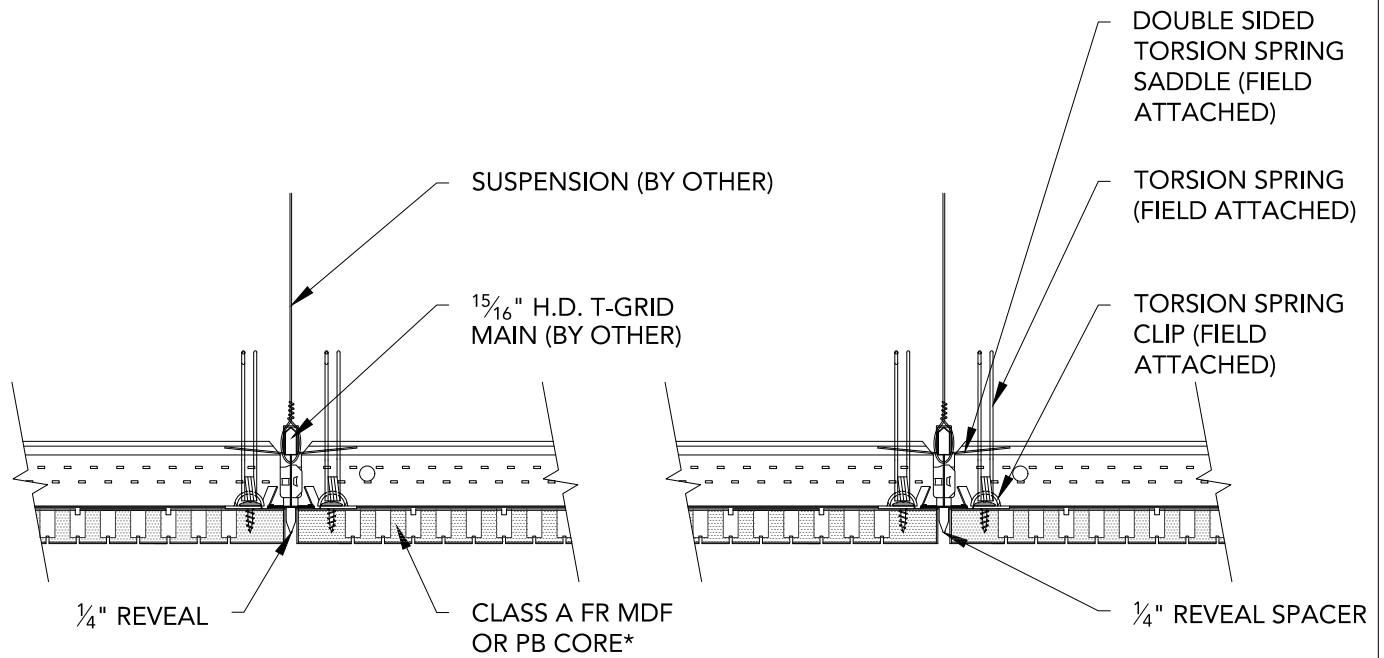

1 TYPICAL SECTION


3" = 1'-0"

NOTE: TORSION CLIPS TO ONLY
BE USED ON GRID MAINS

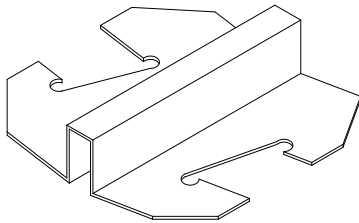


2 TORSION SPRING SADDLE

6" = 1'-0"

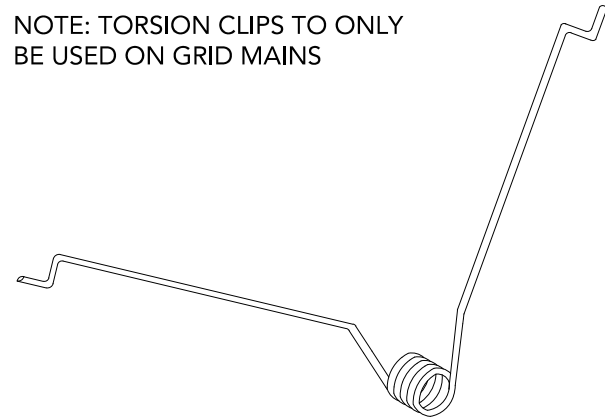


3 TORSION SPRING

6" = 1'-0"

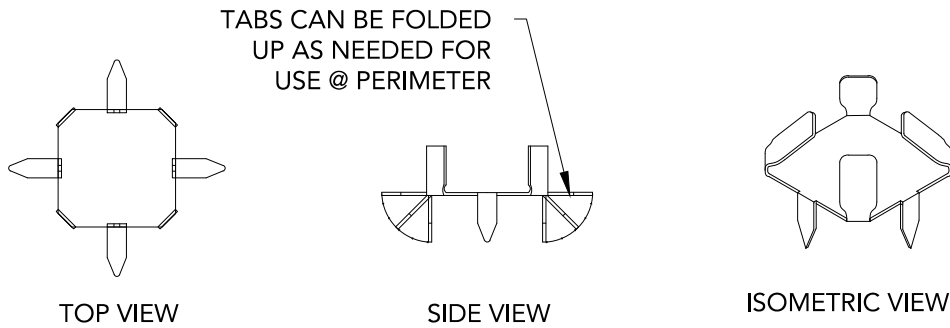


1 1/4" REVEAL SPACER
6" = 1'-0"

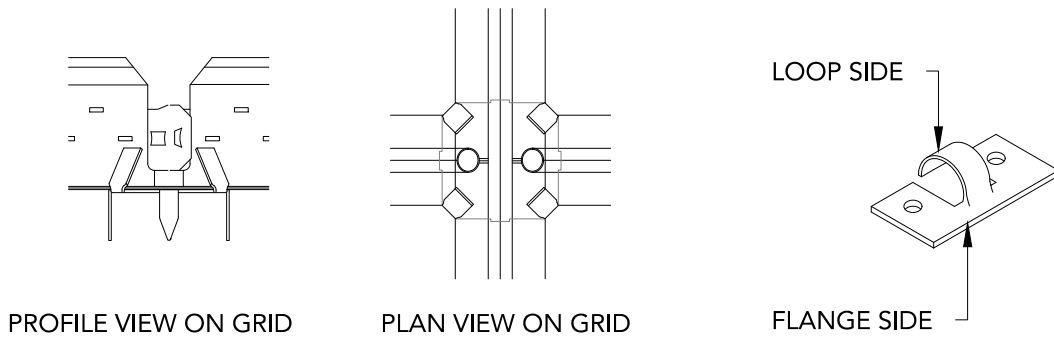

2 1/4" REVEAL SPACER ON GRID
6" = 1'-0"

3 TORSION SPRING CLIP
6" = 1'-0"

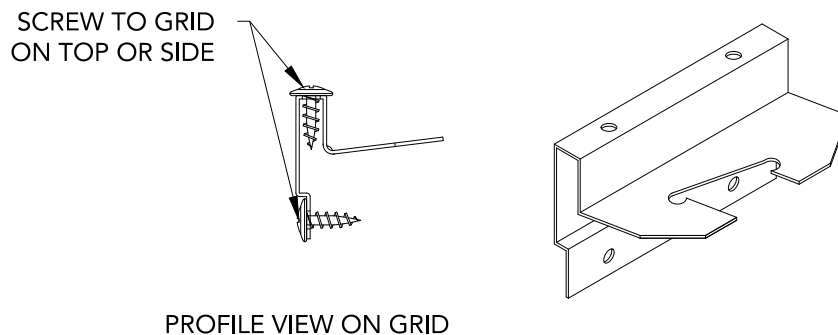

4 SINGLE-SIDED TORSION SPRING SADDLE
6" = 1'-0"


NOTE: TORSION SPRING SADDLES TO
BE ATTACHED TO T-GRID MAINS ONLY

TORSION SPRING (FIELD ATTACHED)

TORSION SPRING CLIP (FIELD ATTACHED)

TORSION SPRING SADDLE (FIELD ATTACHED)

1/4" REVEAL SPACER TYP.
AT CORNERS OF PANEL

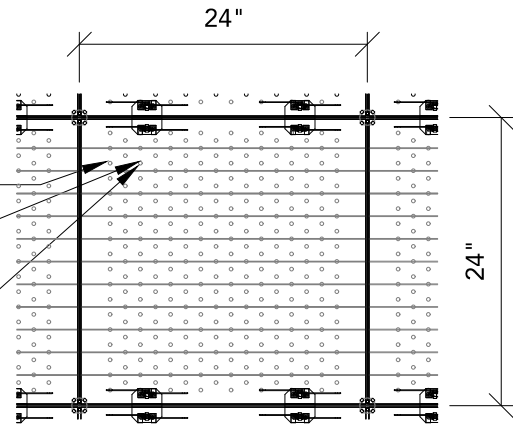

1 TYPICAL 2X2 PANEL PLAN

3/4" = 1'-0"


1/4" REVEAL SPACER TYP.
AT CORNERS OF PANEL

TORSION SPRING CLIP
(FIELD ATTACHED)

TORSION SPRING SADDLE
(FIELD ATTACHED)

SINGLE SIDED SADDLE TO BE
USED IN MIDDLE OF PANEL
(FIELD ATTACHED TO EITHER
SIDE OF T-GRID)

TORSION SPRING
(FIELD ATTACHED)

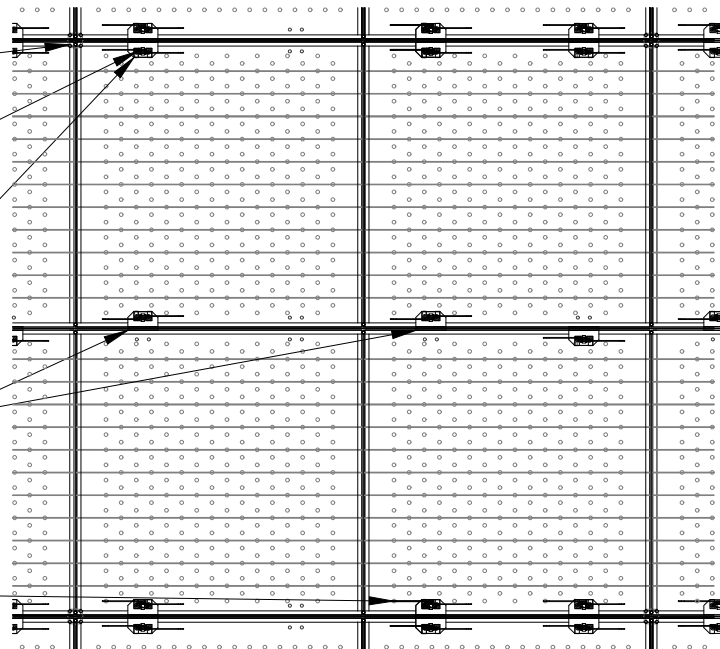

2 TYPICAL 4X4 PANEL PLAN

3/4" = 1'-0"

AUDITION PANEL (TORSION SPRING SYSTEM) - TYPICAL PANEL PLANS

SCALE: AS NOTED

LAST REVISED: 4/23/2018

SHEET NUMBER

3

DRAWN BY: BMH


NOTE: TORSION SPRING SADDLES TO
BE ATTACHED TO T-GRID MAINS ONLY

TORSION SPRING
(FIELD ATTACHED)

TORSION SPRING SADDLE
(FIELD ATTACHED)

TORSION SPRING CLIP
(FIELD ATTACHED)


1/4" REVEAL SPACER TYP.
AT CORNERS OF PANEL

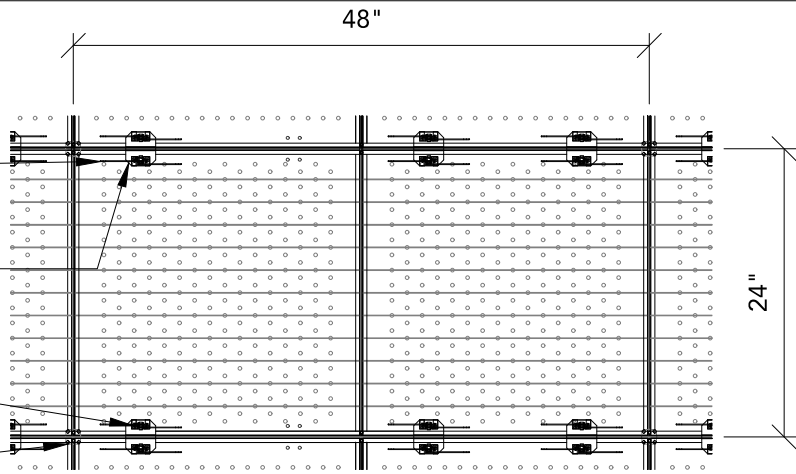

1

TYPICAL 2X4 PANEL PLAN

3/4" = 1'-0"

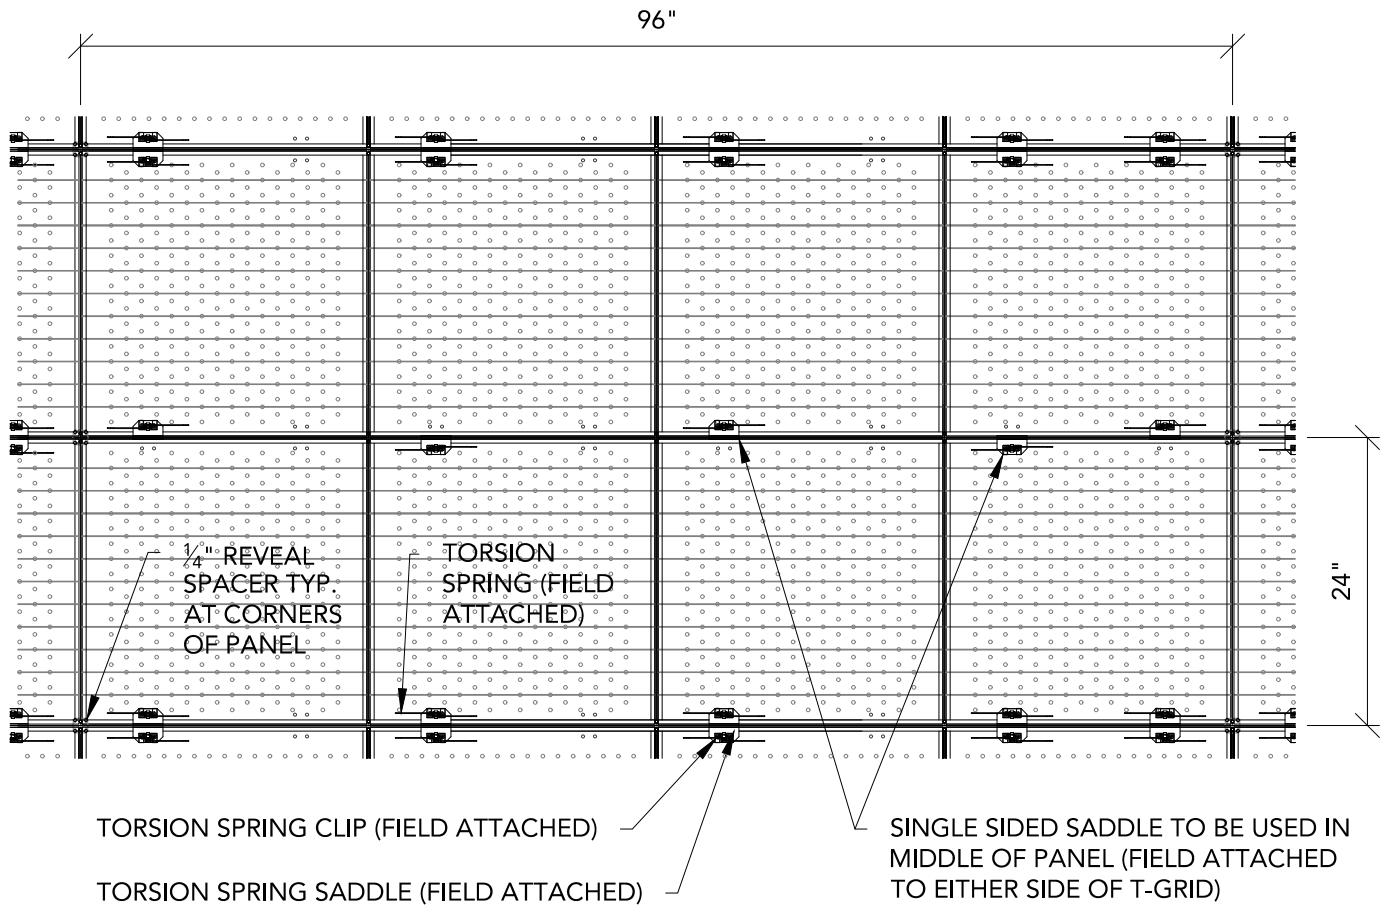


2


TYPICAL 4X8 PANEL PLAN

3/4" = 1'-0"


NOTE: TORSION SPRING SADDLES TO
BE ATTACHED TO T-GRID MAINS ONLY

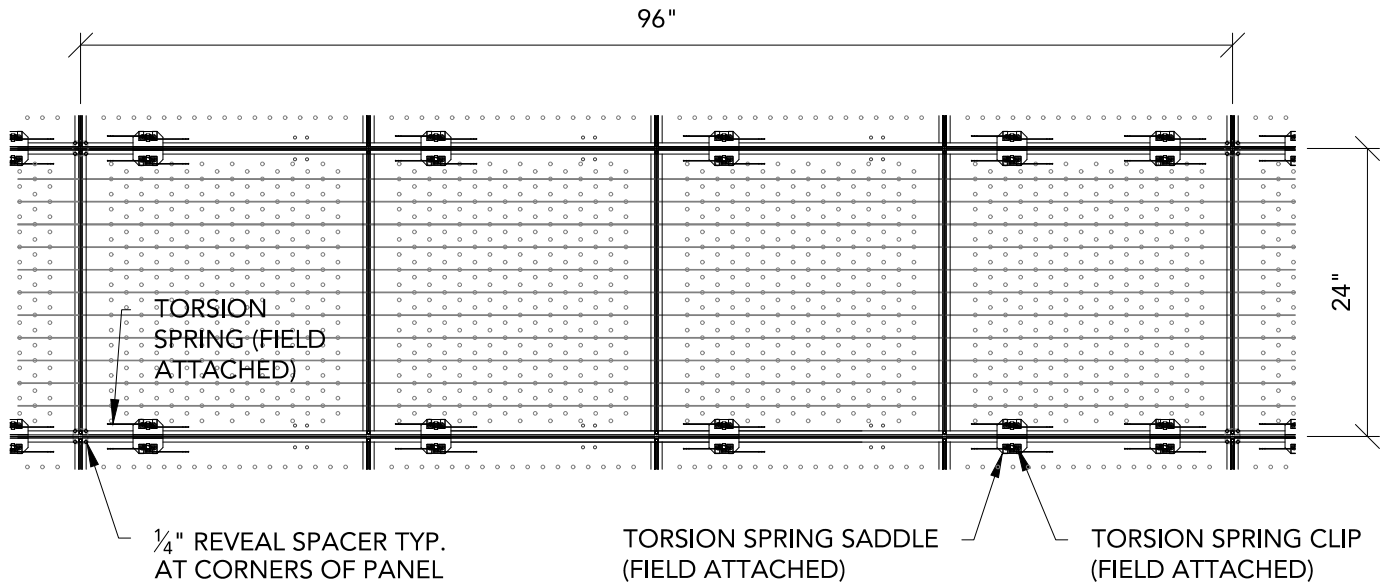

1 TYPICAL 2X8 PANEL PLAN
3/4" = 1'-0"

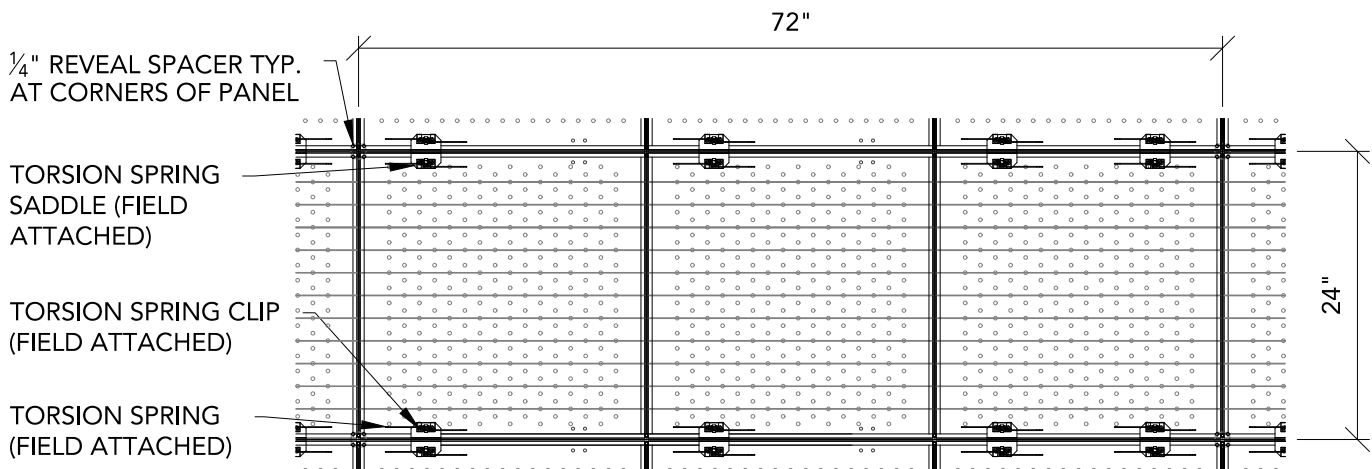

2 TYPICAL 2X6 PANEL PLAN
3/4" = 1'-0"

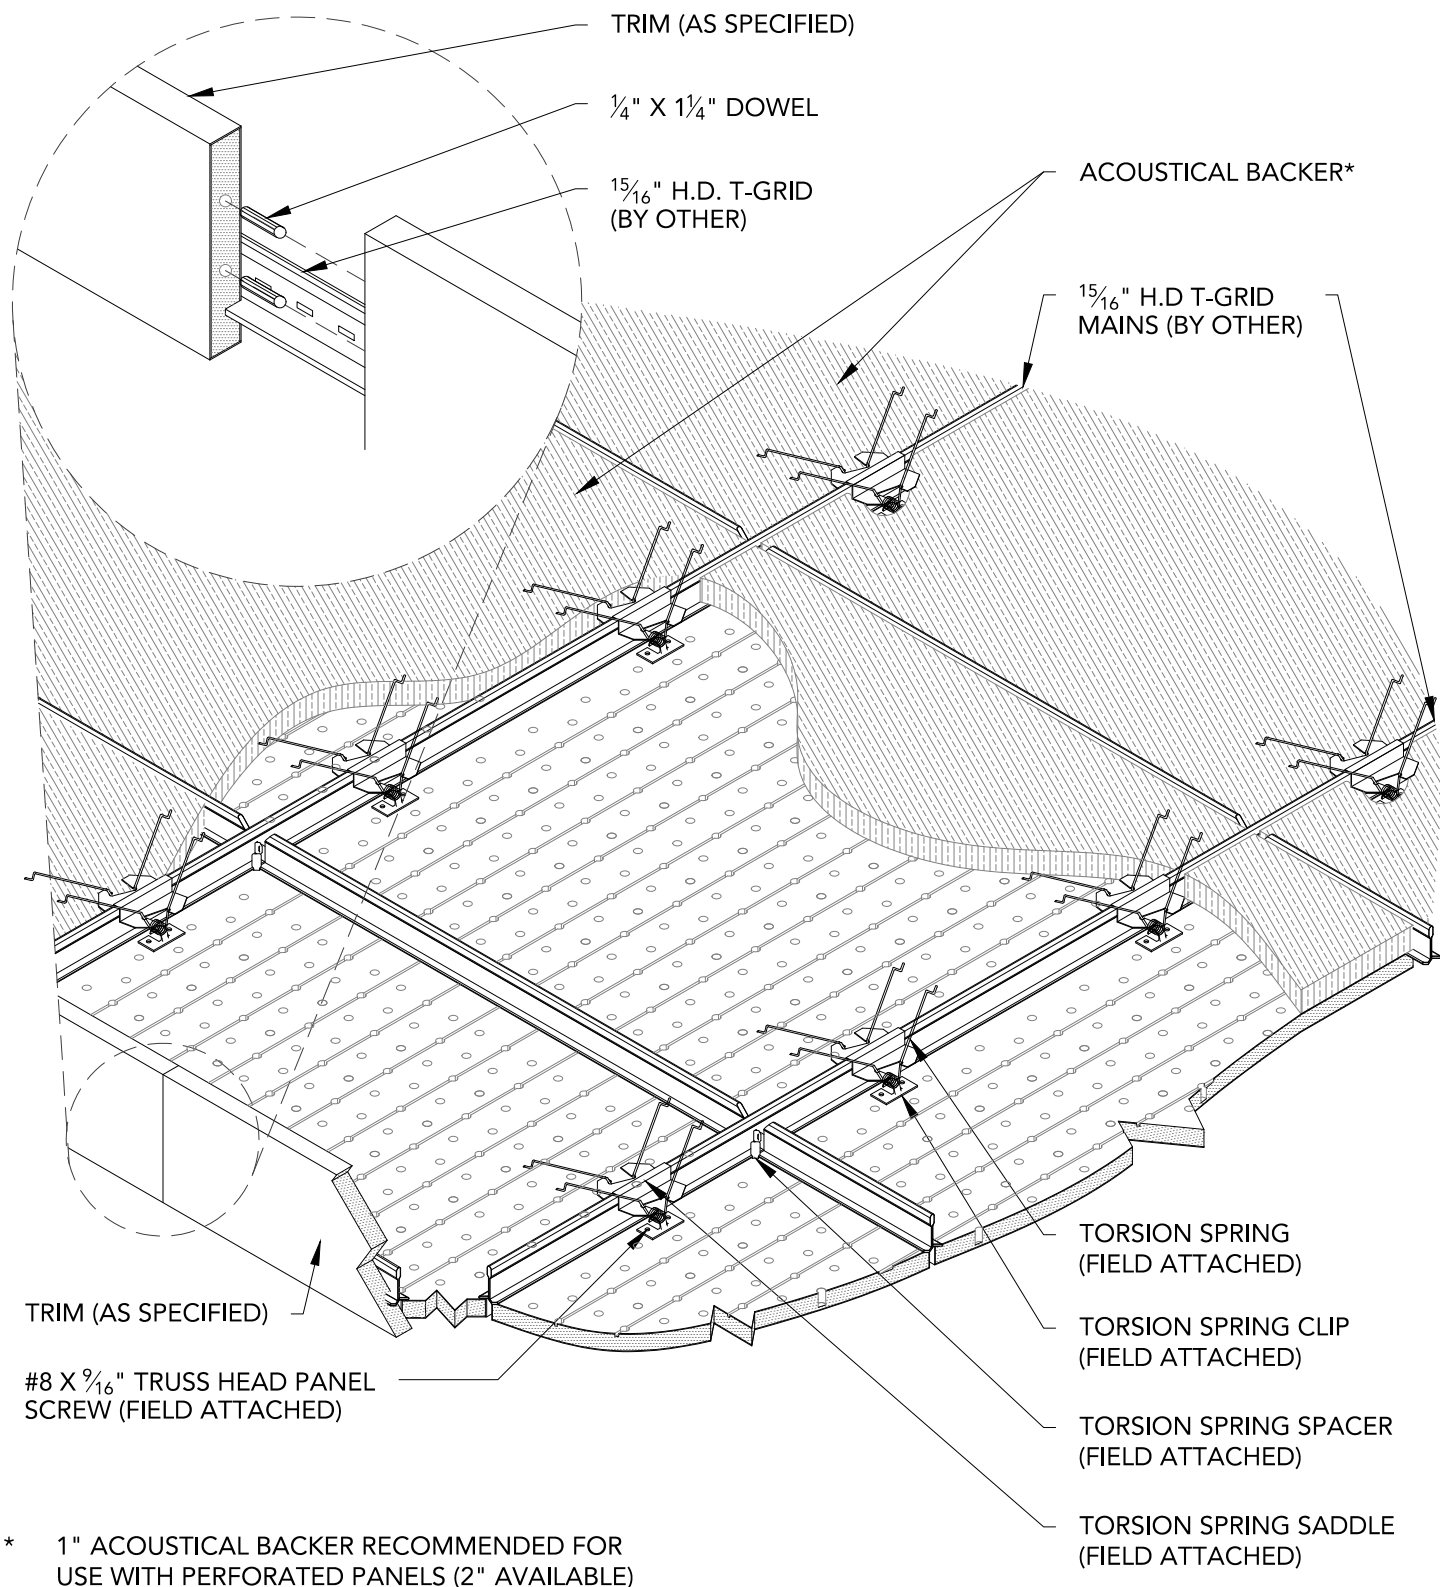


* 1" ACOUSTICAL BACKER RECOMMENDED FOR
USE WITH PERFORATED PANELS (2" AVAILABLE)

1


TYPICAL 2X2 PANEL ISOMETRIC

1 1/2" = 1'-0"

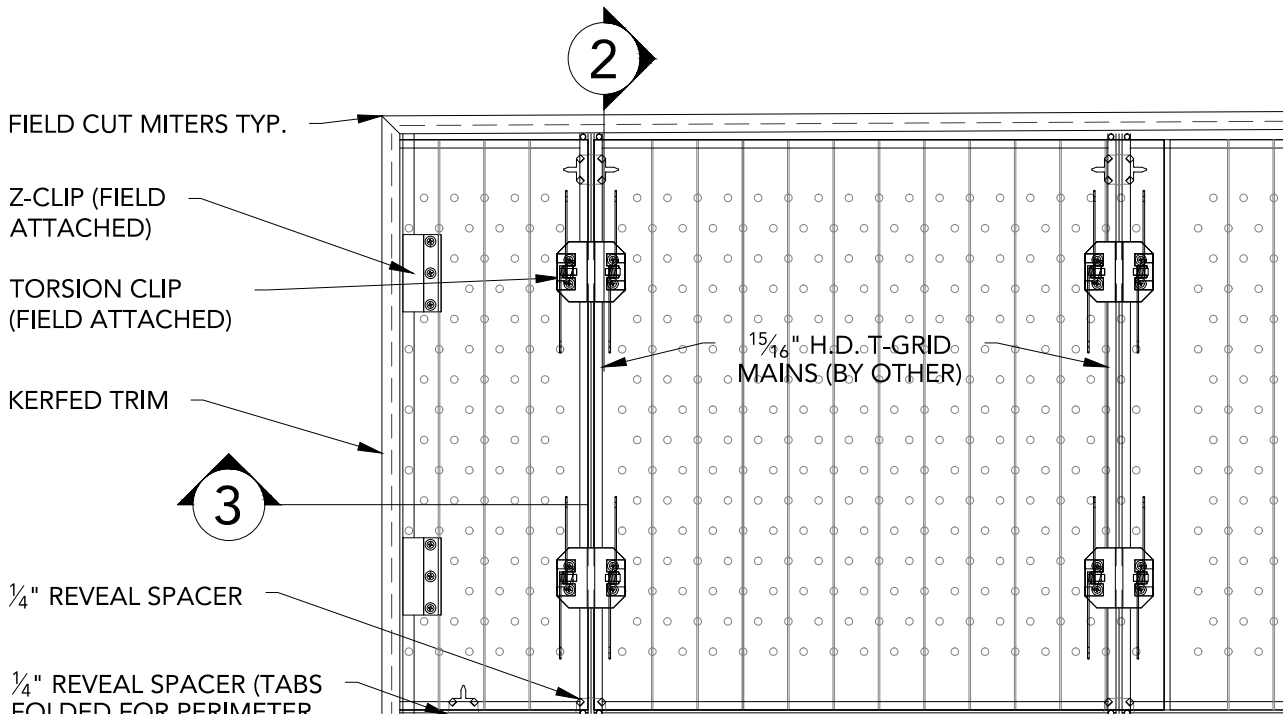


1 TRIM CONDITION PLAN
1 1/2" = 1'-0"

* ACOUSTICAL BACKER RECOMMENDED

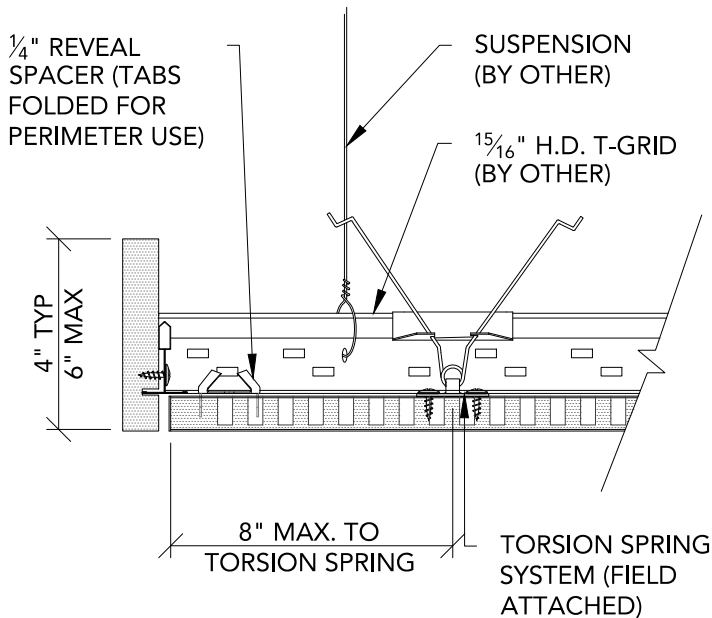


2 PERIMETER CONDITION AT TRIM
3" = 1'-0"

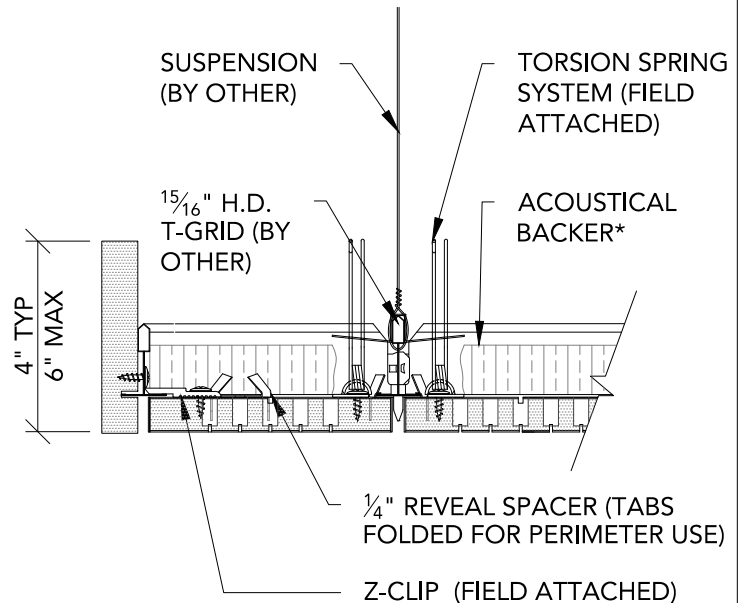


3 PERIMETER CONDITION AT TRIM
3" = 1'-0"

** ALL FIELD CUTS TO ALLOW FOR 1/4" MIN
REVEAL FOR EXPANSION & CONTRACTION

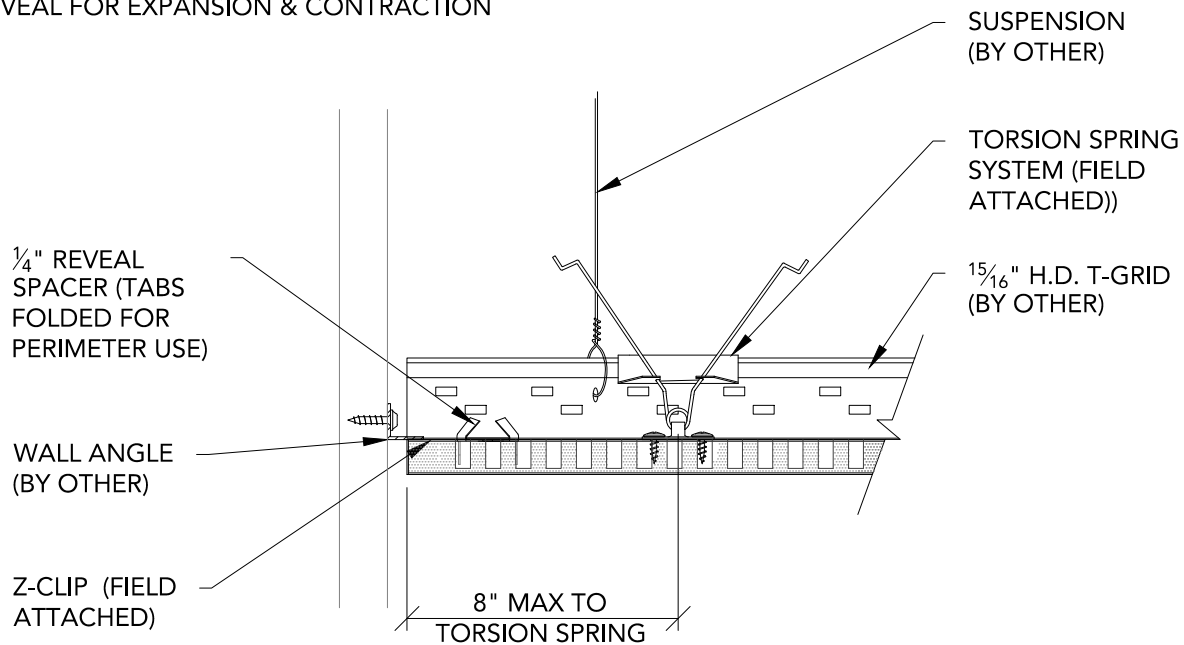

1 PERIMETER CONDITION AT WALL

3" = 1'-0"

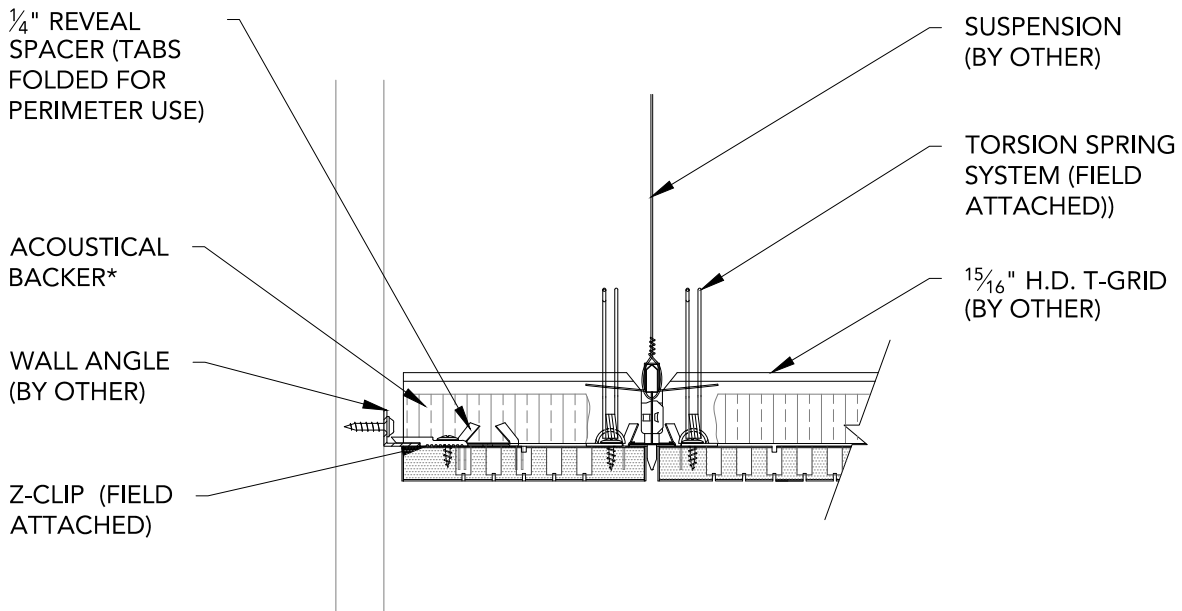

2 PERIMETER CONDITION AT WALL

3" = 1'-0"


1 $\frac{5}{16}$ " H.D. T-GRID
MAINS (BY OTHER)

INDEPENDENTLY
SUPPORTED SPRINKLER
(FIELD CUT PENETRATION)

2

TORSION SPRING
SYSTEM (FIELD
ATTACHED)

$\frac{1}{4}$ " REVEAL SPACER

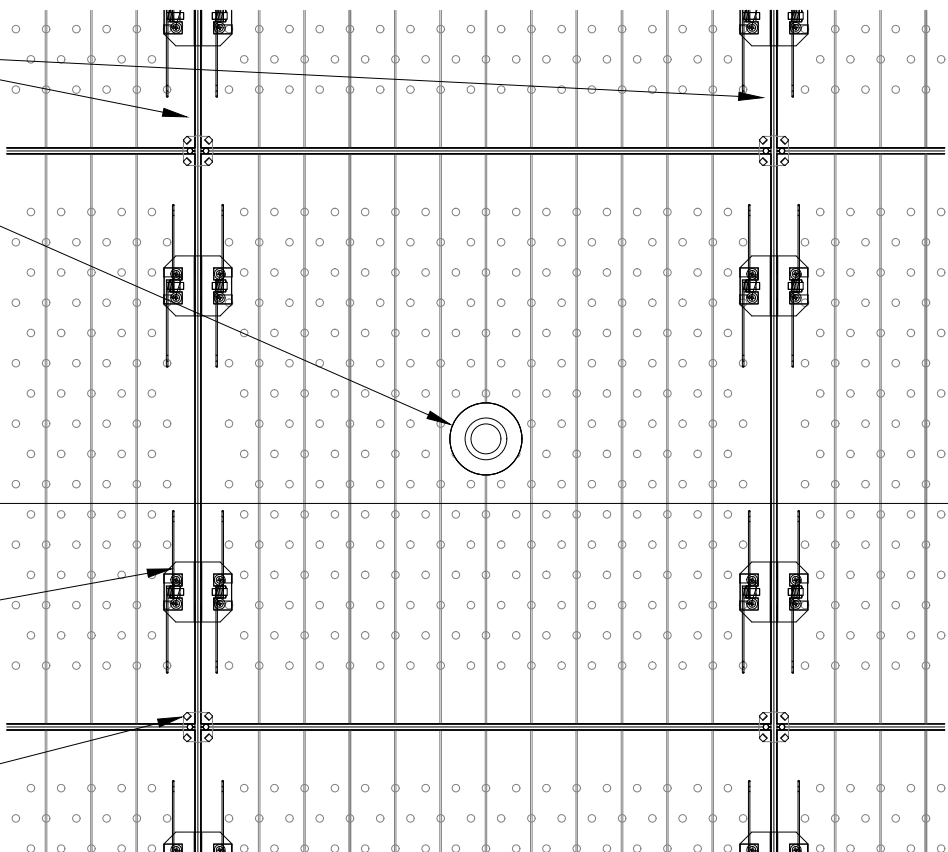

1 SPRINKLER PLAN


1 1/2" = 1'-0"

SUSPENSION (BY OTHER)

1 $\frac{5}{16}$ " H.D. T-GRID (BY OTHER)

TORSION SYSTEM
(FIELD ATTACHED)

FIELD CUT
PENETRATION

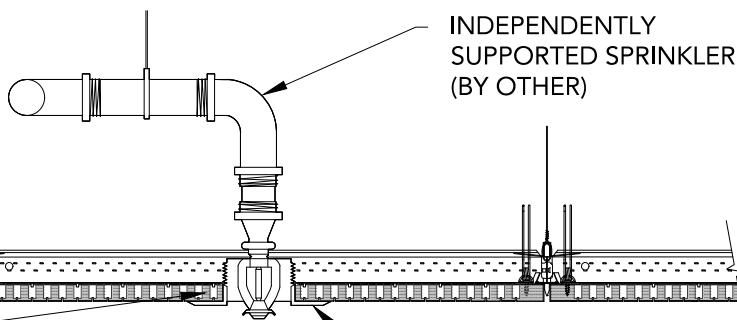

TRIM RING (BY OTHER)

2 SPRINKLER SECTION

1 1/2" = 1'-0"

AUDITION PANEL (TORSION SPRING SYSTEM) - SPRINKLER HEAD DETAIL

SCALE: AS NOTED

LAST REVISED: 4/23/2018

SHEET NUMBER

9

DRAWN BY: BMH


15/16" H.D. T-GRID
MAINS (BY OTHER)

INDEPENDENTLY
SUPPORTED CAN LIGHT
(FIELD CUT PENETRATION)

2

TORSION SPRING
SYSTEM (FIELD
ATTACHED)

1/4" REVEAL SPACER

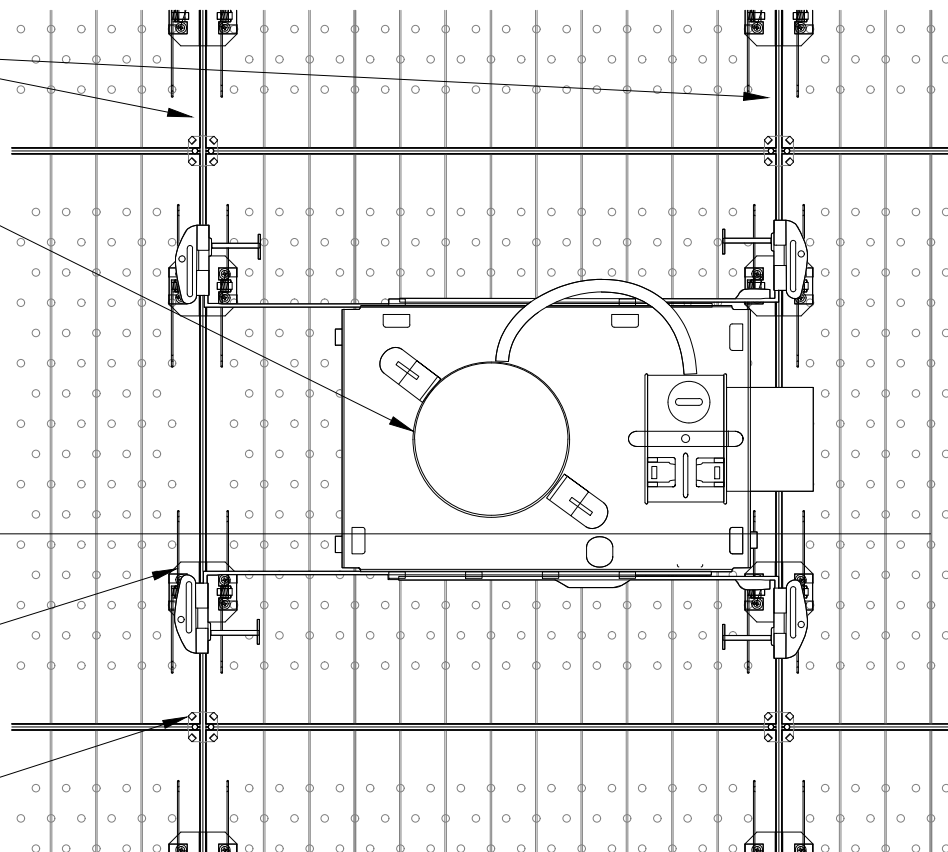

1

CAN LIGHT PLAN

1 1/2" = 1'-0"

SUSPENSION (BY OTHER)


15/16" H.D. T-GRID (BY OTHER)

TORSION SYSTEM
(FIELD ATTACHED)

FIELD CUT
PENETRATION

INDEPENDENTLY
SUPPORTED CAN LIGHT
(BY OTHER)

TRIM RING
(BY OTHER)

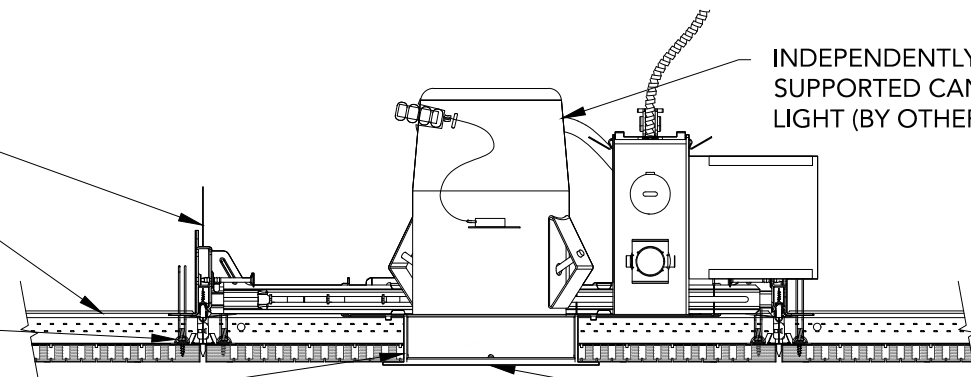

2

CAN LIGHT SECTION

1 1/2" = 1'-0"


15/16" H.D. T-GRID
MAINS (BY OTHER)

INDEPENDENTLY
SUPPORTED PENDANT
LIGHT (FIELD CUT
PENETRATION)

TORSION SPRING
SYSTEM (FIELD
ATTACHED)



1/4" REVEAL SPACER

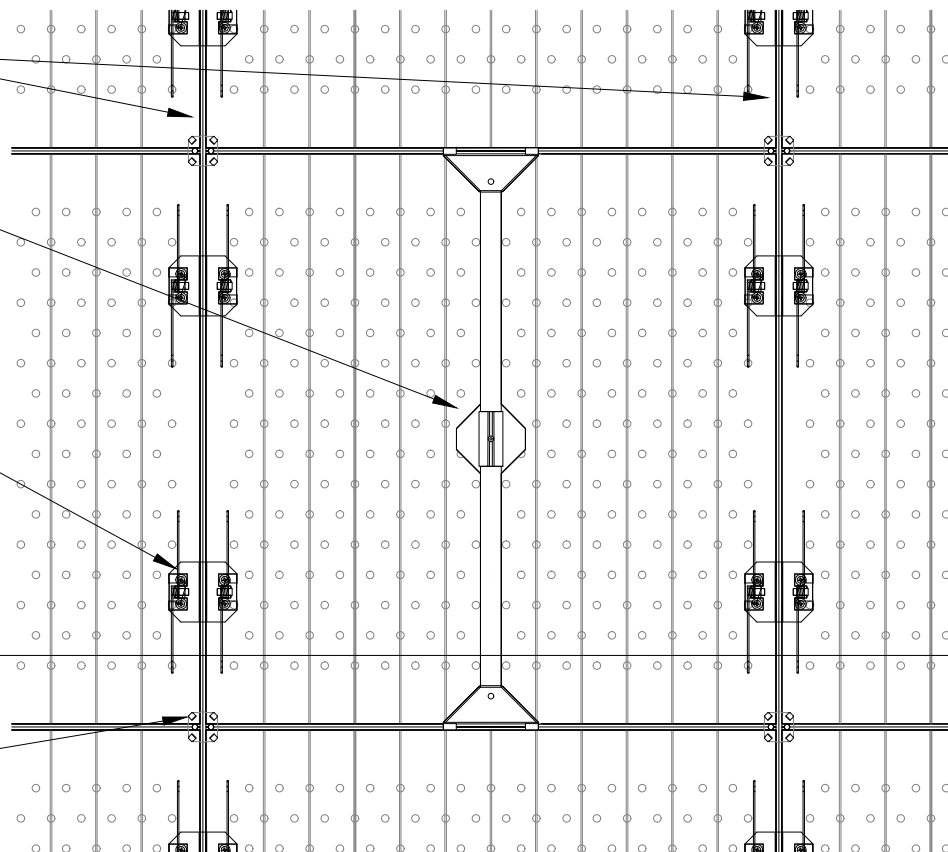

1 PENDANT LIGHT PLAN

1 1/2" = 1'-0"

SUSPENSION (BY OTHER)


15/16" H.D. T-GRID (BY OTHER)

TORSION SYSTEM
(FIELD ATTACHED)

FIELD CUT
PENETRATION

INDEPENDENTLY
SUPPORTED PENDANT
LIGHT (BY OTHER)

TRIM PLATE (BY OTHER)

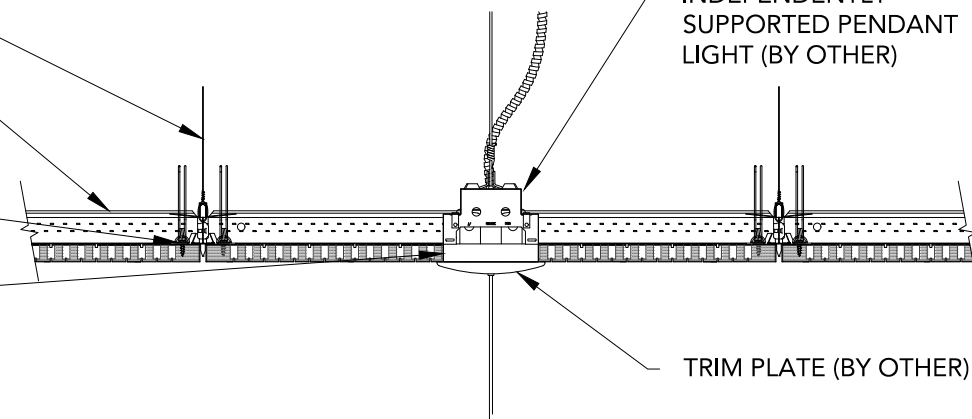

2 PENDANT LIGHT SECTION

1 1/2" = 1'-0"


15/16" H.D. T-GRID
MAINS (BY OTHER)

INDEPENDENTLY
SUPPORTED SPEAKER
(FIELD CUT PENETRATION)

TORSION SPRING
SYSTEM (FIELD
ATTACHED)



1/4" REVEAL SPACER

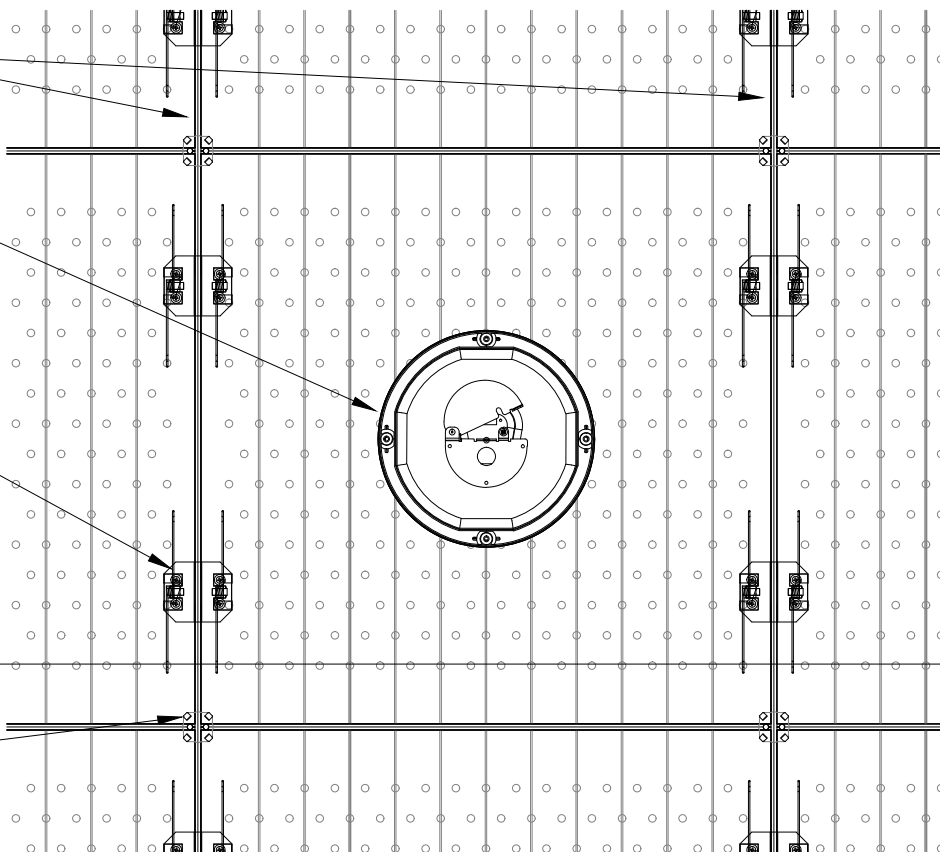

1

RECESSED SPEAKER PLAN

1 1/2" = 1'-0"

SUSPENSION (BY OTHER)


15/16" H.D. T-GRID (BY OTHER)

TORSION SYSTEM
(FIELD ATTACHED)

FIELD CUT
PENETRATION

INDEPENDENTLY
SUPPORTED SPEAKER
(BY OTHER)

TRIM PLATE (BY OTHER)

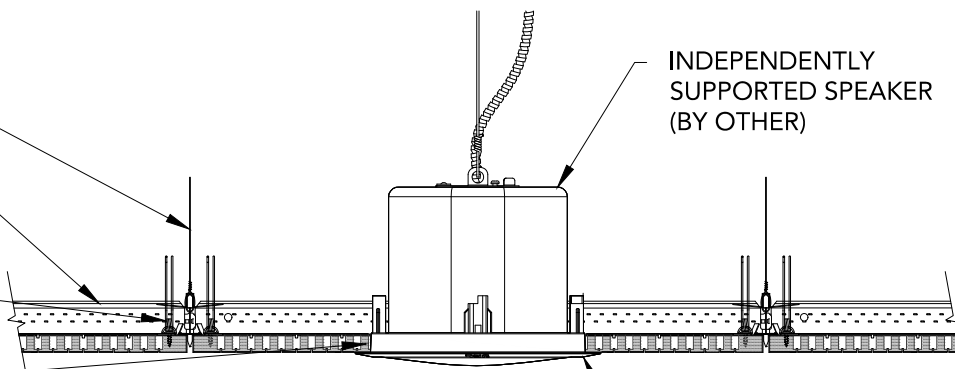

2

RECESSED SPEAKER SECTION

1 1/2" = 1'-0"


15/16" H.D. T-GRID
MAINS (BY OTHER)

INDEPENDENTLY
SUPPORTED DIFFUSER
(FIELD CUT PENETRATION)

TORSION SPRING
SYSTEM (FIELD
ATTACHED)

2

1/4" REVEAL SPACER

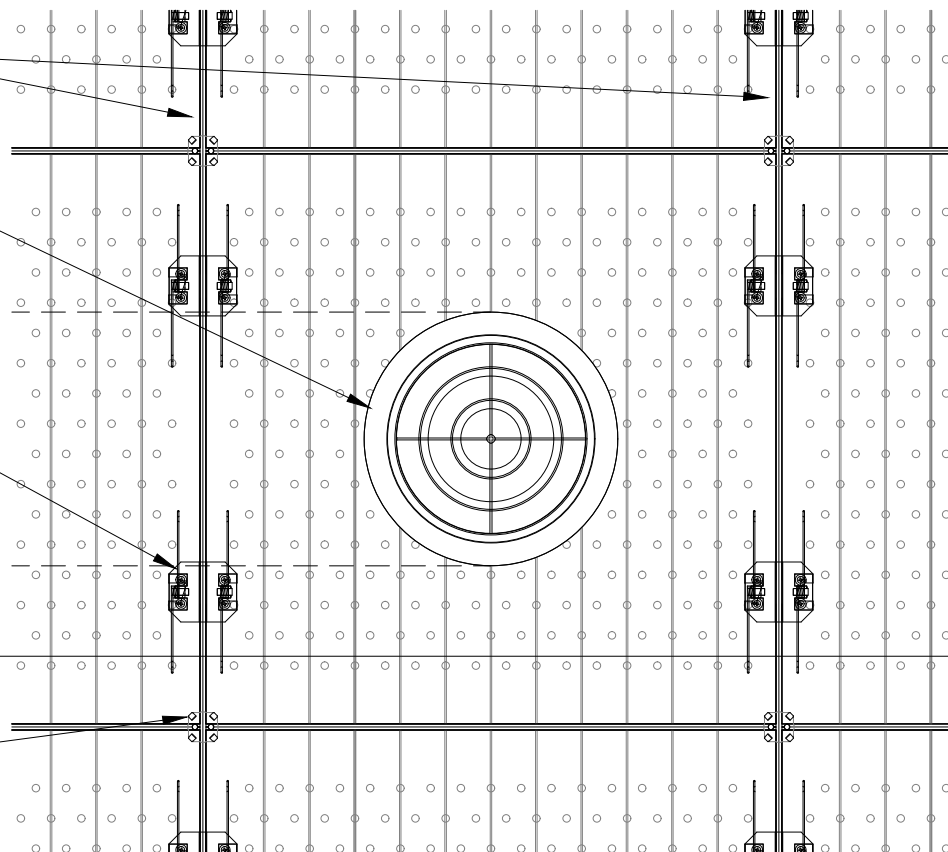

1

DIFFUSER PLAN

1 1/2" = 1'-0"

SUSPENSION (BY OTHER)


15/16" H.D. T-GRID (BY OTHER)

TORSION SYSTEM
(FIELD ATTACHED)

FIELD CUT
PENETRATION

INDEPENDENTLY
SUPPORTED DUCT
WORK (BY OTHER)

INDEPENDENTLY
SUPPORTED DIFFUSER
(FIELD CUT PENETRATION)

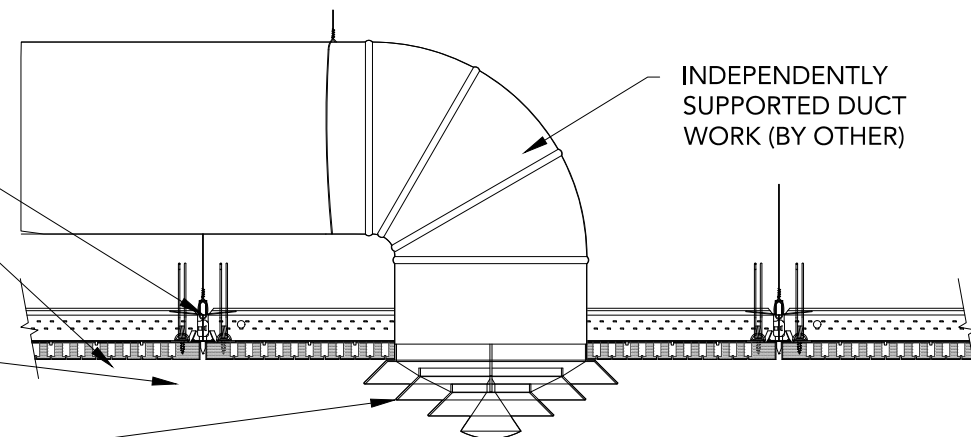

2

DIFFUSER SECTION

1 1/2" = 1'-0"